Department of Transportation

LARGE CULVERT REPLACEMENTS AT MULTIPLE LOCATIONS **CONTRACT 6 - SITES 13, 14, 15 AND MOHAWK RIVER TRAIL**

> **PIN 2LC1.31** D265553

TOWNS OF AVA AND CITY OF ROME, ONEIDA COUNTY TOWN OF GEORGETOWN, MADISON COUNTY

F.A. PROJECT



PROJECT SITES (SEE DWG. LM-OI FOR DETAILED SITE LOCATIONS)

CEPTIFICATION

RECOMMENDED BY REGIONAL CONSTRUCTION ENGINEER

Michael & Pawloske 6/24/25 REGIONAL DIRECTOR OF OPERATIONS

RECOMMENDED BY REGIONAL TRAFFIC ENGINEER WICHAEL GALLERANI, P.E.

APPROVED BY LINDA LUBEY, P.E.

APPROVED BY

JEFFREY M. LA

SITE 15 THRT (SWEETS NO. 13-16, 18-23, 68-95)

THE LATEST REVISIONS OF THE STANDARD SHEETS MAINTAINED BY THE DEPARTMENT, WHICH ARE CURRENT AS OF THE STANDARD SPECIFICATIONS ADOPTION DATE SHOWN ON THE PROPOSAL COVER, SHALL BE CONSIDERED TO BE IN EFFECT, ALL PAY ITEMS AND WORK CONTAINED IN THE CONTRACT AND ANY ADDITIONAL PAY ITEMS AND WORK ENCOUNTERED DURING THE CONTRACT AND ANY CONTRACT SHALL BE SUBJECT TO THE APPLICABLE STANDARD SHEETISI UNLESS DIRERWISE SPECIFIED IN THE CONTRACT DOCUMENTS.

ALL BORK CONTEMPLATED LINDER THIS CONTRACT IS TO BE COVERED BY AND IN CONFORMITY BITH THE STANDARD SPECIFICATIONS US CUSTOMARTY REFERENCED IN THE CONTRACT PROJECT "PROPOSAL" EXCEPT AS MODIFIED BY THESE PLANS OR BY CHANGES SET FORTH IN THE CONTRACT PROJECT "PROPOSAL."

CONTRACT PLANS HAVE BEEN DESIGNED IN ACCORDANCE BITH NYSOOT POLICIES AND GUIDELINES AND THE FRMAL DESIGN REPORT APPROVED ON 10/30/2024 FOR PIN 2LC1.31 CULVERIS C270037, C240033, AND C270026, FINAL DESIGN APPROVED ON 5/15/2020 FOR MONARY RIVER TRAIL 6877 AND CULVERI C260199.









SH: 1355, 339, 5	562	
AVA, GEORGETOW	N, CITY OF ROM	E
COUNTIES: ONEID	A, MADISON	
COUNTIES: ONE ID		SHEET NO
COUNTIES: ONEID FED. ROAD REG. NO.		SHEET NO

INDEX ON SHEET NO. 2 D265553

RECOMMENDED BY REGIONAL DESIGN ENGINEE

COSTIST

CHRISTOPHER LANGETT, P.E.

QUALITY CONTROLLED BY:

DAVID SADEKOSKI, P.E.

David Sadekook 6/24/25

RECOMMENDED BY

MICHAEL PARLOSKI, P.E.

BRIAN HOFFMANN, P.E. D265553

D265553

CONTRACTOR'S NAME

COMPLETION DATE

REGIONAL DIRECTOR ENGINEER IN CHARGE FIRAL COST TOTAL

FINAL ACCEPTANCE DATE

FISCAL SHARE

STATE OF NEW YORK REGICNS & LOCATIONS OF REGIONAL COP UES AND MENT OF A OF 19415PG91411C1

	ALIGNMENT	TOPO	GRAPHY (M	ISCELLANE
ABBR.	DESCRIPTION	ABBR.	DESCRIPTION)N
AH	AHEAD	ABUT	ABUTMENT	
ΑZ	AZIMUTH	AOBE	AS ORDERED	BY ENGINEE
BK	BACK	ASPH	ASPHAL T	
Æ	BASELINE	BDY	BOUNDARY	
BRG	BEARING	BLDG		
<u>Ç</u>	CENTERLINE	BM	BENCH MARK	
CS	CURVE TO SPIRAL	CC	CENTER TO	CENTER
EQ.	SUPERELEVATION RATE (CROSS SLOPE) EQUALITY	CONC)N
EXT	EXTERNAL	CR		
HCL	HORIZONTAL CONTROL LINE	D	DEED DISTAL	
HSD	HEADLIGHT SIGHT DISTANCE	DM	DIRECT MEA	
L	LENGTH OF CIRCULAR CURVE	DWY		
LS	LENGTH OF SPIRAL	EP	EDGE OF PA	VEMENT
LVC	LENGTH OF VERTICAL CURVE	ES	EDGE OF SH	
E	CENTER CORRECTION OF VERTICAL CURVE	FEE	FEE ACQUIS	
M	MAIN LINE	FEE WO/A		TION WITHOU
PC	POINT OF CURVATURE	FP		
PI	POINT OF INTERSECTION	FD		
POL	POINT ON LINE PASSING SIGHT DISTANCE	FL	FENCE LINE	
PSD PT	PASSING SIGHT DISTANCE POINT OF TANGENT	GAR	GARAGE	
PVC	POINT OF TANGENT POINT OF VERTICAL CURVE	GR HO	GRAVEL HOUSE	
PVI	POINT OF VERTICAL CORVE	HWY		
PVT	POINT OF VERTICAL TANGENT	IP.		IRON PIPE
R	RADIUS	MB		1
SC	SPIRAL TO CURVE	MON		
SSD	STOPPING SIGHT DISTANCE	N&W		ASHER
ST	SPIRAL TO TANGENT	OG	ORIGINAL GR	OUND
STA	STATION	0/H	OVERHEAD	
T	TANGENT LENGTH	Р	PARCEL	
TGL	THEORETICAL GRADE LINE	PAV'T	PAVEMENT	
TS	TANGENT TO SPIRAL	PE	PERMANENT	
VC	VERTICAL CURVE	PED POLE		
	TOPOGRAPHY (DRAINAGE)	<u>P</u>	PROPERTY L	INE
ABBR.	DESCRIPTION	POR	PORCH	
BB	BOTTOM OF BANK (STREAM)	RR RTE	RAILROAD ROUTE	
BC	BOTTOM OF CURB	ROW		A Y
BO	BOTTOM OF OPENING	RW		
CAP	CORRUGATED ALUMINUM PIPE	SH		
СВ	CATCH BASIN	SHLDR	SHOULDER	
CIP	CAST IRON PIPE	SPK		
STRM	CENTERLINE OF STREAM	ST	STREET	
CHD	CORRUGATED METAL PIPE	STK	STAKE	
CMP				
СР	CONCRETE PIPE	STY	STORY	
		SW	SIDEWALK	
CP CSP CUL V	CONCRETE PIPE CORRUGATED STEEL PIPE CULVERT	SW TE	SIDEWALK TEMPORARY	
CP CSP CUL V DIA	CONCRETE PIPE CORRUGATED STEEL PIPE CULVERT DIAMETER	SW TE TO	SIDEWALK TEMPORARY TEMPORARY	OCCUPANCY
CP CSP CUL V DIA DMH	CONCRETE PIPE CORRUGATED STEEL PIPE CULVERT DIAMETER DRAINAGE MANHOLE	SW TE TO U/G	SIDEWALK TEMPORARY TEMPORARY UNDERGROUN	OCCUPANCY
CP CSP CUL V DIA DMH DS	CONCRETE PIPE CORRUGATED STEEL PIPE CULVERT DIAMETER DRAINAGE MANHOLE DRAINAGE STRUCTURE PIPE	SW TE TO	SIDEWALK TEMPORARY TEMPORARY	OCCUPANCY
CP CSP CUL V DIA DMH DS D'XING	CONCRETE PIPE CORRUGATED STEEL PIPE CULVERT DIAMETER DRAINAGE MANHOLE DRAINAGE STRUCTURE PIPE DITCH CROSSING	SW TE TO U/G	SIDEWALK TEMPORARY TEMPORARY UNDERGROUN	OCCUPANCY
CP CSP CULV DIA DMH DS D'XING EHW	CONCRETE PIPE CORRUGATED STEEL PIPE CULVERT DIAMETER DRAINAGE MANHOLE DRAINAGE STRUCTURE PIPE DITCH CROSSING EXTREME HIGH WATER	SW TE TO U/G	SIDEWALK TEMPORARY TEMPORARY UNDERGROUN	OCCUPANCY D
CP CSP CUL V DIA DMH DS D'XING EHW EL	CONCRETE PIPE CORRUGATED STEEL PIPE CULVERT DIAMETER DRAINAGE MANHOLE DRAINAGE STRUCTURE PIPE DITCH CROSSING EXTREME HIGH WATER ELEVATION	SW TE TO U/G	SIDEWALK TEMPORARY TEMPORARY UNDERGROUN WING WALL	OCCUPANCY D ITEM PA
CP CSP CUL V DIA DMH DS D'XING EHW EL	CONCRETE PIPE CORRUGATED STEEL PIPE CULVERT DIAMETER DRAINAGE MANHOLE DRAINAGE STRUCTURE PIPE DITCH CROSSING EXTREME HIGH WATER ELEVATION	SW TE TO U/G	SIDEWALK TEMPORARY TEMPORARY UNDERGROUN WING WALL STANDARD	OCCUPANCY D ITEM PA' ESTIMATI
CP CSP CUL V DIA DMH DS D'XING EHW EL ELEV ELW	CONCRETE PIPE CORRUGATED STEEL PIPE CULVERT DIAMETER DRAINAGE MANHOLE DRAINAGE STRUCTURE PIPE DITCH CROSSING EXTREME HIGH WATER ELEVATION EXTREME LOW WATER	SW TE TO U/G	SIDEWALK TEMPORARY TEMPORARY UNDERGROUN WING WALL STANDARD SYMBOL	OCCUPANCY D ITEM PA ESTIMATI QUANTITI
CP CSP CULV DIA DMH DS D'XING EHW EL ELEV ELW	CONCRETE PIPE CORRUGATED STEEL PIPE CULVERT DIAMETER DRAINAGE MANHOLE DRAINAGE STRUCTURE PIPE DITCH CROSSING EXTREME HIGH WATER ELEVATION ELEVATION EXTREME LOW WATER END SECTION	SW TE TO U/G	SIDEWALK TEMPORARY TEMPORARY UNDERGROUN WING WALL STANDARD SYMBOL (PLANS)	ITEM PA ESTIMATI QUANTITI
CP CSP CUL V DIA DMH DS D'XING EHW EL ELEV ELW ES HW	CONCRETE PIPE CORRUGATED STEEL PIPE CULVERT DIAMETER DRAINAGE MANHOLE DRAINAGE STRUCTURE PIPE DITCH CROSSING EXTREME HIGH WATER ELEVATION ELEVATION EXTREME LOW WATER END SECTION HEADWALL	SW TE TO U/G	SIDEWALK TEMPORARY TEMPORARY UNDERGROUN WING WALL STANDARD SYMBOL (PLANS)	OCCUPANCY D ITEM PA ESTIMATI QUANTITI
CP CSP CULV DIA DMH DS D'XING EHW EL ELEV ES	CONCRETE PIPE CORRUGATED STEEL PIPE CULVERT DIAMETER DRAINAGE MANHOLE DRAINAGE STRUCTURE PIPE DITCH CROSSING EXTREME HIGH WATER ELEVATION ELEVATION EXTREME LOW WATER END SECTION	SW TE TO U/G	SIDEWALK TEMPORARY TEMPORARY UNDERGROUN WING WALL STANDARD SYMBOL (PLANS)	ITEM PA ESTIMATI QUANTITI
CP CSP CULV DIA DMH DS D'XING EHW EL ELEV ES HW INV	CONCRETE PIPE CORRUGATED STEEL PIPE CULVERT DIAMETER DRAINAGE MANHOLE DRAINAGE STRUCTURE PIPE DITCH CROSSING EXTREME HIGH WATER ELEVATION ELEVATION EXTREME LOW WATER END SECTION HEADWALL INVERT	SW TE TO U/G	SIDEWALK TEMPORARY TEMPORARY UNDERGROUN WING WALL STANDARD SYMBOL (PLANS) " ni	ITEM PA ESTIMATE QUANTITI
CP CSP CUL V DIA DMH DS D'XING EHW EL ELEV ELEW ES HW INV	CONCRETE PIPE CORRUGATED STEEL PIPE CULVERT DIAMETER DRAINAGE MANHOLE DRAINAGE STRUCTURE PIPE DITCH CROSSING EXTREME HIGH WATER ELEVATION ELEVATION EXTREME LOW WATER END SECTION HEADWALL INVERT MANHOLE	SW TE TO U/G	SIDEWALK TEMPORARY TEMPORARY UNDERGROUN WING WALL STANDARD SYMBOL (PLANS) " mi ft²	ITEM PA ESTIMATI QUANTITI - LF MI SF
CP CSP CUL V DIA DMH DS D'XING EHW EL ELEV ELEV ES HW INV MH MHW	CONCRETE PIPE CORRUGATED STEEL PIPE CULVERT DIAMETER DRAINAGE MANHOLE DRAINAGE STRUCTURE PIPE DITCH CROSSING EXTREME HIGH WATER ELEVATION ELEVATION EXTREME LOW WATER END SECTION HEADWALL INVERT MANHOLE MEAN HIGH WATER	SW TE TO U/G	SIDEWALK TEMPORARY TEMPORARY UNDERGROUN WING WALL STANDARD SYMBOL (PLANS) " " " " " " " " " " " " " " " " " " "	ITEM PA' ESTIMATI QUANTITI - LF MI SF
CP CSP CUL V DIA DMH DS D'XING EHW EL ELEV ELEV ES HW INV MH MHW OHW	CONCRETE PIPE CORRUGATED STEEL PIPE CULVERT DIAMETER DRAINAGE MANHOLE DRAINAGE STRUCTURE PIPE DITCH CROSSING EXTREME HIGH WATER ELEVATION ELEVATION EXTREME LOW WATER END SECTION HEADWALL INVERT MANHOLE MEAN HIGH WATER ORDINARY HIGH WATER	SW TE TO U/G	SIDEWALK TEMPORARY TEMPORARY UNDERGROUN WING WALL STANDARD SYMBOL (PLANS) " , mi ft² YD² AC	ITEM PATES TIMATE QUANTITIES LF MI SF SY AC
CP CSP CULV DIA DMH DS D'XING EHW EL ELEV ELW INV MH MHW OHW	CONCRETE PIPE CORRUGATED STEEL PIPE CULVERT DIAMETER DRAINAGE MANHOLE DRAINAGE STRUCTURE PIPE DITCH CROSSING EXTREME HIGH WATER ELEVATION ELEVATION EXTREME LOW WATER END SECTION HE ADWALL INVERT MANHOLE MEAN HIGH WATER ORDINARY HIGH WATER ORDINARY LOW WATER	SW TE TO U/G	SIDEWALK TEMPORARY TEMPORARY UNDERGROUN WING WALL STANDARD SYMBOL (PLANS) " , mi ft² YD² AC YD³	ITEM PATESTIMATE QUANTITI LF MI SF SY AC CY
CP CSP CULV DIA DMH DS D'XING EHW EL ELEV ES HW INV MH OHW OLW RCP	CONCRETE PIPE CORRUGATED STEEL PIPE CULVERT DIAMETER DRAINAGE MANHOLE DRAINAGE STRUCTURE PIPE DITCH CROSSING EXTREME HIGH WATER ELEVATION ELEVATION EXTREME LOW WATER END SECTION HEADWALL INVERT MANHOLE MEAN HIGH WATER ORDINARY HIGH WATER REINFORCED CONCRETE PIPE	SW TE TO U/G	SIDEWALK TEMPORARY TEMPORARY UNDERGROUN WING WALL STANDARD SYMBOL (PLANS) " , mi ft² YD² AC YD³ GAL	ITEM PAY ESTIMATE QUANTITI - LF MI SF SY AC CY GAL
CP CSP CULV DIA DMH DSS D'XING EHW EL ELEV ES HW INV MH MHW OHW OLW RCP SICPP	CONCRETE PIPE CORRUGATED STEEL PIPE CULVERT DIAMETER DRAINAGE MANHOLE DRAINAGE STRUCTURE PIPE DITCH CROSSING EXTREME HIGH WATER ELEVATION ELEVATION EXTREME LOW WATER END SECTION HEADWALL INVERT MANHOLE MANHOLE MEAN HIGH WATER ORDINARY HIGH WATER REINFORCED CONCRETE PIPE SMOOTH INTERIOR CORRUGATED POLYETHYLENE PIPE	SW TE TO U/G	SIDEWALK TEMPORARY TEMPORARY UNDERGROUN WING WALL STANDARD SYMBOL (PLANS) " mi ft² YD² AC YD³ GAL Ib	ITEM PAY ESTIMATE QUANTITI LF MI SF SY AC CY GAL LB
CP CSP CULV DIA DMH DS D'XING EHW EL ELEV ELW ES HW INV MH MHW OHW OLW RCP SICPP TB	CONCRETE PIPE CORRUGATED STEEL PIPE CULVERT DIAMETER DRAINAGE MANHOLE DRAINAGE STRUCTURE PIPE DITCH CROSSING EXTREME HIGH WATER ELEVATION ELEVATION EXTREME LOW WATER END SECTION HEADWALL INVERT MANHOLE MEAN HIGH WATER ORDINARY HIGH WATER REINFORCED CONCRETE PIPE SMOOTH INTERIOR CORRUGATED POLYETHYLENE PIPE TOP OF BANK (STREAM)	SW TE TO U/G	SIDEWALK TEMPORARY TEMPORARY UNDERGROUN WING WALL STANDARD SYMBOL (PLANS) " mi ft² YD² AC YD³ GAL Ib	ITEM PATESTIMATE QUANTITIES LF MI SF SY AC CY GAL LB TON

	ALIGNMENT TOPOGRAPHY (MISCELLANEOUS) UTILITIES		SUBSURFACE EXPLORATION				
ABBR.	DESCRIPTION	ABBR.	DESCRIPTION	ABBR.	DESCRIPTION	ABBR.	DESCRIPTION
AH	AHEAD	ABUT	ABUTMENT	Ε	ELECTRIC	REP	LACE ABBREVIATION "AB" WITH:
AZ	AZIMUTH	AOBE	AS ORDERED BY ENGINEER	EMH	ELECTRIC MANHOLE	ДН	I HAND AUGER
BK	BACK	ASPH	ASPHAL T	G	GAS	CP	CONE PENETROMETER
B2	BASELINE	BDY	BOUNDARY	GP	GUY POLE	DA	21/4 INCHES CASED DRILL HOLE
BRG	BEARING	BLDG	BUILDING	GSB	GAS SERVICE BOX (HOUSE LINE)	DM	DRILLING MUD
Ę	CENTERLINE	ВМ	BENCH MARK	GV	GAS VALVE (MAIN LINE)	DN DN	4 INCHES CASED DRILL HOLE
CS	CURVE TO SPIRAL	CC	CENTER TO CENTER	HYD	HYDRANT	FH.	HOLLOW FLIGHT AUGER
е	SUPERELEVATION RATE (CROSS SLOPE)	CONC	CONCRETE	LP	LIGHT POLE		
EQ	EQUALITY	CONST	CONSTRUCTION	LPG	LOW PRESSURE GAS	PA PH	POWER AUGER PROBE
EXT	EXTERNAL	CR	COUNTY ROAD	PP	POWER POLE		
HCL	HORIZONTAL CONTROL LINE	D	DEED DISTANCE	SA	SANITARY SEWER	PT PR	PERCOLATION TEST HOLE
HSD	HEADLIGHT SIGHT DISTANCE	DM	DIRECT MEASUREMENT	SMH	SANITARY MANHOLE	RP	1 INCH SAMPLER (RETRACTABLE PLUG)
L	LENGTH OF CIRCULAR CURVE	DWY	DRIVEWAY	ST	STORM SEWER		TO BE DEFINED AT THE TIME OF EXPLORATION
LS	LENGTH OF SPIRAL	EP	EDGE OF PAVEMENT	T	TELEPHONE	SP	SEISMIC POINT
LVC	LENGTH OF VERTICAL CURVE	ES	EDGE OF SHOULDER	TCB	TRAFFIC CONTROL BOX	TP	TEST PIT
E	CENTER CORRECTION OF VERTICAL CURVE	FEE	FEE ACQUISITION	TELBOX	TELEPHONE BOX		ATION "C" IN CATEGORIES: DN. AND FH WITH:
M	MAIN LINE	FEE WO/A	FEE ACQUISITION WITHOUT ACCESS	TEL P	TELEPHONE POLE	DA, UM,	BRIDGE
PC	POINT OF CURVATURE	FP	FENCE POST	TMH	TELEPHONE MANHOLE	В 6	
PI	POINT OF INTERSECTION	FD	FOUNDATION	CTV	CABLE TELEVISION		CUT DAM
POL	POINT ON LINE	FL	FENCE LINE	W	WATER		
PSD	PASSING SIGHT DISTANCE	GAR	GARAGE	WSB	WATER SERVICE BOX (HOUSE LINE)		FILL
PT	POINT OF TANGENT	GR	GRAVEL	W۷	WATER VALVE (MAIN LINE)	K_	CULVERT
PVC	POINT OF VERTICAL CURVE	но	HOUSE			<u>w</u>	WALL
PVI	POINT OF VERTICAL INTERSECTION	HWY	HIGHWAY			x	TO BE USED IF ONE OF THE ABOVE CANNOT BE DEFINED AT THE TIME THE EXPLORATION IS MADE
PVT	POINT OF VERTICAL TANGENT	IP	IRON PIN OR IRON PIPE				DELINES AT THE TIME THE EMPERITOR IS MADE
R	RADIUS	MB	MAILBOX	1			
SC	SPIRAL TO CURVE	MON	MONUMENT			I	
SSD	STOPPING SIGHT DISTANCE	N&W	NAIL AND WASHER		HIGHWAY INDEX OF EL	ECTRONIC EILES IF	DENTIFIED AS DI ANS
ST	SPIRAL TO TANGENT	OG	ORIGINAL GROUND		HIGHWAY INDEX OF EL	ECTRONIC FILES IL	DEINTIFIED AS FLAINS
STA	STATION	0/H	OVERHE AD		DECORIDE		011011011111111111111111111111111111111
T	TANGENT LENGTH	Р	PARCEL		DESCRIPTION		SITAL DATA SUPPLEMENTAL INFORMATION ²
TCI	THEODETICAL CDADE LINE	DAWT	DAVENENT	1 1		D265553 FEA	RWY ALG Site 13.XML

HIGHWAY INDEX OF E	LECTRONIC FILES IDENTIFIED AS PLANS	1
DESCRIPTION	DIGITAL DATA ¹	SUPPLEMENTAL INFORMATION
	D265553_FEA_RWY_ALG_Site 13.XML	
	D265553_FEA_CRK_ALG_Site 13.XML	
HORIZONTAL ALIGNMENT DATA	D265553_FEA_RWY_ALG_Site 14.XML	
(NY46, NY26, TRAIL, AND STREAMS)	D265553_FEA_CRK_ALG_Site 14.XML	2LC131_RPT_HORIZONTAL.PDF
(NT40, NT20, TRAIL, AND STREAMS)	D265553_FEA_RWY_ALG_Site 15.XML	
	D265553_FEA_CRK_ALG_Site 15.XML	
	D265553_FEA_RWY_ALG_MRT.XML	
	D265553_FEA_RWY_ALG_Site 13.XML	
	D265553_FEA_RWY_ALG_Site 14.XML	
HIGHWAY PROFILES & SUPERELEVATION, TRAIL PROFILES,	D265553_FEA_RWY_ALG_Site 15.XML	
STREAM PROFILES,	D265553_FEA_RWY_SUPER_SITE 14.XLS	2LC131_RPT_PROFILES.PDF
STREAMPROFILES	D265553_FEA_RWY_SUPER_SITE 15.XLS	
	D265553_FEA_RWY_ALG_MRT.XML	
	D265553_FEA_RWY_SUPER_MRT.XLS	
	D265553_FEA_RWY_BSL_Site 13.XML	
SURVEY BASELINES	D265553_FEA_RWY_BSL_Site 14.XML	2LC131_RPT_SURVEY.PDF
	D265553_FEA_RWY_BSL_Site 15.XML	
NOTES:		
1. REFER TO D265553_R02_ELECTRONIC FILES FOR PLANS.ZIP FC	OR DIGITAL DATA FILES	
2. REFER TO SUPPLEMENTAL INFORMATION FOR BIDDERS FOR S	SUPPORTING INFORMATION.	

HIGHWAY INDEX OF 11x17 DRAWINGS						
SHEET NO.	DESCRIPTION	DRAWING NUMBER				
1	TITLE SHEET	COV-01				
2	INDEX AND ABBREVIATIONS	IND-01				
3 & 4	LEGEND SHEETS	LEG-01 TO LEG-02				
5	ELECTRONIC FILES IDENTIFIED AS PLANS	ELE-01				
6	ALL SITES LOCATION MAPS	LM-01				
7	ALL SITES GENERAL NOTES	GN-01				
8	ALL SITES EROSION CONTROL NOTES	ECN-01				
9 - 12	SITE 14 WORK ZONE TRAFFIC CONTROL	WZTC14 -01 - WZTC14-04				
13 - 24	SITE 15 WORK ZONE TRAFFIC CONTROL	WZTC15 -01 - WZTC15-12				
25	SITE 13 BASELINE TIES	BLT13-1				
26	SITE 14 BASELINE TIES	BLT14-1				
27	SITE 15 BASELINE TIES	BLT15-1				
28	SITE 13 MAINTENANCE JURISDICTION PLAN	MJP13-01				
29	SITE 14 MAINTENANCE JURISDICTION PLAN	MJP14-01				
30	SITE 15 MAINTENANCE JURISDICTION PLAN	MJP15-01				
31 - 32	ALL SITES MISCELLANEOUS DETAILS	MSD-01 - MSD-02				
33	ALL SITES MISCELLANEOUS TABLES	MT-01				
34	ALL SITES EARTHWORK SUMMARY	ESS-01				
	SITE 13 - C270037					
35	GENERAL PLAN	PL13-01				
36 - 39	CULVERT DRAWINGS	CUL13-01 - CUL13-04				
30 33	SITE 14 - C240033	0022001 0022001				
40	TYPICAL SECTIONS	TS14-01				
41	GENERAL PLAN	PL14-01				
42	SIGNING, STRIPING AND RAILING LAYOUT PLAN	PM14-01				
43	UTILITY PLAN	UT14-01				
44	EROSION CONTROL PLAN	ECP14-01				
45 - 51	CULVERT DRAWINGS	CUL14-01 - CUL14-07				
52 - 55	RAILING DETAILS	RL14-01 - RL14-04				
	SITE 15 - C270026					
56	TYPICAL SECTIONS	TS15-01				
57	GENERAL PLAN	PL15-01				
58	SIGNING, STRIPING, AND RAILING LAYOUT PLAN	PM15-01				
59	EROSION CONTROL PLAN	ECP15-01				
60 - 67	CULVERT DRAWINGS	CUL15-01 - CUL15-08				
00 07	SITE 15 - MOHAWK RIVER TRAIL (MRT) (PIN 2650.61)	0013 01 0013 00				
68 - 71	TYPICAL SECTIONS	TSMRT-01 - TSMRT-04				
72	GENERAL NOTES	GNMRT-01				
73 - 74	MISCELLANEOUS TABLES	MTMRT-01 - MTMRT-02				
75 - 77	MISCELLANEOUS TABLES MISCELLANEOUS DETAILS	MDMRT-01 - MDMRT-03				
78 - 79	GRADING AND DRAINAGE PLAN	GRMRT-01 - GRMRT-02				
80	EROSION AND SEDIMENT CONTROL NOTES	ENMRT-01				
81	EROSION AND SEDIMENT CONTROL NOTES EROSION AND SEDIMENT CONTROL PLAN	EPMRT-01				
82 - 83	GENERAL PLANS	PLMRT-01 - PLMRT-02				
82 - 83 84	SIGN TEXT DATA SHEET	STMRT-01				
85 - 86	SIGNING AND STRIPING PLANS	PMMRT-01 - PMMRT-02				
87	WALL PROFILES	WLMRT-01				
88 - 93	STRUCTURE DRAWINGS	CLMRT-01 - CLMRT-06				
94	LIGHTING PLANS	LDMRT-01				
95	LIGHTING DETAILS	LPMRT-01				

TOTAL NUMBER OF SHEETS

STANDARD SYMBOL (PLANS)	ITEM PAYMENT UNIT: ESTIMATE OF QUANTITIES SHEET	EQUIVALENT NOMENCLATURE: (SPECS/PROPOSAL)
п	-	INCHES
,	LF	LINEAR FEET
mi	MI	MILES
f†²	SF	SQUARE FEET
YD2	SY	SQUARE YARD
AC	AC	ACRES
YD3	CY	
GAL	GAL	GALLON
lb	LB	POUND
TON	TON	TON

AS-BUILT REVISIONS DESCRIPTION OF ALTERATIONS:	LARGE CULVERT REPLACEMENTS AT MULTIPLE LOCA	1.1.1 2201101	BRIDGES	CUL VERTS C270037 C240033	ALL DIMENSIONS IN ft UNLESS OTHERWISE NOT	TED	
DESCRIPTION OF ALTERATIONS:	CONTRACT 6	PIN 2650.61			ALL CITEC		
	S.H. 1355, S.H. 339, S.H. 562			C270026 C260199	ALL SITES	_	
	AVA, GEORGETOWN, CITY OF ROME				INDEX AND ABBREVIATIONS		
	COUNTY: ONEIDA, MADISON	REGION: 2					
IT IS A VIOLATION OF LAW FOR ANY PERSON, UNIT	IT IS A VIOLATION OF LAW FOR ANY PERSON LINESS THEY ARE ACTING INDER THE DIRECTION OF A LICENSED PROFESSIONAL ENGINEER ARCHITECT. LANDSCAPE ARCHITECT, OR LAND SURVEYOR						

IT IS A VIOLATION OF LAW FOR ANY PERSON, UNLESS THEY ARE ACTING UNDER THE DIRECTION OF A LICENSED PROFESSIONAL ENGINEER, ARCHITECT, LANDSCAPE ARCHITECT, OR LAND SURVEYOR, TO ALTER AN ITEM IN ANY WAY. IF AN ITEM BEARING THE STAMP OF A LICENSED PROFESSIONAL IS ALTERED, THE ALTERING ENGINEER, ARCHITECT, LANDSCAPE ARCHITECT, OR LAND SURVEYOR SHALL STAMP THE DOCUMENT AND INCLUDE THE NOTATION "ALTERED BY" FOLLOWED BY THEIR SIGNATURE, THE DATE OF SUCH ALTERATION, AND A SPECIFIC DESCRIPTION OF THE ALTERATION.



SHEET NO.

CONTRACT NUMBER D265553 DRAWING NO.

IND-01

1.	THE LEGEND	ILLUSTRATES	MAPPING	FEATURES	(EXISTING	AND	PROPOSED).	

- FEATURES ARE SHOWN AS EITHER LINEAR (ROADWAY GUIDERAIL, ROADWAY SIDEWALK, UTILITY LINES, ETC.) OR POINT (SIGN, UTILITY POLE, ETC.).
- 3. FEATURES SHOWN ON THE LEGEND AS EXISTING FEATURES ALSO HAVE CORRESPONDING PROPOSED FEATURES.
- PROPOSED FEATURE SYMBOLOGY IS IDENTICAL TO EXISTING FEATURE SYMBOLOGY EXCLUDING LINE WEIGHT. LINE WEIGHT FOR PROPOSED FEATURES IS THICKER (0.015 in ON B SIZE DRAWINGS).
- MAPPING FEATURES NOT INCLUDED ON THE LEGEND SHEET DO NOT HAVE A UNIQUE SYMBOLOGY (SUCH AS THE PAVEMENT EDGE, PAVEMENT EDGE OF TRAVEL WAY) AND SHOULD BE LABELED ON THE PLANS.
- 6. FEATURES SHOWN AT THE HEAVIER WEIGHT ARE PROPOSED ONLY AND DO NOT HAVE CORRESPONDING EXISTING FEATURES.

SCRIPTION OF ALTERATIONS.			BRIDGES	CULVERTS	ALL DIMENSIONS IN ft UNLESS OTHERWISE NOT	TED
	CONTRACT 6	PIN 2650.61		C270037 C240033 C270026 C260199	ALL CITES	
	S.H. 1355, S.H. 339, S.H. 562				ALL SITES	
	AVA, GEORGETOWN, CITY OF ROME			0200133	LEGEND	
	COUNTY: ONEIDA, MADISON REGION: 2					

TRAFFIC CONTROL

SIGNAL, SPAN WIRE

TCSW

IT IS A VIOLATION OF LAW FOR ANY PERSON, UNLESS THEY ARE ACTING UNDER THE DIRECTION OF A LICENSED PROFESSIONAL ENGINEER, ARCHITECT, LANDSCAPE ARCHITECT, OR LAND SURVEYOR, TO ALTER AN ITEM IN ANY WAY. IF AN ITEM BEARING THE STAMP OF A LICENSED PROFESSIONAL IS ALTERED, THE ALTERING ENGINEER, ARCHITECT, LANDSCAPE ARCHITECT, OR LAND SURVEYOR SHALL STAMP THE DOCUMENT AND INCLUDE THE NOTATION "ALTERED BY" FOLLOWED BY THEIR SIGNATURE, THE DATE OF SUCH ALTERATION, AND A SPECIFIC DESCRIPTION OF THE ALTERATION.

MPL

MPLA

MSL

PROPERTY LOT LINE

SUB LOT LINE

PROPERTY LOT LINE, APPROXIMATE



CONTRACT NUMBER

D265553

LEG-01

DRAWING NO.

WATER LINE, HANGING

WATER LINE, OVERHEAD

OW

NOTES:

1. THE ELECTRONIC FILES IDENTIFIED AS PLANS FOR THE SUBJECT PROJECT HAVE BEEN COMPLETED IN ACCORDANCE WITH ALL APPLICABLE NYSDOT STANDARDS AND SPECIFICATIONS. THE PROFESSIONAL SEAL(S) LOCATED HEREIN APPLY TO ALL FILES LISTED IN THE "ELECTRONIC FILES IDENTIFIED AS PLANS" TABLE WHERE THE ENGINEER OF RECORD IS LISTED.

2. THE CONTRACTOR SHALL UTILIZE THE INFORMATION IN ELECTRONIC FORM, OR DETERMINE HOW TO BEST MANIPULATE THE MODEL TO PRINT DESIRED INFORMATION. THE CAD INFORMATION IS GEOSPATIALLY LOCATED USING THE APPROPRIATE STATE PLANE COORDINATE SYSTEM. THE ELECTRONIC FILES IDENTIFIED AS PLANS ARE A PART OF THE CONTRACT DOCUMENTS AND ARE AVAILABLE FOR DOWNLOAD WITH THE OTHER CONTRACT DOCUMENT ELEMENTS. THE ELECTRONIC FILES ARE PROVIDED WITH SUFFICIENT DETAIL TO ALLOW THE CONTRACTOR, SUBCONTRACTORS, FABRICATORS AND SUPPLIERS TO QUICKLY, EFFICIENTLY AND ACCURATELY SHARE INFORMATION NECESSARY TO COMPLETE THE WORK.

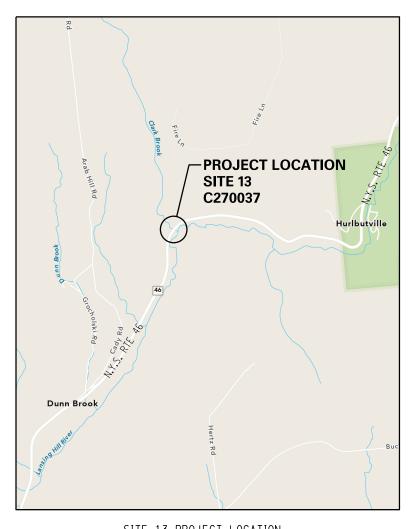
		ELECTRONIC	FILES IDENTIFIED AS PLA	ANS	
	FILE NAME	FILE DESCRIPTION	DATE/TIME MODIFIED	AFFIX SEAL:	ALTERED BY:
	D265553_FEA_RWY_ALG_Site 13.XML	SITE 13 - ROADWAY GEOMETRY	6/12/2025 8:51 AM		
	D265553_FEA_CRK_ALG_Site 13.XML	SITE 13 - STREAM GEOMETRY	6/12/2025 8:52 AM	OF NEW	
2	D265553_FEA_RWY_ALG_Site 14.XML	SITE 14 - ROADWAY GEOMETRY	6/12/2025 8:55 AM	TE A FOIL	
8	D265553_FEA_CRK_ALG_Site 14.XML	SITE 14 - STREAM GEOMETRY	6/12/2025 8:56 AM	TAT THE TOP	
PROFESSIONAL OF RECORD	D2655 53_FEA_R WY_ALG_Site 15.XML	SITE 15 - ROADWAY GEOMETRY	6/12/2025 9:01 AM	13/2	
P.	D265553_FEA_CRK_ALG_Site 15.XML	SITE 15 - STREAM GEOMETRY	6/12/2025 9:02 AM		l .
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				LABELLA ASSOCIATES, D.P.C.	
	D265553_FEA_RWY_ALG_MRT.XML	MRT - ROADWAY AND TRAIL GEOMETRY	6/26/2025 12:25 PM		
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3-11	D265553_FEA_RWY_BSL_Site 13.XML	SITE 13 - SURVEY BASELINE	6/4/2025 1:39 PM	S. ARTHUR 6/24/2025	
	D265553_FEA_RWY_BSL_Site 14.XML	SITE 14 - SURVEY BASELINE	6/4/2025 10:46 AM	Section 1	
2	D265553_FEA_RWY_BSL_Site 15.XML	SITE 15 - SURVEY BASELINE	6/4/2025 12:00 PM	OF NEW	
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NOTE: DATE/TIME MODIFIED IS EASTERN TIME ZONE, BE ADVISED THE ACTUAL FILE TIME STAMPS WILL AUTOMATICALLY ADJUST BY ONE HOUR WHEN TRANSITIONING TO AND FROM DAYLIGHT SAVINGS TIME.

REVISED FILE NAME	REVISED BY	DATE REVISED	DESCRIPTION OF ALTERATIONS

NOTE: DATE/TIME MODIFIED IS EASTERN TIME ZONE. BE ADVISED THE ACTUAL FILE TIME STAMPS WILL AUTOMATICALLY ADJUST BY ONE HOUR WHEN TRANSITIONING TO AND FROM DAYLIGHT SAVINGS TIME.

AS-BUILT REVISIONS DESCRIPTION OF ALTERATIONS:	LARGE CULVERT REPLACEMENTS AT MULTIPLE LOCATIONS			CUL VERTS C270037 C240033 C270026 C260199	ALL DIMENSIONS IN ft UNLESS OTHERWISE NOTED	CONTRACT NUMBER	
	CONTRACT 6	PIN 2650.61				0265553	رخا ا
	S.H. 1355, S.H. 339, S.H. 562				ALL SITES		
	AVA, GEORGETOWN, CITY OF ROME				ELECTRONIC FILES	DRAWING NO.	ELE-01
	COUNTY: ONEIDA, MADISON REGION: 2				IDENTIFIED AS PLANS	SHEET NO.	5
TO ALTER AN ITEM IN ANY WAY, IF AN ITEM BEARING THE STAMP	ACTING UNDER THE DIRECTION OF A LICENSED PROFESSIONAL ENGINEER, ARG OF A LICENSED PROFESSIONAL IS ALTERED, THE ALTERING ENGINEER, ARG ED BY" FOLLOWED BY THEIR SIGNATURE, THE DATE OF SUCH ALTERATION, A	HITECT, LANDSCAPE ARCHITECT	, OR LAND SURVEYO)R	2	NEW YORK Departme	



SITE 13 PROJECT LOCATION

NYS ROUTE 46 OVER CLARK BROOK IS LOCATED IN THE TOWN OF AVA, ONEIDA COUNTY,

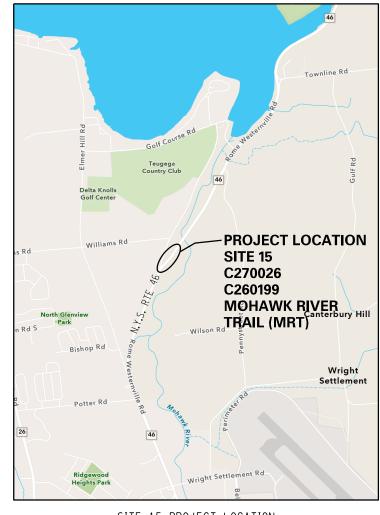
APPROXIMATLEY 7.6 MILES SOUTH OF THE INTERSECTION WITH NYS 294 IN THE VILLAGE

OF BOONVILLE.




SITE 14 PROJECT LOCATION

NYS ROUTE 26 OVER TRIBUTARY OF OTSELIC RIVER IN THE TOWN OF GEORGETOWN, MADISON COUNTY, APPROXIMATELY 1.5 MILES NORTH OF THE INTERSECTION WITH NYS 80 IN THE HAMLET OF GEORGETOWN.



SITE 15 PROJECT LOCATION

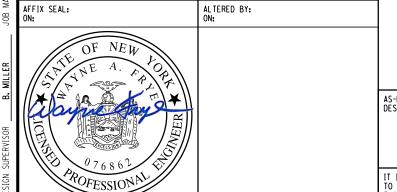NYS ROUTE 46 OVER TRIBUTARY OF MOHAWK RIVER AND THE MOHAWK RIVER TRAIL (MRT)
IN THE CITY OF ROME, ONEIDA COUNTY, APPROXIMATELY 3.5 MILES NORTH OF THE
INTERSECTION WITH NYS 26.



AS-BUILT REVISIONS
DESCRIPTION OF ALTERATIONS:

LARGE CULVERT REPLACEMENTS AT MULTIPLE LOCATIONS
CONTRACT 6

S.H. 1355, S.H. 339, S.H. 562
AVA, GEORGETOWN, CITY OF ROME
COUNTY: ONEIDA, MADISON REGION: 2

OR LAND SURVEYOR,
OR LAND SURVEYOR

C270037 C240033

C270026 C260199

BRIDGES

ALL DIMENSIONS IN ft UNLESS OTHERWISE NOTED

ALL SITES

LOCATION MAPS

CONTRACT NUMBER
D265553
DRAWING NO.

DRAWING NO. SHEET NO.

NEW YORK Department of Transportation

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GENERAL NOTES:

DESIGN SPECIFICATIONS: NYSDOT LRFD BRIDGE DESIGN SPECIFICATIONS WITH ALL PROVISIONS IN EFFECT AS OF THE

CONSTRUCTION SPECIFICATIONS: NYSDOT STANDARD SPECIFICATIONS - CONSTRUCTION AND MATERIALS WITH ALL PROVISIONS IN EFFECT AS OF THE LETTING DATE.

THIS STRUCTURE SHALL BE MAINTAINED IN ACCORDANCE WITH THE GUIDELINES CONTAINED IN THE CURRENT VERSION OF THE AASHTO MAINTENANCE MANUAL FOR ROADWAYS AND BRIDGES.

DESIGN LIVE LOAD: AASHTO HL - 93.

DETAILS ON THE DRAWINGS LABELED AS "NOT TO SCALE" ARE INTENTIONALLY DRAWN NOT TO SCALE FOR VISUAL CLARITY. ALL OTHER DETAILS FOR WHICH NO SCALE IS SHOWN ARE DRAWN PROPORTIONALLY AND ARE FULLY

ALL SHOP DRAWINGS FOR THIS PROJECT SHALL BE PREPARED IN U.S. CUSTOMARY UNITS.

NO KNOWN ASBESTOS CONTAINING MATERIALS ARE BELIEVED TO EXIST AND/OR THE WORK TO BE PERFORMED UNDER THIS CONTRACT DOES NOT REQUIRE THE DISTURBANCE, DESTRUCTION OR REMOVAL OF ANY OF THESE MATERIALS. IT IS THE EXPRESS INTENT OF THIS CONTRACT THAT THESE MATERIALS ARE NOT TO BE DISTURBED IN ANY WAY, SHOULD THE CONTRACTOR DISTURB OR ENCOUNTER ANY SUCH MATERIALS, THE CONTRACTOR SHALL IMMEDIATELY STOP WORK AND NOTIFY THE ENGINEER. THE CONTRACTOR SHALL IMMEDIATELY STOP WORK AND

FOUNDATION NOTES:

EMBANKMENT IN PLACE, ITEM 203.03 AND SELECT GRANULAR FILL, ITEM 203.07 SHALL BE PLACED SIMULTANEOUSLY, ON BOTH SIDES OF THE VERTICAL PAYMENT LINE.

THE COST OF WATER USED FOR COMPACTION OF EMBANKMENT IN PLACE MATERIAL SHALL BE INCLUDED IN THE UNIT PRICE BID FOR ITEM 203.03 - EMBANKMENT IN PLACE.

THE COST OF WATER USED FOR COMPACTION OF THE SELECT GRANULAR FILL SHALL BE INCLUDED IN THE UNIT PRICE BID FOR ITEM 203.07 - SELECT GRANULAR FILL.

SUBSTRUCTURE NOTES

THE CONTRACTOR, WITH THE APPROVAL OF THE DCES, MAY ELECT TO INTRODUCE CONSTRUCTION JOINTS IN THE WINGWALLS AT LOCATIONS NOT SHOWN IN THE PLANS. CONSTRUCTION JOINTS SHALL BE PROVIDED WITH SHEAR KEYS AND WATERSTOPS. VERTICAL CONSTRUCTION JOINTS INTRODUCED IN THE WINGWALLS SHOULD PREFERABLY BE PLACED MIDWAY BETWEEN THE PEDESTALS.

THE COST OF ALL JOINT MATERIAL AND WATERSTOPS AT CONCRETE CONSTRUCTION JOINTS, CONTRACTION AND EXPANSION JOINTS SHALL BE INCLUDED IN THE UNIT PRICE BID FOR THE VARIOUS CONCRETE ITEMS IN THE CONTRACT.

REMOVAL NOTES:

EXISTING CULVERT SIZED STRUCTURES SHALL BE REMOVED WITHIN THE PAY LIMITS SHOWN IN THE PLANS UNDER ITEM 206.01 - STRUCTURE EXCAVATION.

RECONSTRUCTION NOTES:

THE DETAILS SHOWN FOR THE CULVERT BARREL ARE BASED ON THE ASSUMPTION THAT THE WATER IN THE STREAM CHANNEL WILL BE DIVERTED OR CARRIED IN A FLUME DURING THE ENTIRE CONSTRUCTION OF THE BARREL. SHOULD THE CONTRACTOR ELECT TO DIVERT THE WATER THROUGH ONE OF THE CELLS BEFORE COMPLETION OF THE ENTIRE BARREL, THE CONTRACTOR SHALL SUBMIT TO THE DCES FOR APPROVAL, THE CONSTRUCTION PROCEDURES AND SKETCHES SHOWING THE LOCATION OF THE PROPOSED CONSTRUCTION AND CONTRACTION JOINTS AND THE CHANGES IN THE BAR REINFORCEMENT DETAILS.

DUE TO THE NATURE OF RECONSTRUCTION PROJECTS, THE EXACT EXTENT OF RECONSTRUCTION WORK CANNOT BE ACCURATELY DETERMINED PRIOR TO THE COMMENCEMENT OF WORK. THE CONTRACT DOCUMENTS HAVE BEEN PREPARED BASED ON FIELD INSPECTION AND OTHER INFORMATION AVAILABLE AT THE TIME. ACTUAL FIELD CONDITIONS MAY REQUIRE MODIFICATIONS TO CONSTRUCTION DETAILS AND WORK QUANTITIES. THE CONTRACTOR SHALL PERFORM THE WORK IN ACCORDANCE WITH FIELD CONDITIONS.

THE CONTRACTOR SHALL PERFORM ALL WORK WITH CARE SO THAT ANY MATERIALS WHICH ARE TO REMAIN IN PLACE, OR WHICH ARE TO REMAIN THE PROPERTY OF THE STATE, WILL NOT BE DAMAGED. IF THE CONTRACTOR DAMAGES ANY MATERIALS WHICH ARE TO REMAIN IN PLACE OR WHICH ARE TO REMAIN THE PROPERTY OF THE STATE, THE DAMAGED MATERIALS SHALL BE REPAIRED OR REPLACED IN A MANNER SATISFACTORY TO THE ENGINEER AT THE EXPENSE OF THE

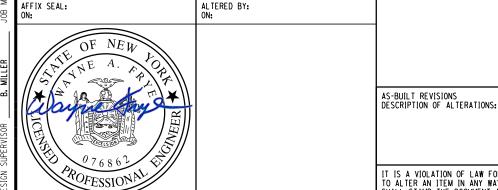
WHEN ITEMS IN THE CONTRACT REQUIRE MATERIALS TO BE REMOVED AND DISPOSED OF, THE COST OF SUPPLYING A DISPOSAL AREA AND TRANSPORTATION TO THAT AREA SHALL BE INCLUDED IN THE UNIT PRICE BID FOR THOSE ITEMS.

DURING REMOVAL OPERATIONS, THE CONTRACTOR SHALL NOT DROP WASTE CONCRETE, DEBRIS, AND OTHER MATERIAL TO THE AREA BELOW THE STRUCTURE EXCEPT WHERE THE PLANS SPECIFICALLY PERMIT THE DROPPING OF MATERIAL. PLATFORMS, NETS, SCREENS OR OTHER PROTECTIVE DEVICES SHALL BE USED TO CATCH THE MATERIAL. IF ADEQUATE PROTECTIVE DEVICES ARE NOT BEING EMPLOYED, THE WORK SHALL BE STOPPED UNTIL ADEQUATE PROTECTION IS

ALL MATERIAL FALLING ON THE AREA BELOW AND ADJACENT TO THE STRUCTURE SHALL BE REMOVED AND DISPOSED OF BY THE CONTRACTOR AT NO COST TO THE STATE.

THE COST OF FURNISHING, INSTALLING, MAINTAINING, REMOVING AND DISPOSING OF ALL PLATFORMS, NETS, SCREENS OR OTHER PROTECTIVE DEVICES SHALL BE INCLUDED IN THE UNIT PRICE BID USING THE APPROPRIATE ITEMS IN THE

THE EMBEDMENT DEPTH SHOWN IN THE PLANS FOR DRILLING AND GROUTING IS FOR ESTIMATING PURPOSES ONLY. THE CONTRACTOR'S ENGINEER SHALL DETERMINE THE DEVELOPMENT LENGTH REQUIRED TO DEVELOP THE FULL STRENGTH OF THE ANCHOR ROD AND/OR REINFORCING BAR. THE CALCULATIONS SHALL BE BASED ON THE SIZE OF THE ROD/BAR, ACTUAL EDGE DISTANCE TO THE ROD/BAR, THE PROXIMITY TO OTHER RODS/BARS, ESTIMATED CONCRETE STRENGTH, AND THE GROUT SUPPLIERS' RECOMMENDATIONS. THE CONTRACTOR SHALL SUBMIT DESIGN CALCULATIONS AND DETAILS SEALED BY A DECISIONAL FROM THE RODS TO THE ROD THE R BY A REGISTERED NEW YORK STATE PROFESSIONAL ENGINEER TO THE ENGINEER FOR APPROVAL.



ARGE CULVERT REPLACEMENTS AT MULTIPLE LOCATIONS CONTRACT 6 S.H. 1355, S.H. 339, S.H. 562 AVA, GEORGETOWN, CITY OF ROME COUNTY: ONEIDA, MADISON

PIN 2LC1.31 BRIDGES **CUL VERTS** 0240033 C270026

ALL DIMENSIONS IN ft UNLESS OTHERWISE NOTED ALL SITES

GENERAL NOTES

CONTRACT NUMBER D265553

DRAWING NO.

SHEET NO.

GN-01

IT IS A VIOLATION OF LAW FOR ANY PERSON, UNLESS THEY ARE ACTING UNDER THE DIRECTION OF A LICENSED PROFESSIONAL ENGINEER, ARCHITECT, LANDSCAPE ARCHITECT, OR LAND SURVEYOR, TO ALTER AN ITEM IN ANY WAY. IF AN ITEM BEARING THE STAMP OF A LICENSED PROFESSIONAL IS ALTERED, THE ALTERING ENGINEER, ARCHITECT, LANDSCAPE ARCHITECT, OR LAND SURVEYOR SHALL STAMP THE DOCUMENT AND INCLUDE THE NOTATION "ALTERED BY" FOLLOWED BY THEIR SIGNATURE, THE DATE OF SUCH ALTERATION, AND A SPECIFIC DESCRIPTION OF THE ALTERATION.



GENERAL EROSION AND SEDIMENT CONTROL NOTES:

THE CONTRACTOR IS ADVISED THAT ALL THEIR WORK SHALL CONFORM TO USACE SECTION 404, NWP NO. 3 (MAINTENANCE). NWP NO. 14 (LINEAR TRANSPORTATION PROJECTS). NWP NO. 33 (TEMPORARY CONSTRUCTION, ACCESS AND DEWATERING), NYSDEC ARTICLE 15 - EXCAVATION AND FILL IN NAVIGABLE WATERS AND STREAM DISTURBANCE PERMIT, NYSDEC ARTICLE 24 - FRESHWATER WETLANDS, AND SECTION 401 WATER QUALITY CERTIFICATION TO ENSURE WATER QUALITY IS MAINTAINED AT ALL TIMES DURING CONSTRUCTION.

THE CONTRACTOR SHALL COMPLY WITH ALL PROVISIONS OF ANY APPLICABLE N.Y.S. DEPARTMENT OF ENVIRONMENTAL CONSERVATION WATER QUALITY CERTIFICATION AND/OR FRESHWATER WETLANDS AND STREAM DISTURBANCE PERMITS INCLUDING BUT NOT LIMITED TO ARMY CORPS OF ENGINEERS REQUIREMENTS AND REGULATIONS.

ALL METHODS AND EQUIPMENT PROPOSED BY THE CONTRACTOR TO ACCOMPLISH THE WORK SHALL BE SUBJECT TO THE APPROVAL OF THE ENGINEER IN CHARGE.

AT THE PRE-CONSTRUCTION MEETING, THE CONTRACTOR SHALL SUBMIT FOR APPROVAL TO THE ENGINEER IN CHARGE HIS WRITTEN SCHEDULE AND PROPOSED MEASURES FOR TEMPORARY AND PERMANENT EROSION AND SEDIMENT CONTROL WORK AND SCHEDULE OF OPERATIONS AS REQUIRED BY SECTION 209 OF THE NYSDOT STANDARD SPECIFICATIONS.

ALL NECESSARY PRECAUTIONS SHALL BE TAKEN TO PREVENT CONTAMINATION OF ANY STREAM OR WATERWAY BY SILT, SEDIMENT, FUELS, SOLVENTS, LUBRICANTS, EPOXY COATINGS, CONCRETE LEACHATE OR ANY OTHER POLLUTANT ASSOCIATED WITH CONSTRUCTION AND CONSTRUCTION

THE TEMPORARY SOIL EROSION AND SEDIMENT CONTROL DEVICES SPECIFIED IN THIS CONTRACT SHALL BE CHECKED AND REPAIRED AS NECESSARY, ON A DAILY BASIS AND AFTER EACH STORM EVENT. PERIODIC CLEANING OF THE SOIL EROSION AND SEDIMENT CONTROL DEVICES WILL BE NECESSARY,

ALL STORM DRAINAGE OUTLETS SHALL BE STABILIZED, AS REQUIRED, BEFORE THE DISCHARGE POINT BECOMES OPERATIONAL.

ANY DEBRIS OR EXCESS MATERIALS FROM CONSTRUCTION SHALL BE IMMEDIATELY AND COMPLETELY REMOVED FROM THE BED AND BANKS OF ALL WATER AREAS.

ALL CONTROL MEASURES SHALL BE PLACED PRIOR TO STARTING EARTH WORK OPERATIONS AND SHALL REMAIN IN PLACE UNTIL THE NEW SLOPES ARE STABILIZED WITH PERMANENT VEGETATION AND/OR SLOPE PROTECTION MATERIALS, A.O.B.E.

THE SITE SHALL AT ALL TIMES BE GRADED AND MAINTAINED SUCH THAT ALL STORM WATER RUNDER IS DIVERTED TO SOIL EROSION AND SEDIMENT CONTROL FACILITIES. STORM WATER FROM DISTURBED AREAS MUST PASS THROUGH SILTATION FENCE OR SEDIMENT FILTER LOGS BEFORE DISCHARGE BEYOND DISTURBED AREAS OR INTO INLETS OF OTHER DRAINAGE SYSTEMS.

ALL SEDIMENT SHALL BE PREVENTED FROM ENTERING STORM DRAINS, DITCHES OR WATER COURSES

DISTURBANCES SHOULD BE LIMITED WHENEVER AND WHEREVER POSSIBLE. IN BOTH AREA AND IN TIME. EARTH MATERIAL EXPOSED BY ANY CONSTRUCTION ACTIVITY MUST NOT BE LEFT INACTIVE FOR MORE THAN 7 DAYS WITHOUT THE APPLICATION OF TEMPORARY OR PERMANENT EROSION CONTROLS. SLOPES SHOULD BE RAPIDLY BROUGHT TO FINAL GRADE, STABILIZED, AND SEEDED AS SOON AS POSSIBLE.

ALL AREAS OF SOIL DISTURBANCES RESULTING FROM THIS PROJECT SHALL BE SEEDED WITH TYPE A ROADSIDE MIX AND MULCHED WITH STRAW WITHIN ONE WEEK OF FINAL GRADING. UTILIZE A STANDARD NYSDOT ROADSIDE MIX IN ACCORDANCE WITH ITEM 610.1605, IF CONSTRUCTION ACTIVITIES ARE DISCONTINUED IN AREAS OF SOIL DISTURBANCES BEFORE FINAL GRADING IS COMPLETE, TEMPORARY GRADING SHALL ALSO BE SEEDED AND MULCHED A.O.B.E. MULCH SHALL BE MAINTAINED UNTIL A SUITABLE COVER IS ESTABLISHED. PAYMENT FOR TEMPORARY SEEDING AND MULCHING SHALL BE MADE UNDER ITEM 209.1003.

OTHER EROSION CONTROL MEASURES MAY BE REQUIRED A.O.B.E. IN ADDITION TO SCHEMES SHOWN. PAYMENT FOR ADDITIONAL WORK SHALL BE PAID UNDER THE APPROPRIATE ITEM IN THE CONTRACT. ENCLOSE ANY TEMPORARY STOCKPILES OF TOPSOIL OR FILL, AND SOIL SURCHARGE AREAS WITH BIODEGRADABLE SEDIMENT FILTER LOG, ITEM 209.23010009, TO PREVENT EROSION OF THE PILE. ALL SEDIMENT FILTER LOG SHALL BE INSTALLED ON THE CONTOUR WITH A GRADE OF 2% OR LESS. STOCKPILES SHALL BE STABILIZED WITH MULCH IMMEDIATELY AND THOSE EXPOSED FOR LONGER THAN TWO WEEKS SHALL BE RECEIVE TEMPORARY SEEDING. PAYMENT FOR TEMPORARY SEEDING AND MULCHING SHALL BE MADE LINDER ITEM 209,1003.

THE LOCATIONS OF EROSION AND SEDIMENT CONTROL MEASURES AS INDICATED IN THE CONTRACTOR DOCUMENTS MAY REQUIRE FIELD ADJUSTMENT DEPENDING ON THE SEQUENCE OF CONSTRUCTION ACTIVITIES, CONSTRUCTION METHODS, AND/OR ACTUAL FIELD CONDITIONS. THE ENGINEER SHALL BE NOTIFIED OF ANY SIGNIFICANT FIELD CHANGES TO THE EROSION AND SEDIMENT CONTROL MEASURES INDICATED IN THE CONTRACT DOCUMENTS.

TYPICALLY THE SEDIMENT FILTER LOG SHALL BE INSTALLED ALONG EXISTING/PROPOSED CONTOUR

THE CONTRACTOR SHALL COMPLY WITH THE NYSDOT STANDARD SHEET, DETAIL WITHIN THE CONTRACT DOCUMENTS, AND MANUFACTURER INSTALLATION GUIDE WHEN INSTALLING EROSION, AND SEDIMENT CONTROL MEASURES OR A.O.B.E.

STREAM PROTECTION NOTES:

DURING THE COURSE OF CONSTRUCTION, THE CONTRACTOR SHALL CONDUCT OPERATIONS IN SUCH A MANNER AS TO PREVENT OR REDUCE TO A MINIMUM ANY DAMAGE TO ANY STREAM FROM POLLUTION BY DEBRIS, SEDIMENT, CONSTRUCTION MATERIALS OR OTHER FOREIGN MATERIALS, OR FROM THE OPERATION OF EQUIPMENT IN OR NEAR SUCH STREAMS. THE CONTRACTOR SHALL NOT RETURN DIRECTLY TO A STREAM ANY WATER WHICH HAS BEEN USED FOR WASH PURPOSES OR OTHER SIMILAR OPERATIONS WHICH CAUSE THE STREAM TO BECOME POLLUTED WITH SAND, SILT, CEMENT, OIL, OR OTHER IMPURITIES. IF THE CONTRACTOR USES WATER FROM A STREAM, THE CONTRACTOR SHALL CONSTRUCT AN INTAKE OR TEMPORARY DAM TO PROTECT AND MAINTAIN WATER RIGHTS AND TO SUSTAIN FISH LIFE DOWNSTREAM.

STREAM RESTRICTIONS:

SITE 13 - C270037: OCT 1 - MAY 15 SITE 14 - C240033: OCT 1 - MAY 15 SITE 15 - C270026: OCT 1 - MAY 15

WATERWAY DIVERSION NOTES:

THE INTENT OF A WATERWAY DIVERSION STRUCTURE IS TO TEMPORARY DIVERT OR PUMP WATER AROUND AN AREA (STREAM WORK AREA) SO THAT EXCAVATION OR OTHER WORK CAN BE ACCOMPLISHED. ITS PURPOSE IS TO PROVIDE WATER QUALITY PROTECTION. IT IS NOT INTENDED TO BE A SUBSTITUTION FOR OR EQUAL TO A COFFERDAM. TURBIDITY/WATER QUALITY DOWN STREAM OF THE WORK AREA SHALL MATCH THE TURBIDITY/WATER QUALITY UPSTREAM OF THE WORK SITE.

STREAM FLOWS TO BE MAINTAINED THROUGHOUT CONSTRUCTION. THIS MAY BE ACCOMPLISHED BY DIVERTING FLOW AROUND THE STREAM WORK AREAS (E.G. USING TEMPORARY PIPES), DIVERTING WATER THROUGH THE STREAM WORK AREAS (E.G. USING TEMPORARY PIPES), OR BY PUMPING FLOW AROUND OR THROUGH THE STREAM WORK AREAS. MATERIALS USED FOR THE DIVERSION SHALL CONFORM TO SECTION 553-2 OF THE NYS STANDARD SPECIFICATIONS. PAYMENT FOR THE TEMPORARY WATERWAY DIVERSION STRUCTURE SHALL BE MADE UNDER THE UNIT PRICE BID FOR ITEM 553.03000x.

DIVERTED STREAM FLOW SHALL NOT BE DIRECTED TO OR THROUGH UNSTABILIZED AREAS.

ONLY ONE PAYMENT SHALL BE MADE FOR THE TEMPORARY WATERWAY DIVERSION STRUCTURE. EVEN IF THE CONTRACTOR ELECTS TO INSTALL MULTIPLE DIVERSION STRUCTURE AT THE SITE. THE COST OF ADJUSTING, MOVING OR EXTENDING THE TEMPORARY WATERWAY DIVERSION STRUCTURE DURING CONSTRUCTION SHALL BE INCLUDED IN THE UNIT PRICE BID FOR ITEM 553.03000x, ALL WORK ASSOCIATED WITH THE INSTALLATION AND REMOVAL OF THE TEMPORARY WATERWAY DIVERSION STRUCTURE SHALL BE INCLUDED IN ITEM 553.03000x.

THE CONTRACTOR SHALL BE RESPONSIBLE FOR SELECTING THE SIZE LOCATION, MATERIALS AND SUITABILITY OF THE WATERWAY DIVERSION STRUCTURE(S) FOR THE INTENDED WORK OPERATION AND FOR MAINTAINING CONTINUOUS ELOW THROUGH OR AROUND THE STREAM WORK AREAS.


AT LEAST 35 CALENDAR DAYS PRIOR TO STARTING CONSTRUCTION, THE CONTRACTOR SHALL SUBMIT THREE COPIES OF THE TEMPORARY WATERWAY DIVERSION STRUCTURE PLAN FOR EACH WORK LOCATION TO THE ENGINEER AND CEC FOR REVIEW AND ACCEPTANCE. DIVERSION WORK PLANNED BETWEEN OCTOBER 1ST AND APRIL 30TH SHALL BE SUBJECT TO AN ADDITIONAL APPROVAL BY NYSDEC. NYSDOT STAFF SHOULD COORDINATE WITH NYSDEC ON STREAM DATE MODIFICATION REQUESTS FROM THE CONTRACTOR.

THE CONTRACTOR PROPOSES A WATER DIVERSION METHOD WHICH INVOLVES THE PUMPING OF STREAM WATER, ALL WATER INTAKE HOSES SHALL BE SCREENED TO PROTECT AQUATIC LIFE. THE SCREEN OPENING SIZE SHALL BE NO LARGER THAN 1/4 INCH (6mm) SQUARE.

THE CONTRACTOR MAY NEED TO INSTALL MATERIALS DOWNSTREAM OF THE STREAM WORK AREA TO PREVENT DIVERTED STREAM WATER FROM BACK FLOWING INTO THE WORK AREA. THE CONTRACTOR MAY ALSO NEED TO INSTALL MATERIALS TO PREVENT GROUNDWATER STORMWATER OR PRECIPITATION THAT ENTERS THE STREAM WORK AREA FROM EXITING THE WORK AREA IN A TURBID CONDITION. MATERIALS NECESSARY TO ACCOMPLISH THIS SHALL BE PAID FOR UNDER THE WATER DIVERSION STRUCTURE ITEM, OR ITEM 602.90100607.

SITE 13 - C270037 - NO WATER DIVERSION STRUCTURE, SEE ITEM 602.90100607

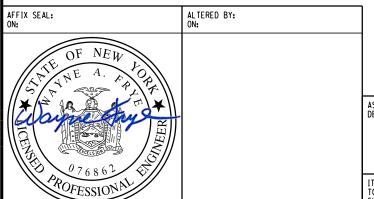SITE 14 - C240033 - ITEM 553.030001 SITE 15 - C270026 - ITEM 553.030002



ARGE CULVERT REPLACEMENTS AT MULTIPLE LOCATIONS PIN 2LC1.31 CONTRACT 6 S.H. 1355, S.H. 339, S.H. 562 AVA, GEORGETOWN, CITY OF ROME COUNTY: ONEIDA, MADISON REGION: 2

BRIDGES

CUL VERTS 240033 C270026

ALL DIMENSIONS IN ft UNLESS OTHERWISE NOTED ALL SITES

EROSION CONTROL NOTES

CONTRACT NUMBER D265553

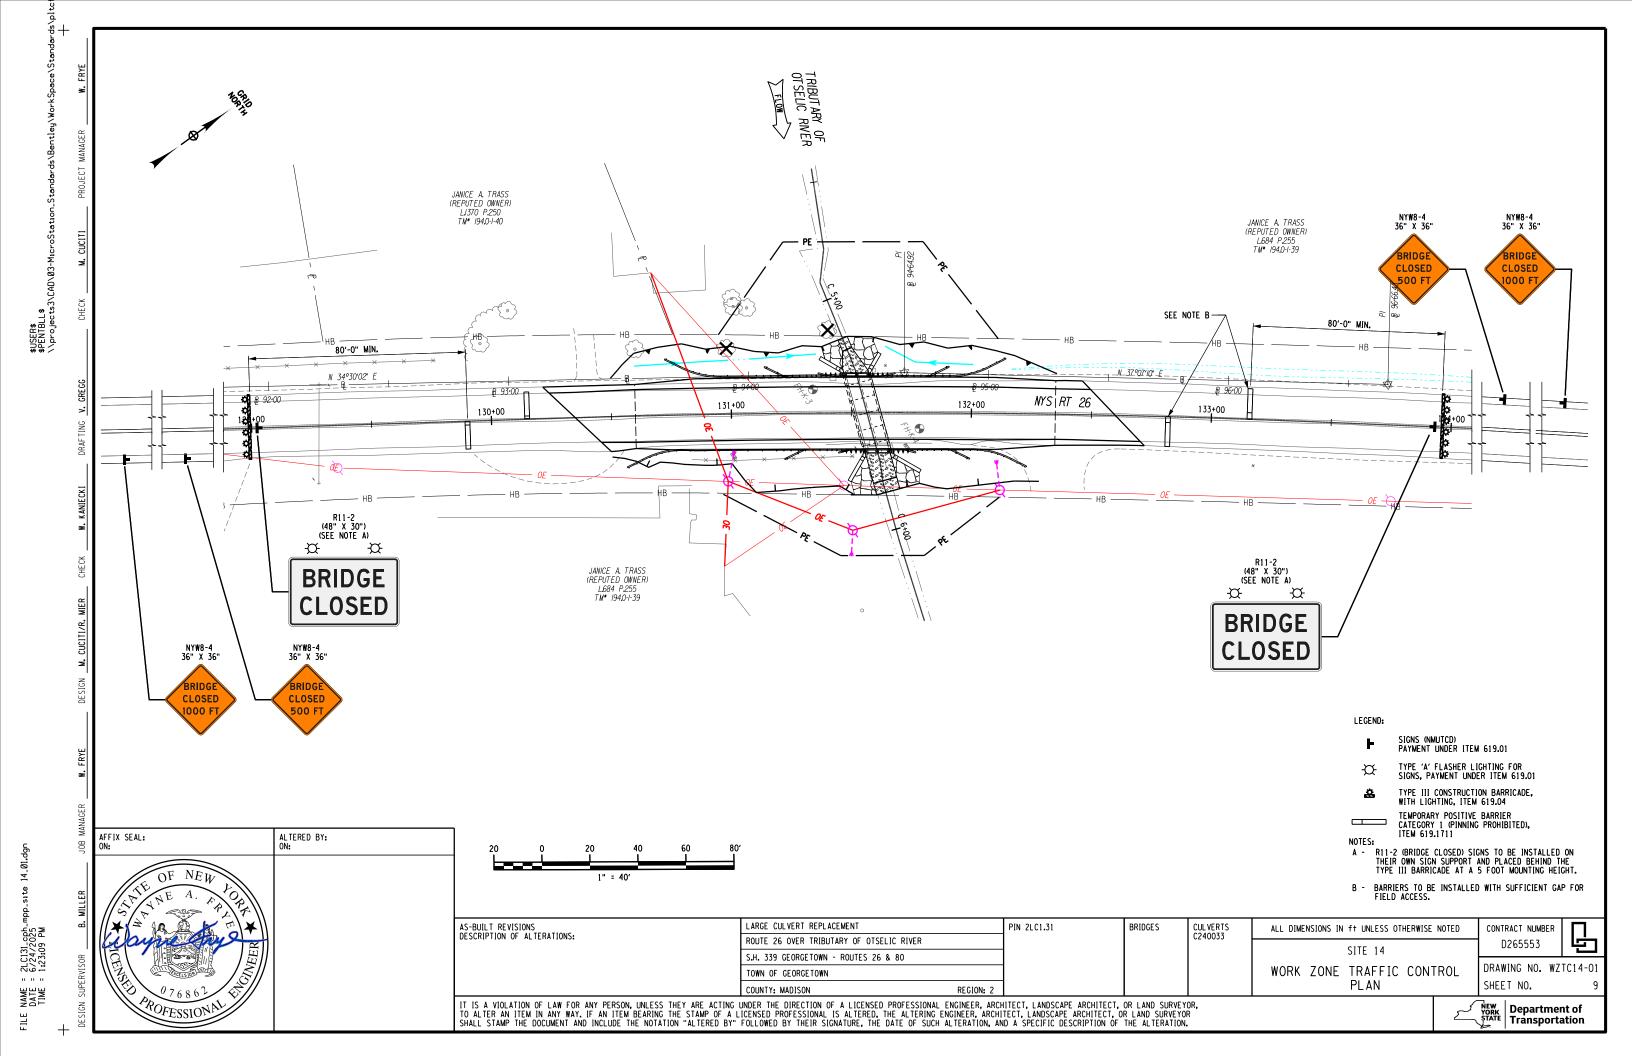
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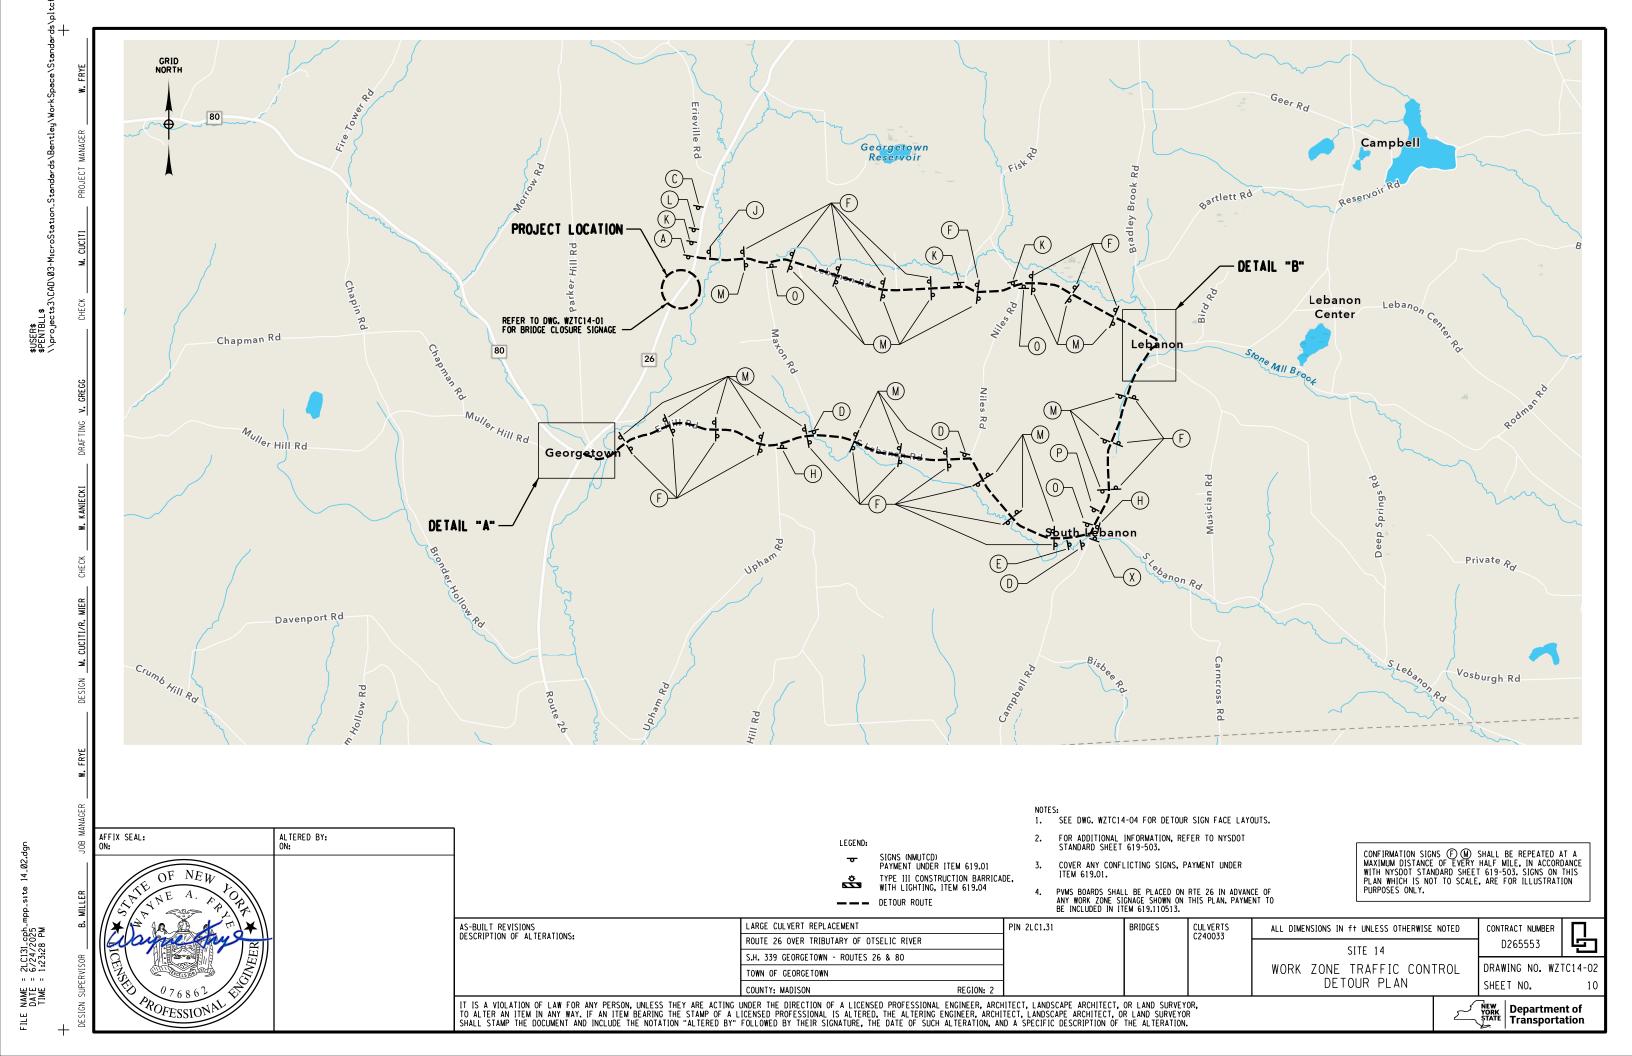
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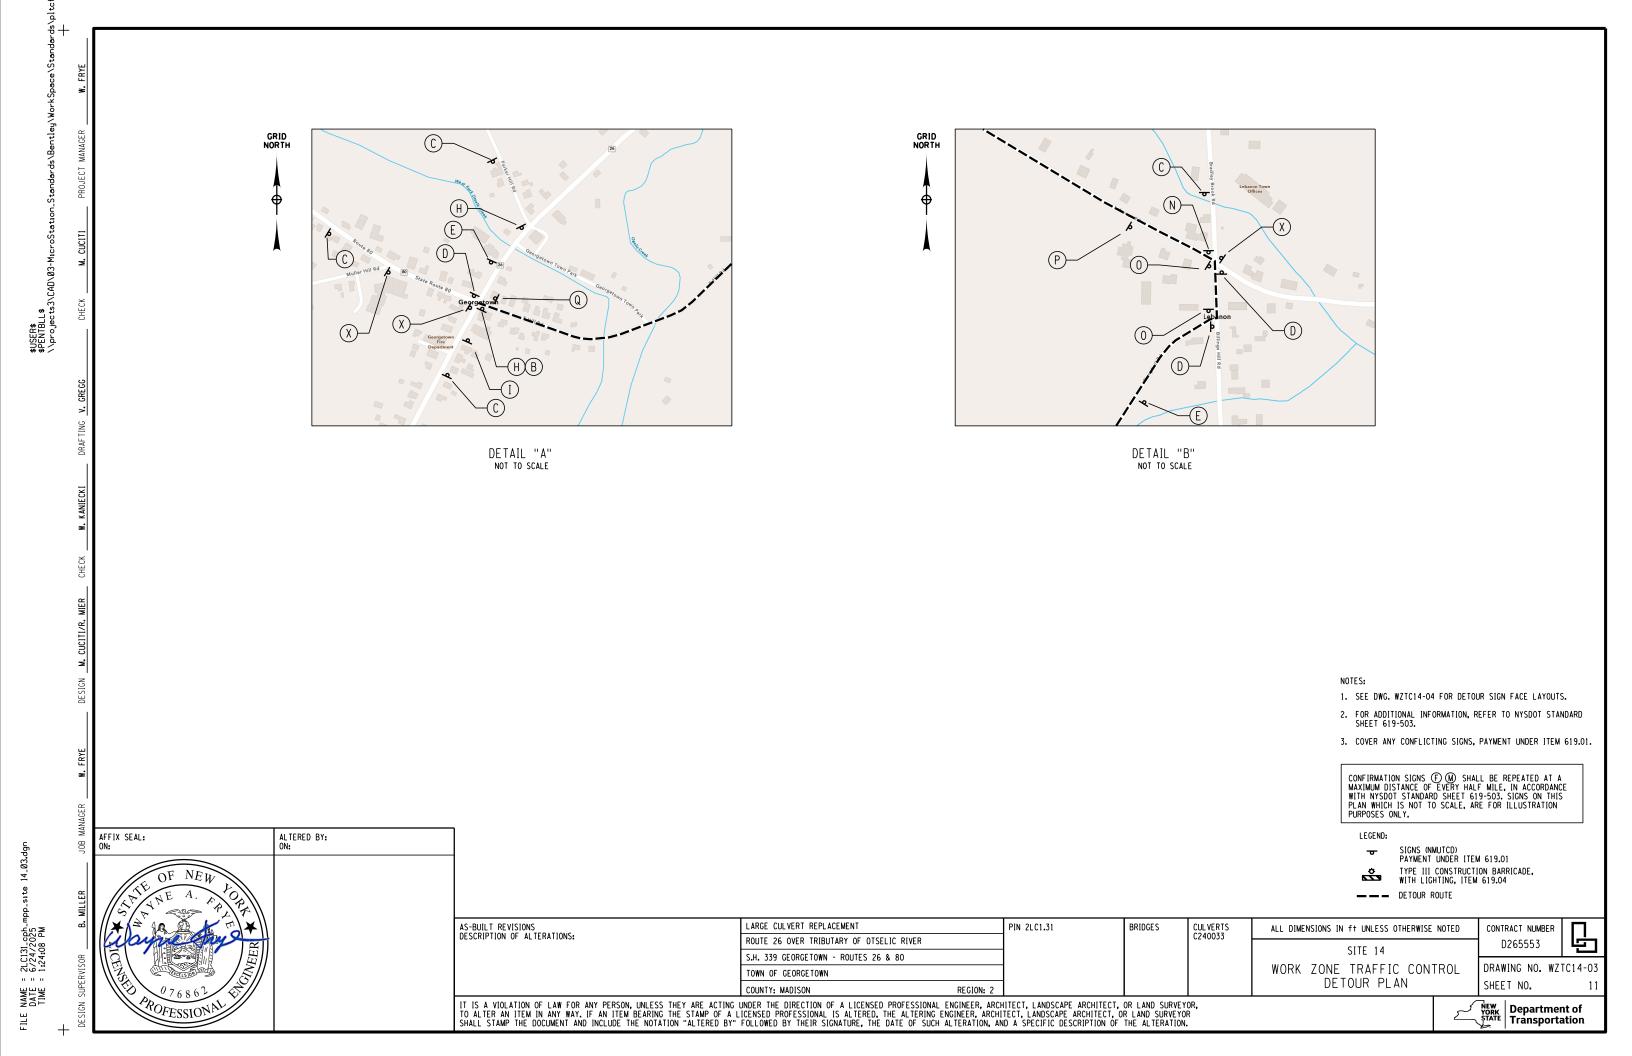
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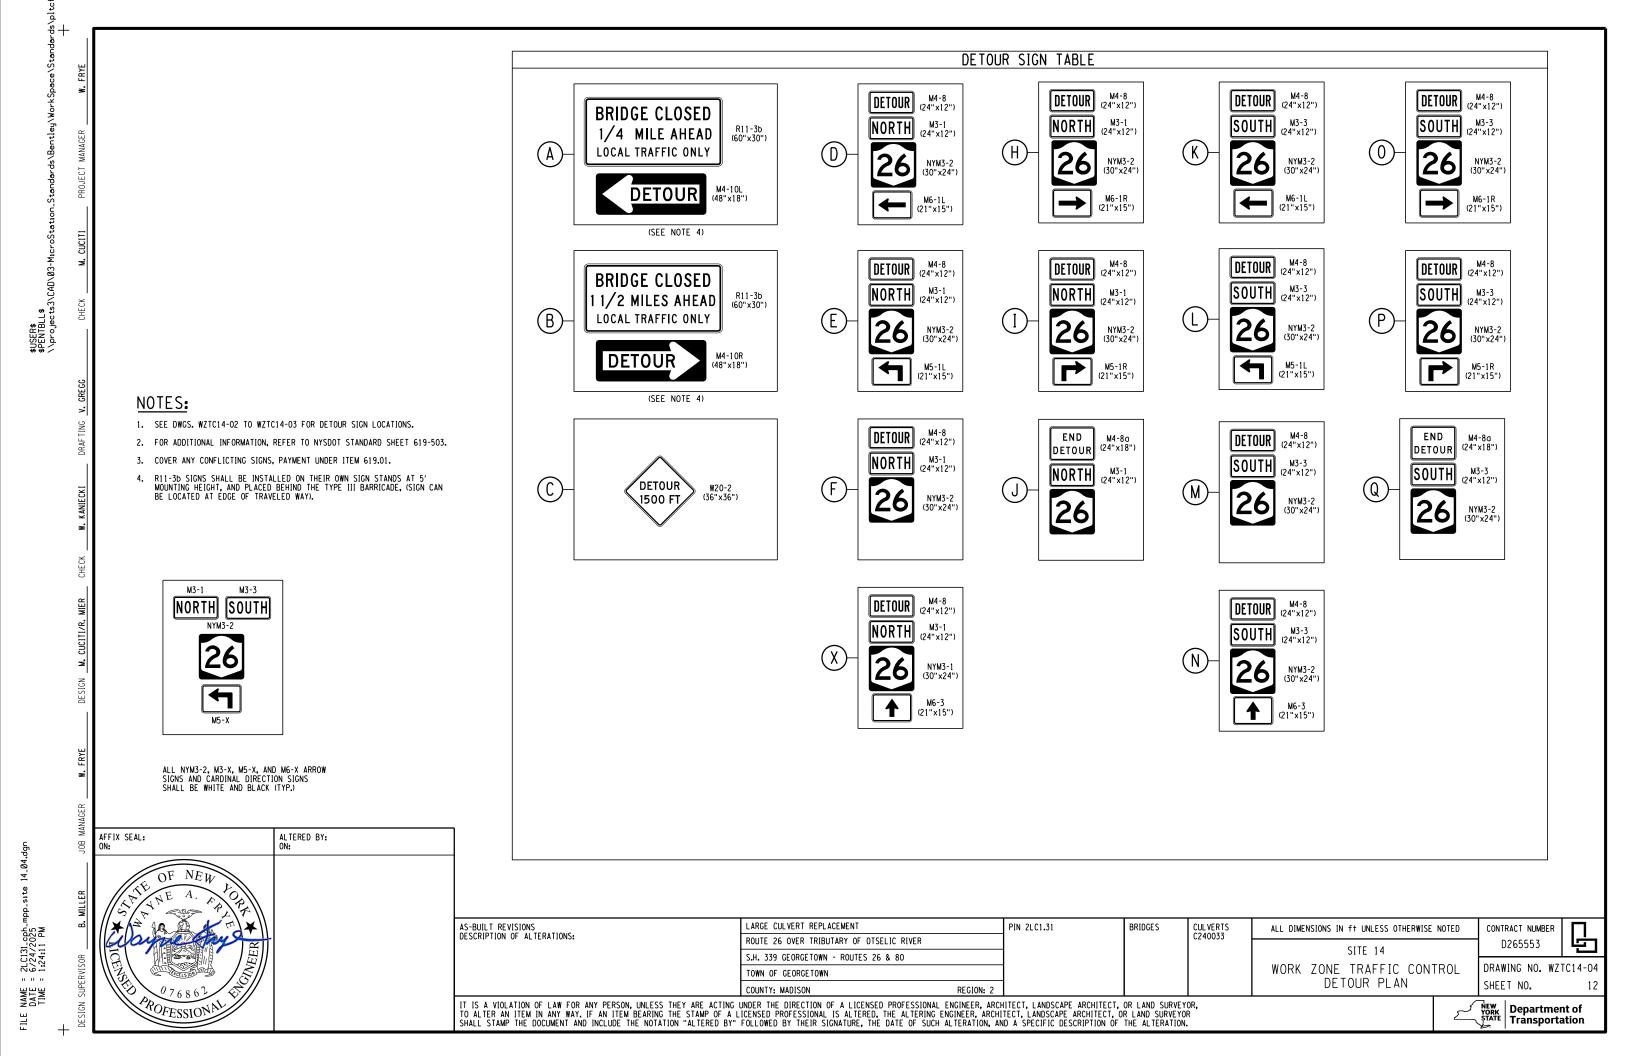
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AS-BUILT REVISIONS DESCRIPTION OF ALTERATIONS:









GENERAL NOTES:

- WORK ZONE TRAFFIC CONTROL SHALL BE PROVIDED IN ACCORDANCE WITH THE CURRENT MANUAL ON UNIFORM TRAFFIC CONTROL DEVICES (MUTCD), THE CURRENT VERSION OF SECTION 619 OF THE STANDARD SPECIFICATIONS, THE CURRENT WORK ZONE TRAFFIC CONTROL (619 SERIES) STANDARD SHEETS, ANY PROVISIONS CONTAINED IN THE PLANS AND/OR PROPOSAL OF THIS CONTRACT, AND AS DIRECTED BY THE ENGINEER.
- WORK ZONE TRAFFIC CONTROL FOR MOBILE OPERATIONS SHALL BE PROVIDED IN ACCORDANCE WITH NYSDOT STANDARD SHEETS 619-110 THRU 619-200.
- AS DEFINED IN SECTION 101-02 OF THE STANDARD SPECIFICATIONS, THE MUTCD CONSISTS OF THE NATIONAL MANUAL ON UNIFORM TRAFFIC CONTROL DEVICES FOR STREETS AND HIGHWAYS AND THE NEW YORK STATE SUPPLEMENT TO THE MANUAL ON UNIFORM TRAFFIC CONTROL

CHANGES TO THE WORK ZONE TRAFFIC CONTROL PLAN:

THE CONTRACTOR MUST SUBMIT TO THE ENGINEER, IN WRITING, PROPOSED REVISIONS TO THE WORK ZONE TRAFFIC CONTROL PLAN FOR REVIEW AND APPROVAL BY THE ENGINEER OR THEIR DESIGNEE A MINIMUM OF SEVEN (7) CALENDAR DAYS PRIOR TO THE PLANNED IMPLEMENTATION OF SUCH PROPOSED REVISIONS, EXCEPT FOR CHANGES THAT ALTER THE BASIC CONCEPT OR SCOPE OF THE WORK ZONE TRAFFIC CONTROL PLAN. SUCH CHANGES TO THE BASIC CONCEPT OR SCOPE MUST BE SUBMITTED TO THE ENGINEER FOR APPROVAL BY THE ENGINEER OR THEIR DESIGNEE A MINIMUM OF FORTY-FIVE (45) CALENDAR DAYS PRIOR TO IMPLEMENTATION OF SUCH DEVISIONS.

CONSTRUCTION EQUIPMENT AND VEHICLES:

- ALL VEHICLES AND EQUIPMENT WITHIN THE CONTRACT LIMITS AND ON TRAVEL LANES AND/OR SHOULDERS SHALL BE EQUIPPED WITH AND SHALL OPERATE A MINIMUM OF ONE AMBER ROTATING OR FLASHING LIGHT EMITTING DIODE (LED) BEACON VISIBLE FROM ALL DIRECTIONS FOR A MINIMUM OF 1000 FEET DURING DAYLIGHT. IF VISIBILITY OF A SINGLE BEACON IS BLOCKED BY A PORTION OF THE VEHICLE OR EQUIPMENT, ADDITIONAL BEACONS SHALL BE PROVIDED, BEACONS SHALL BE MOUNTED IN A MANNER WHICH DOES NOT CAUSE GLARE FOR DRIVERS USING THE ROADWAY OR THE OPERATOR OF THE VEHICLE OR EQUIPMENT.
- ALL BARRIER/SHADOW VEHICLES SHALL WEIGH A MINIMUM OF 18,000 LB AND SHALL BE EQUIPPED WITH TRUCK-MOUNTED IMPACT ATTENUATORS AND TRUCK-MOUNTED ARROW PANELS. IMPACT ATTENUATORS SHALL MEET THE REQUIREMENTS OF NCHEP 350 TEST LEVEL 3 AND SECTION 729-12 OF THE STANDARD SPECIFICATIONS. ARROW PANELS SHALL BE TRUCK-MOUNTED SERIES B OR C PANELS MEETING THE REQUIREMENTS OF SECTION 729-15 OF THE STANDARD SPECIFICATIONS AND SECTION 6F.61 OF THE MUTCD. THE PRICE OF TRUCK-MOUNTED IMPACT ATTENUATORS AND TRUCK-MOUNTED ARROW PANELS SHALL BE INCLUDED IN THE PRICE BID FOR THE RASIC WORK 70ME TRAFFIC CONTROL ITEM

PARKING OF CONSTRUCTION EQUIPMENT & VEHICLES AND STORAGE OF MATERIALS:

- CONSTRUCTION EQUIPMENT (INCLUDING LIGHT TOWERS, IF USED), VEHICLES AND MATERIALS SHALL BE PLACED OR STORED DURING NON-WORKING HOURS A MINIMUM OF 30 FEET FROM THE EDGE OF PAVEMENT OR BEHIND TEMPORARY CONCRETE BARRIER OR GUIDE RAIL. EQUIPMENT, VEHICLES AND MATERIALS STORED BEHIND TEMPORARY CONCRETE BARRIER OR GUIDE RAIL SHALL NOT BE PLACED OR STORED WITHIN THE APPROPRIATE DEFLECTION DISTANCE SHOWN IN TABLE 619-6, GUIDE RAIL AND TEMPORARY CONCRETE BARRIER STANDARD DEFLECTION DISTANCES, IN THE STANDARD SPECIFICATIONS.
- PRIVATE VEHICLES OWNED BY THE CONTRACTOR OR THE CONTRACTOR'S WORKERS SHALL BE PARKED, DURING WORKING AND NON-WORKING HOURS, IN ACCORDANCE WITH THE REQUIREMENTS IN THE PRECEDING PARAGRAPH.
- CONTRACTOR SHALL NOT UTILIZE THE FISH HATCHERY PARKING AREA. PARKING AREA SHALL REMAIN FULLY OPEN AND ACCESSIBLE TO PUBLIC FOR DURATION OF PROJECT UNLESS COORDINATED WITH NYSDEC AND FHWA.

CHANNELIZING DEVICES:

EXPIRATION: 10/31/2025

- RECOMMENDED PRACTICES FOR CHANNELIZING DEVICES ARE PROVIDED IN THE MUTCD AND SECTION 619-3.02 J of the Standard specifications.
- TALL CONES, MEETING THE REQUIREMENTS OF SECTION 729-02 OF THE STANDARD SPECIFICATIONS, ARE NORMALLY ADEQUATE FOR WORK ZONES SET UP AND REMOVED ON A DAILY BASIS DURING DAYLIGHT HOURS. DRUMS OR OVERSIZED VERTICAL PANELS ARE PREFERRED FOR ALL OTHER WORK ZONES AND AT ANY LOCATIONS WHERE THE RISK OF INTRUSION IS HIGH, AS
- THE CONTRACTOR SHALL MAKE FREQUENT CHECKS COMMENSURATE WITH TRAFFIC CONDITIONS TO IDENTIFY AND RESET CHANNELIZING DEVICES DISLODGED BY TRAFFIC.

S-BUILT REVISIONS

ESCRIPTION OF ALTERATIONS:

AFFIX SEAL: GREENMAN - PEDERSEN, INC ON: JUNE 23, 2025	ALTERED BY: GREENMAN - PEDERSEN, INC ON:	
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CONDITION OF TRAFFIC CONTROL DEVICES:

- AT THE START OF CONTRACT WORK, ALL CONES, TEMPORARY TUBULAR MARKERS, DRUMS, CONSTRUCTION BARRICADES, VERTICAL PANELS, WARNING LIGHTS, ARROW PANELS, PORTABLE VARIABLE MESSAGE SIGNS, PAVEMENT MARKING TAPE AND RAISED PAVEMENT MARKERS SHALL APPEAR IN "ACCEPTABLE" CONDITION AS DESCRIBED AND PICTURED IN THE CURRENT EDITION OF THE AMERICAN TRAFFIC SAFETY SERVICES ASSOCIATION (ATSSA) MANUAL QUALITY GUIDELINES FOR TEMPORARY TRAFFIC CONTROL DEVICES. THESE DEVICES SHALL NOT BE ALLOWED TO FALL BELOW THE "MARGINAL" CONDITION AT ANY TIME DURING THE LIFE OF THE CONTRACT.
- ALL SIGNS SHALL BE IN "ACCEPTABLE" CONDITION AS DESCRIBED IN THE ATSSA MANUAL QUALITY GUIDELINES FOR TEMPORARY TRAFFIC CONTROL DEVICES THROUGHOUT THE LIFE OF THE
- RIGID SIGN PANELS SHALL HAVE A MINIMUM MOUNTING HEIGHT OF 7 FEET, MEASURED FROM THE ROADWAY SURFACE TO THE BOTTOM OF THE LOWEST SIGN PANEL. FOR SIGNS INCORPORATING AN AUXILIARY PANEL BELOW THE PRIMARY PANEL, THE MINIMUM MOUNTING HEIGHT SHALL BE 6 FEET. FLEXIBLE PANEL AND LIGHTWEIGHT RIGID PANELS SHALL BE MOUNTED IN ACCORDANCE

CONDITION OF TRAFFIC CONTROL DEVICES:

- 16. AS DESCRIBED BELOW, THE TIME RESTRICTIONS CAN BE ADJUSTED BY THE ENGINEER AS TRAFFIC CONDITIONS WARRANT.
- THE ENGINEER IS AUTHORIZED TO ORDER ADDITIONAL TIME RESTRICTIONS ON ALL ROADS OF UP TO ONE HOUR PER WORK DAY IF TRAFFIC CONDITIONS WARRANT. THERE SHALL BE NO COST TO THE STATE FOR SUCH ADDED RESTRICTIONS. THE CONTRACTOR SHALL NOT HAVE ANY DELAY CLAIMS, AGAINST THE STATE IF THE ENGINEER ORDERS UP TO ONE HOUR OF ADDITIONAL TIME
- THE ENGINEER IS AUTHORIZED TO REDUCE TIME RESTRICTIONS AS TRAFFIC CONDITIONS
- THE HOLIDAY RESTRICTIONS ARE DETAIL IN THE "SPECIAL NOTE TEMPORARY LANE CLOSURE. THE CONTRACTOR WILL NOT BE ALLOWED TO IMPLEMENT ANY TEMPORARY LANE, RAMP OR SHOULDER CLOSURES OR OTHERWISE DISRUPT TRAFFIC IN ANY WAY DURING THE HOLIDAYS STATED IN "SPECIAL NOTE - TEMPORARY LANE CLOSURE RESTRICTIONS FOR MAJOR HOLIDAYS

FLAGGER EQUIPMENT AND STATIONS:

- 20. TO INSURE A PROPER LEVEL OF TRAFFIC SAFETY, EACH FLAGGER SHALL BE EQUIPPED WITH A TWO-WAY RADIO DEVICE. THE COST SHALL BE INCLUDED IN THE BASIC WORK ZONE TRAFFIC
- ALL FLAGGER STATIONS SHALL BE ENHANCED WITH ADDITIONAL CONES AND A FLAG TREE AS SHOWN ON THE WORK ZONE TRAFFIC CONTROL (619 SERIES) STANDARD SHEETS AND AS DIRECTED BY THE ENGINEER. THE FLAG TREE SHALL MEET THE REQUIREMENTS OF SECTION SHALL BE USED FOR ALL FLAGGER STATIONS EXCEPT THOSE THAT ARE CONSTANTLY MOVING. ALL COSTS ASSOCIATED WITH THESE REQUIREMENTS SHALL BE INCLUDED UNDER THE BASIC WORK ZONE TRAFFIC CONTROL ITEM 619.01.
- FLAGGER SIGNS ARE TO BE USED ONLY WHEN A FLAGGER IS ACTUALLY PRESENT AND VISIBLE TO THE MOTORIST. FLAGGER SIGNS SHALL BE COVERED OR REMOVED AT ALL OTHER TIMES.
- THE COST OF UTILIZING APPROVED REGULATORY OR ADVISORY SPEED ZONE SIGNS, AND COVERING EXISTING SIGNS, SHALL BE INCLUDED IN THE PRICE BID FOR BASIC WORK ZONE TRAFFIC CONTROL, ITEM 619.01.
- 24. IN ACCORDANCE WITH SECTION 619-3.02 J 6 OF THE STANDARD SPECIFICATIONS, THE CONTRACTOR SHALL USE DRUMS, TALL CONES, EXTRA TALL CONES, TEMPORARY TUBULAR MARKERS, VERTICAL PANELS, OVERSIZED VERTICAL PANELS, TYPE II CONSTRUCTION BARRICADES AND/OR TYPE III CONSTRUCTION BARRICADES TO DELINEATE THE EDGE OF SHOULDER IN LOCATIONS WHERE GUIDE RAIL IS REMOVED. THE CENTER-TO-CENTER SPACING BETWEEN CHANNELIZING DEVICES SHALL NOT EXCEED 80 FEET WHERE THE SHOULDER WIDTH IS 4 FEET OR GREATER, AND SHALL NOT EXCEED 40 FEET WHERE THE SHOULDER WIDTH IS LESS THAN 4 FEET. A MINIMUM OF THREE (3) DEVICES SHALL BE PROVIDED FOR EACH INDIVIDUAL RUN OF GUIDE RAIL THAT IS REMOVED.

TEMPORARY TRAFFIC SIGNALS:

- THE CONTRACTOR SHALL COORDINATE ALL UTILITY INVOLVEMENT AND/OR CONFLICTS WITH THE
- THE CONTRACTOR SHALL STAKE OUT AND VERIFY ALL COMPONENTS OF THE TEMPORARY TRAFFIC SIGNAL SYSTEM PRIOR TO INSTALLATION. THE ENGINEER SHALL APPROVE THE FINAL PLACEMENT.
- NO CHANGES IN THE DESIGNED TEMPORARY SIGNAL OPERATION OR TIMING PLAN SHALL BE PERMITTED WITHOUT APPROVAL OF THE PROJECT ENGINEER. A REST-IN-RED CONDITION SHALL BE REQUESTED FOR ALL SIGNAL PHASES.
- PRIOR TO THE COMMENCEMENT OF ANY WORK ON THE TEMPORARY TRAFFIC SIGNAL SYSTEM, AN ON-SITE, PRE-CONSTRUCTION MEETING SHALL TAKE PLACE. ATTENDEES SHALL INCLUDE THE ENGINEER, PRIME CONTRACTOR, APPROPRIATE SUB CONTRACTORS AND APPROPRIATE UTILITY

MOHAWK RIVER TRAIL

PHASE 3

CITY OF ROME

TEMPORARY TRAFFIC SIGNALS (CONT):

- PRIOR TO SIGNAL ACTIVATION, A FUNCTIONAL TEST OF THE TRAFFIC SIGNAL CONTROL EQUIPMENT SHALL BE PERFORMED TO DEMONSTRATE THAT EVERY PART OF THE SIGNAL SYSTEM OPERATES SATISFACTORILY. THE FUNCTIONAL TEST SHALL BE PERFORMED THE PRESENCE OF THE ENGINEER AND THE TRAFFIC SIGNAL CREW ENGINEER IN CHARGE. TIMING AND CLEARANCE
- SEE CURRENT NYSDOT STANDARD SHEET 619-524 FOR ADDITIONAL TEMPORARY TRAFFIC SIGNAL NOTES.

PROJECT SPECIFIC NOTES:

- 31. THE MINIMUM WIDTH OF TRAVEL LANES SHALL BE 12 FEET UNLESS OTHERWISE DIRECTED BY
- A TOTAL OF 2 VARIABLE MESSAGE SIGNS SHALL BE PROVIDED AND UTILIZED FOR THE PROJECT. AT A MINIMUM, THEY SHALL BE INSTALLED 1 WEEK IN ADVANCE OF ANY ROAD WORK AND DURING THE FIRST 1 WEEK OF CONSTRUCTION OR A.O.B.E. ADDITIONALLY, VARIABLE MESSAGE SIGNS ARE TO BE INSTALLED I WEEK PRIOR TO AND DURING THE CLOSURES OF NY ROUTE 46. THE COST OF THE SIGNS ARE TO BE PAID FOR UNDER ITEM 619.110513-PORTABLE VARIABLE MESSAGE SIGN (PYMS) STANDARD SIZE FULL MATRIX (LED) NO OPTIONAL EQUIPMENT SPEC, CELULIA PLOCAL PEO.
- 33. THE CONTRACTOR IS ADVISED THAT THROUGHOUT THE DURATION OF THE PROJECT, NIGHTTIME CONSTRUCTION WILL NOT BE PERMITTED.

SEQUENCE OF CONSTRUCTION:

- 34. THE SEQUENCE OF CONSTRUCTION PROVIDED IS MEANT TO SERVE AS A GENERAL ORDER OF CONSTRUCTION OPERATIONS, AND IS SUBJECT TO REVISION. THE CONTRACTOR SHALL PROVIDE A DETAILED SCHEDULE, AS WELL AS ANY PROPOSED REVISIONS TO THE SEQUENCE TO THE ENGINEER-IN-CHARGE NO LESS THAN TWO (2) WEEKS IN ADVANCE OF THE BEGINNING OF THE WORK. NOTICE SHALL BE GIVEN TO ALL RESIDENTS OF FISH HATCHERY ROAD & CITY OF ROME NO LESS THAN TWO (2) WEEKS IN ADVANCE OF THE ROAD BEING CLOSED AND THE DETOUR BEING PUT IN
- 35. THE RECOMMENDED SEQUENCE OF CONSTRUCTION IS AS FOLLOWS:

- INSTALL ALL DETOUR SIGNAGE AS SHOWN IN THE DETOUR PLAN ON DWG WZTC15-02 AND WZTC15-03. SIGNAGE SHALL CONFORM WITH ALL APPLICABLE NYSDOT AND MUTCD STANDARDS CLOSE FISH HATCHERY ROAD AT THE INTERSECTION OF NY ROUTE 46 AND THE INTERSECTION OF WILLIAMS ROAD PER DWG WZTC15-02 AND WZTC15-05 PLACE AND TEST THE TEMPORARY TRAFFIC SIGNALS AS SHOWN ON DWG WZTC15-06 AFTER THE SIGNALS HAVE BEEN TESTED AND APPROVED, THE TEMPORARY POSITIVE BARRIER AND CHANNELIZING DEVICES SHALL BE SET IN PLACE TO CREATE A ONE-LANE TWO-WAY PROADMYST CONDITION.

PHASE 1 CONTRACT WORK TO BE COMPLETED:

- INSTALL EROSION AND SEDIMENT CONTROL DEVICES EXCAVATE AND INSTALL TEMPORARY GRSS WALL SYSTEM AT PEDESTRIAN TUNNEL
- INSTALL PHASE 1 OF CULYERT CZ70026
 INSTALL TEMPORARY GRSS WALL SYSTEM AT CULVERT CZ70026
 CONSTRUCT TEMPORARY NY ROUTE 46 BYPASS ROADWAY, PLACE TEMPORARY POSITIVE BARRIER
- ON THE NY ROUTE 46 BYPASS ROADWAY

PHASE 2 WORK 70NF:

- CLOSURE OF FISH HATCHERY ROAD AND PROPOSED DETOUR TO REMAIN IN PLACE TEMPORARY TRAFFIC SIGNALS TO REMAIN IN PLACE TEMPORARY POSITIVE BARRIER INSTALLED AS PART OF PHASE 1 TO BE REMOVED TO TRAVEL ON THE NY ROUTE 46 BYPASS ROADWAY IN A ONE-LANE THOUSAND PARDWAY COUNTYION. TWO-WAY ROADWAY CONDITION.

PHASE 2 CONTRACT WORK TO BE COMPLETED:

- INSTALL PEDESTRIAN TUNNEL C******
- INSTALL PEDESTRIAN INDIRECT CZ70026
 RESTORE NY ROUTE 46 ROADWAY TO MATCH ORIGINAL CONDITION, INCLUDING PAVEMENT SECTION, GUIDE RAILING, STRIPING, ETC.

BRIDGES

PIN 2650.61 / 2LC1.31

UTILQLVL C

- CLOSURE OF FISH HATCHERY ROAD AND PROPOSED DETOUR TO REMAIN IN PLACE TEMPORARY TRAFFIC SIGNALS TO BE REMOVED, RETURNING THE ROADWAY TO NORMAL
- OFERNATION
 TEMPORARY POSITIVE BARRIER INSTALLED AS PART OF PHASE 2 TO BE REMOVED
 PHASE 3 TEMPORARY POSITIVE BARRIER AND CHANNELIZING DEVICES TO BE PLACED PER DWG

PHASE 3 CONTRACT WORK TO BE COMPLETED:

C260199

- REMOVE TEMPORARY NY ROUTE 46 BYPASS ROADWAY INSTALL PROPOSED MRT SHARED USE TRAIL, INCLUDING RETAINING WALLS, ASPHALT, FENCING, SIGNAGE, ETC.
- FISH HATCHERY ROAD TO MATCH ORIGINAL CONDITION, INCLUDING PAVEMENT
- SECTION, GUIDE RAILING, STRIPING, ETC.



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SITE 15 - WORK ZONE TRAFFIC CONTROL



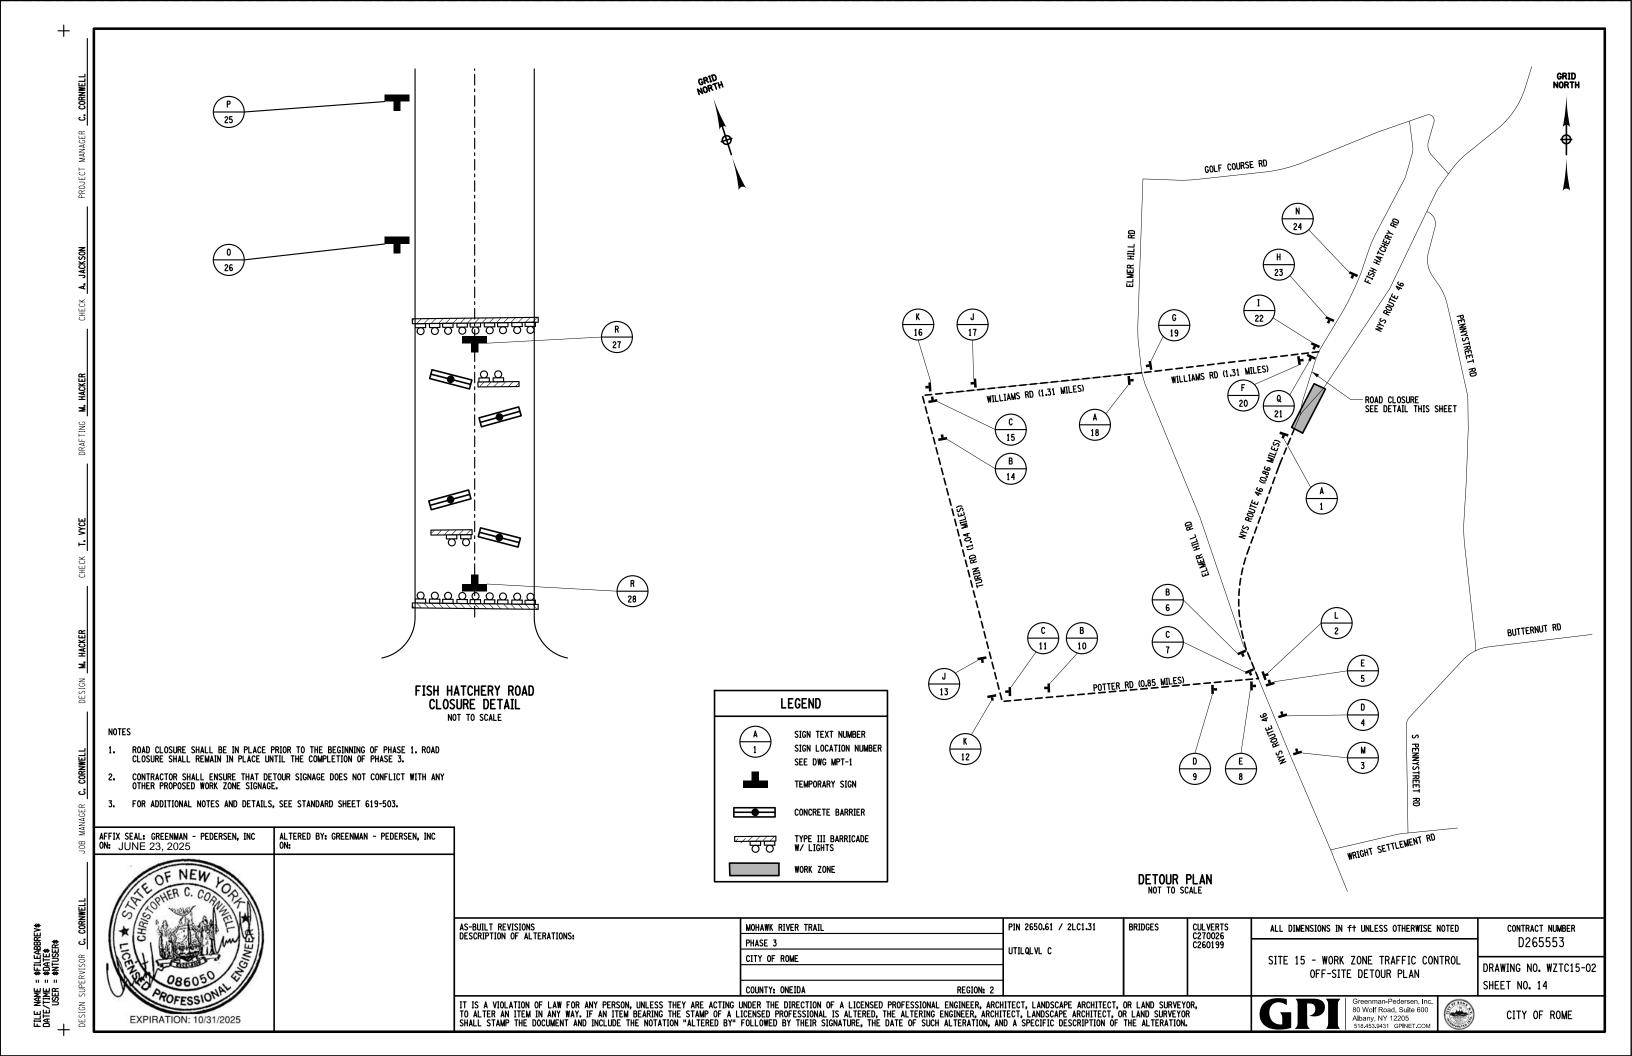
SHEET NO. 13

CONTRACT NUMBER

D265553

DRAWING NO. WZTC15-01

COUNTY: ONEIDA IT IS A VIOLATION OF LAW FOR ANY PERSON, UNLESS THEY ARE ACTING UNDER THE DIRECTION OF A LICENSED PROFESSIONAL ENGINEER, ARCHITECT, LANDSCAPE ARCHITECT, OR LAND SURVEYOR, TO ALTER AN ITEM IN ANY WAY. IF AN ITEM BEARING THE STAMP OF A LICENSED PROFESSIONAL IS ALTERED, THE ALTERING ENGINEER, ARCHITECT, LANDSCAPE ARCHITECT, OR LAND SURVEYOR SHALL STAMP THE DOCUMENT AND INCLUDE THE NOTATION "ALTERED BY" FOLLOWED BY THEIR SIGNATURE, THE DATE OF SUCH ALTERATION, AND A SPECIFIC DESCRIPTION OF THE ALTERATION.





Fish Hatchery Rd 72" X 12" 4, 9 **DETOUR** M4-9LA 30" X 24" Fish Hatchery Rd D3-1 72" X 12" **DETOUR** 5, 8 30" X 24" M4-9L 72" X 12" D3-1 Fish Hatchery Rd 20 END DETOUR M4-8A 30" X 24" AFFIX SEAL: GREENMAN - PEDERSEN, INC ON: JUNE 23, 2025 ALTERED BY: GREENMAN - PEDERSEN, INC ON: AS-BUILT REVISIONS DESCRIPTION OF ALTERATIONS: CUL VERTS C270026 C260199 MOHAWK RIVER TRAIL PIN 2650.61 / 2LC1.31 BRIDGES ALL DIMENSIONS IN ft UNLESS OTHERWISE NOTED CONTRACT NUMBER D265553 PHASE 3 UTILQLVL C CITY OF ROME SITE 15 - WORK ZONE TRAFFIC CONTROL DRAWING NO. WZTC15-03 OFF-SITE DETOUR SIGNS SHEET NO. 15 COUNTY: ONEIDA IT IS A VIOLATION OF LAW FOR ANY PERSON, UNLESS THEY ARE ACTING UNDER THE DIRECTION OF A LICENSED PROFESSIONAL ENGINEER, ARCHITECT, LANDSCAPE ARCHITECT, OR LAND SURVEYOR, TO ALTER AN ITEM IN ANY WAY. IF AN ITEM BEARING THE STAMP OF A LICENSED PROFESSIONAL IS ALTERED, THE ALTERING ENGINEER, ARCHITECT, LANDSCAPE ARCHITECT, OR LAND SURVEYOR SHALL STAMP THE DOCUMENT AND INCLUDE THE NOTATION "ALTERED BY" FOLLOWED BY THEIR SIGNATURE, THE DATE OF SUCH ALTERATION, AND A SPECIFIC DESCRIPTION OF THE ALTERATION. Greenman-Pedersen, Inc. 80 Wolf Road, Suite 600 Albany, NY 12205 518.453.9431 GPINET.COM CITY OF ROME EXPIRATION: 10/31/2025


TEXT NO. LOCATION TEXT MUTCD NO. SIZE Fish Hatchery Rd D3-1 72" X 12" 1, 18 DETOUR M4-9 30" X 24" Fish Hatchery Rd D3-1 72" X 12" 6, 10, 14 DETOUR 30" X 24" M4-9RA Fish Hatchery Rd D3-1 72" X 12" 7, 11, 15 **DETOUR** M4-9R 30" X 24"

,	LOCATION	техт	MUTCD NO.	:	SIZE	:
		DETOUR	M4-8P	24"	х	12"
G	19	46	M1-5	36"	x	36"
	1	1	M6-3P	21"	х	15"
		DETOUR	M4-8P	24"	x	12"
Н	23	46	M1-5	36"	х	36"
	1		M5-1P	21"	x	15"
		DETOUR	M4-8P	24"	х	12"
I	22	46	M1-5	36"	x	36"
	1	→	M6-1P	21"	х	15"
		DETOUR	M4-8P	24"	x	12"
J	13, 17	46	M1-5	36"	x	36"
	2	4	M5-1P	21"	х	15"
	,	DETOUR	M4-8P	24"	х	12"
К	12, 16	46	M1-5	36"	х	36"
	2	←	M6-1P	21"	х	15"

TEXT NO.	LOCATION		ТЕХТ	MUTCD NO.		SIZE	Ē
	2 -		END DETOUR	M4-8A	24"	х	18"
		1	46	M1-5	36"	х	36"
M	3 -		Fish Hatchery Rd	D3-1	72"	х	12"
IVI	3	1	DETOUR 1500 FT	W20-2	36"	х	36"
N	24	1	DETOUR 1500 FT	W20-2	36"	x	36"
			Fish Hatchery Rd	D3-1	72"	х	12"
0	26	1	ROAD CLOSED 500 FT	W20-3	36"	х	36"
	25		Fish Hatchery Rd	D3-1	72"	х	12"
P	25	1	CLOSED 1000 FT	W20-3	36"	х	36"
	21		DETOUR	M4-10R	48"	x	18"
Q	21	1	ROAD CLOSED 0.15 MILES AHEAD LOCAL TRAFFIC ONLY	R11-3A	60"	х	30"
R	27, 28	2	ROAD CLOSED	R11-2R	60"	×	30"

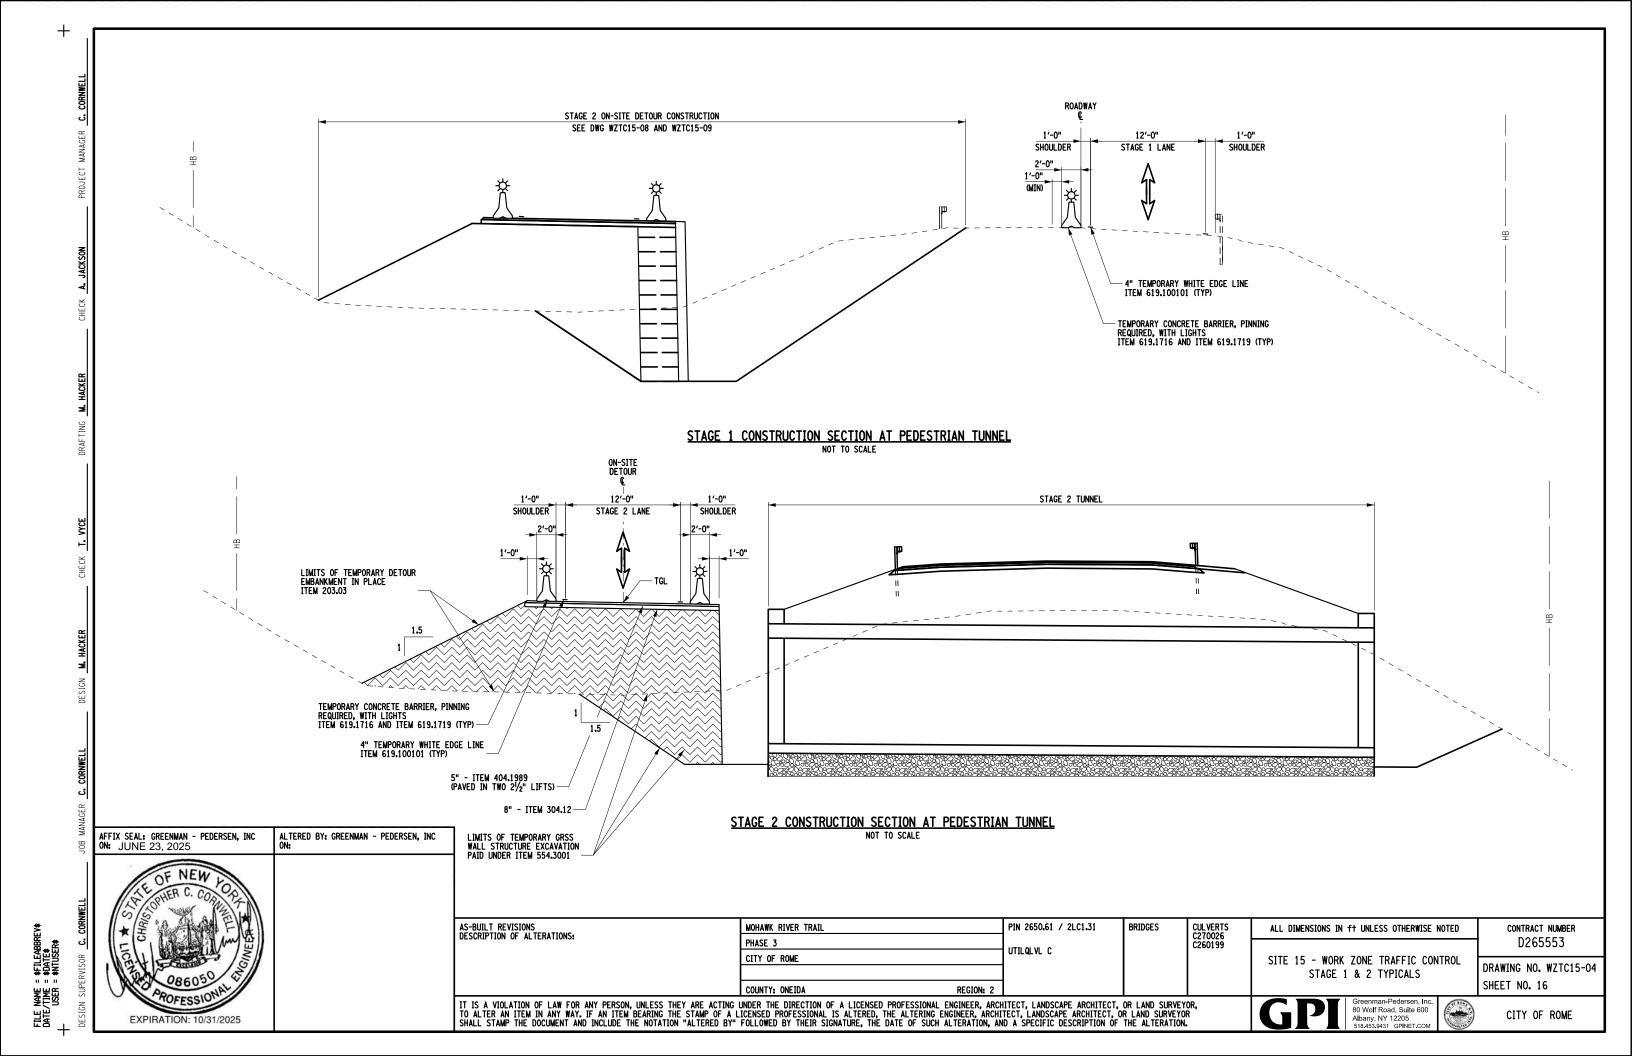

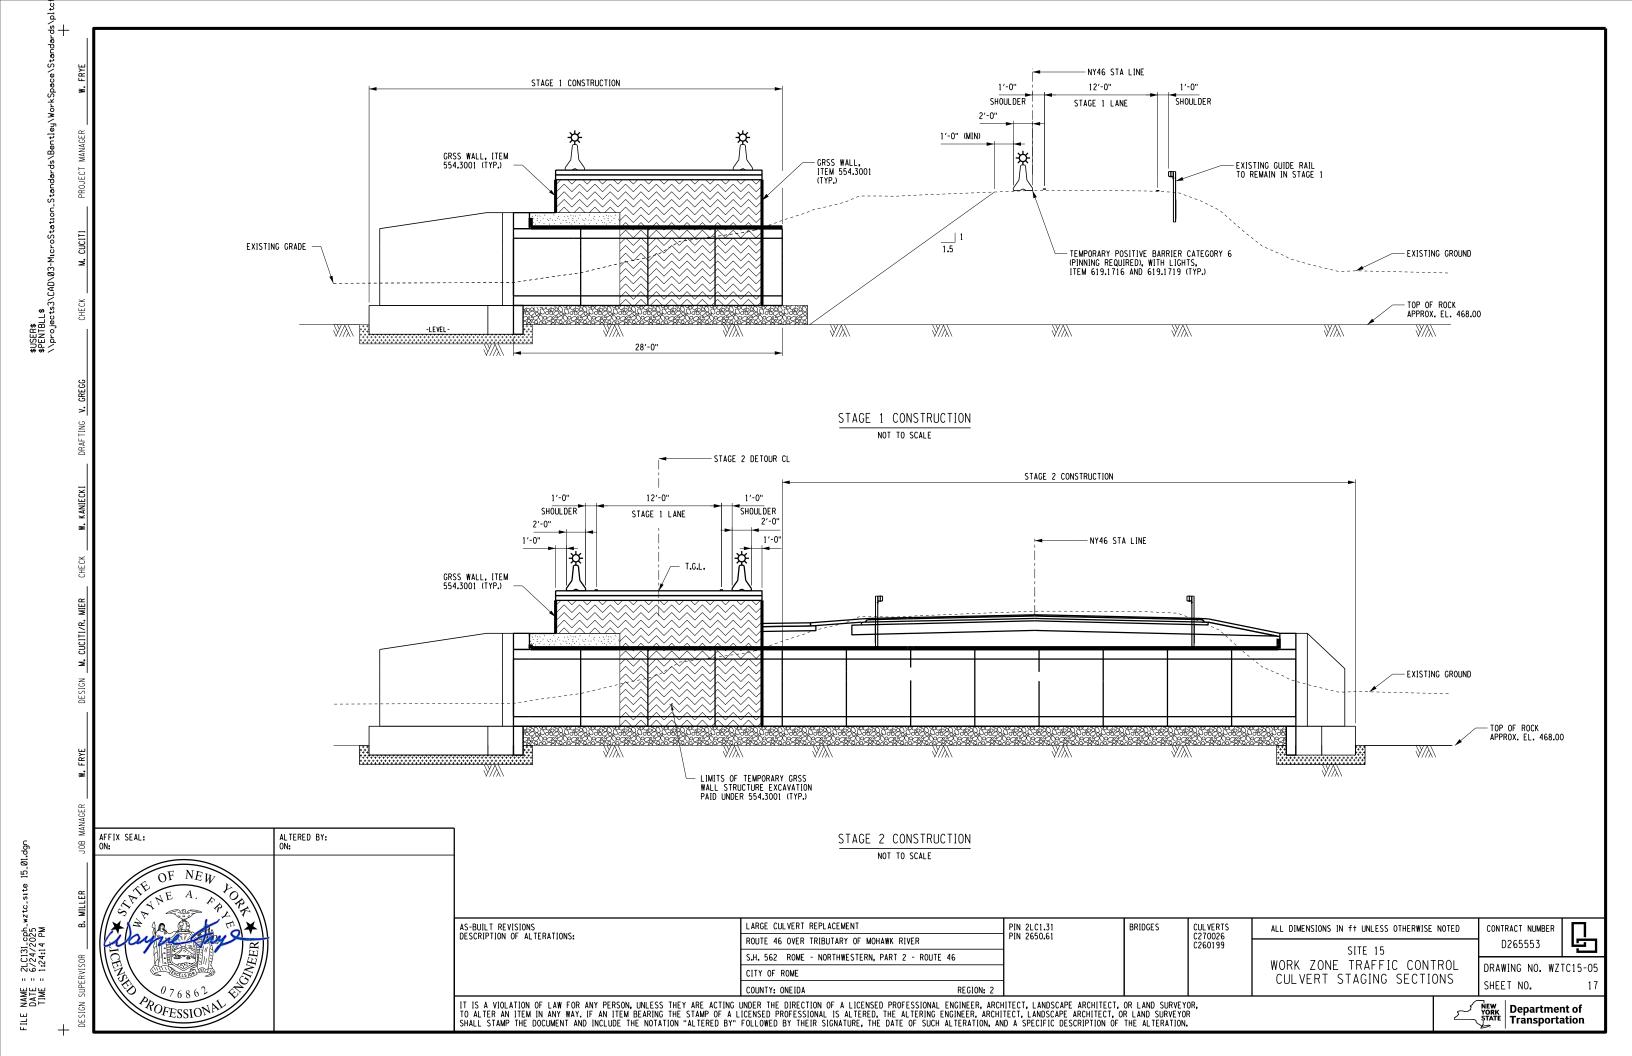

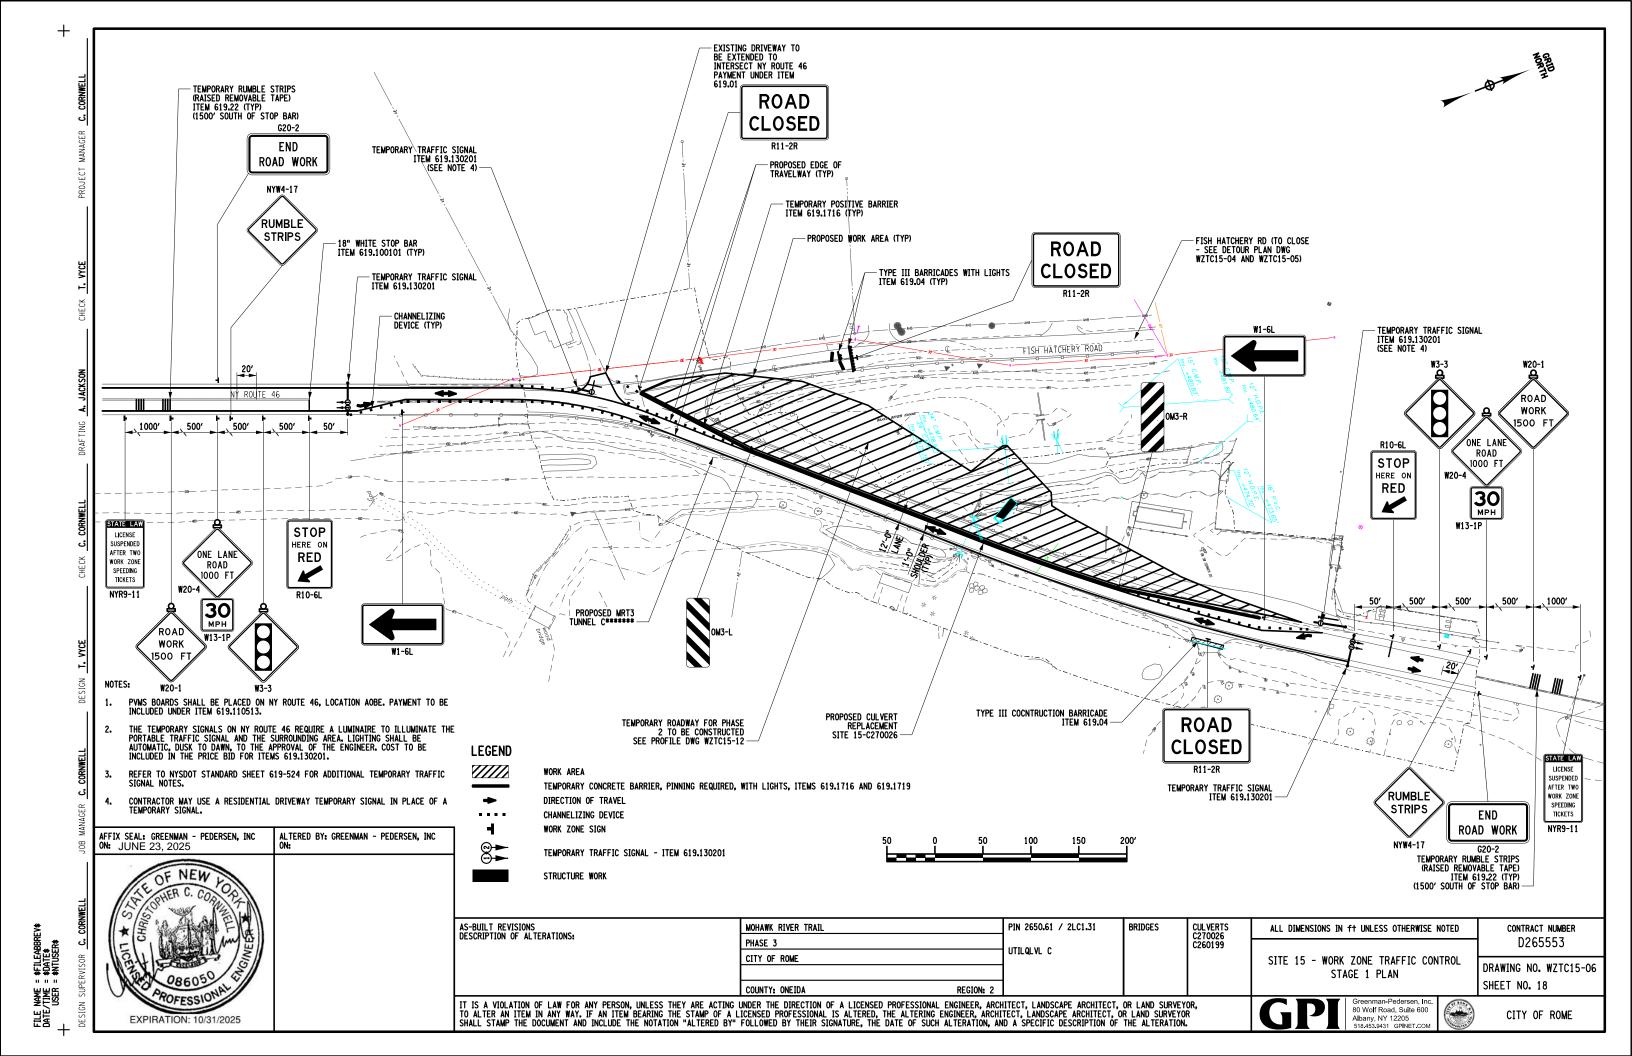

AFFIX SEAL: GREENMAN - PEDERSEN, INC ON: JUNE 23, 2025 ALTERED BY: GREENMAN - PEDERSEN, INC ON: EXPIRATION: 10/31/2025

AS-BUILT REVISIONS DESCRIPTION OF ALTERATIONS: UTILQLVL C CITY OF ROME COUNTY: ONEIDA IT IS A VIOLATION OF LAW FOR ANY PERSON, UNLESS THEY ARE ACTING UNDER THE DIRECTION OF A LICENSED PROFESSIONAL ENGINEER, ARCHITECT, LANDSCAPE ARCHITECT, OR LAND SURVEYOR, TO ALTER AN ITEM IN ANY WAY. IF AN ITEM BEARING THE STAMP OF A LICENSED PROFESSIONAL IS ALTERED, THE ALTERING ENGINEER, ARCHITECT, LANDSCAPE ARCHITECT, OR LAND SURVEYOR SHALL STAMP THE DOCUMENT AND INCLUDE THE NOTATION "ALTERED BY" FOLLOWED BY THEIR SIGNATURE, THE DATE OF SUCH ALTERATION, AND A SPECIFIC DESCRIPTION OF THE ALTERATION.

STAGE 3 TYPICAL

Greenman-Pedersen, Inc. 80 Wolf Road, Suite 600 Albany, NY 12205 518.453.9431 GPINET.COM

ALL DIMENSIONS IN ft UNLESS OTHERWISE NOTED

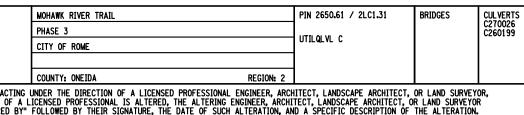
SITE 15 - WORK ZONE TRAFFIC CONTROL

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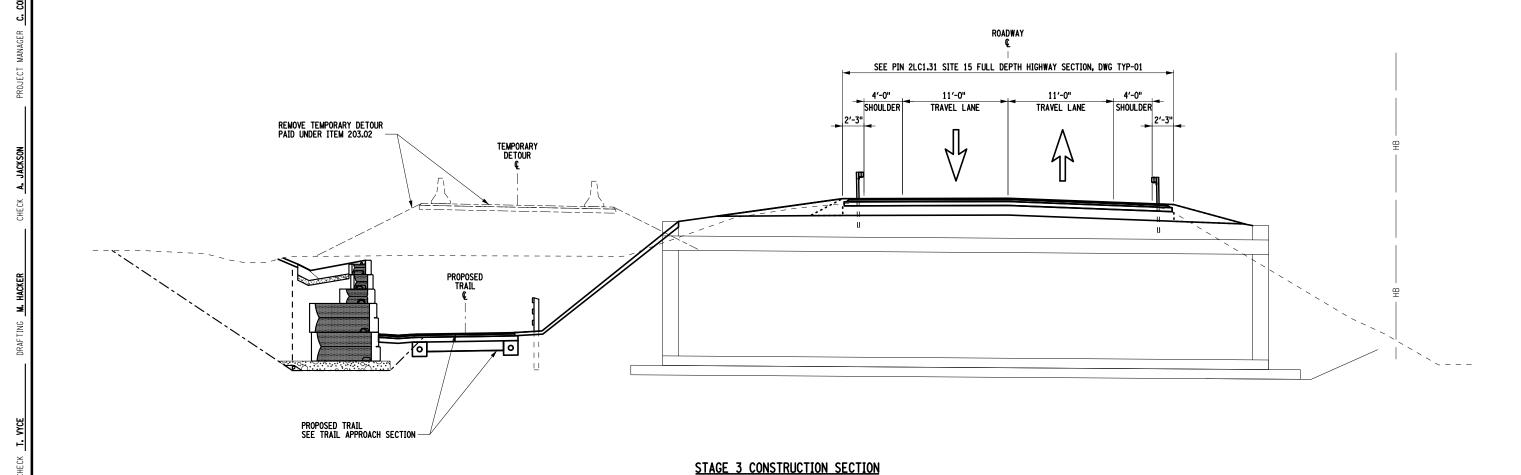
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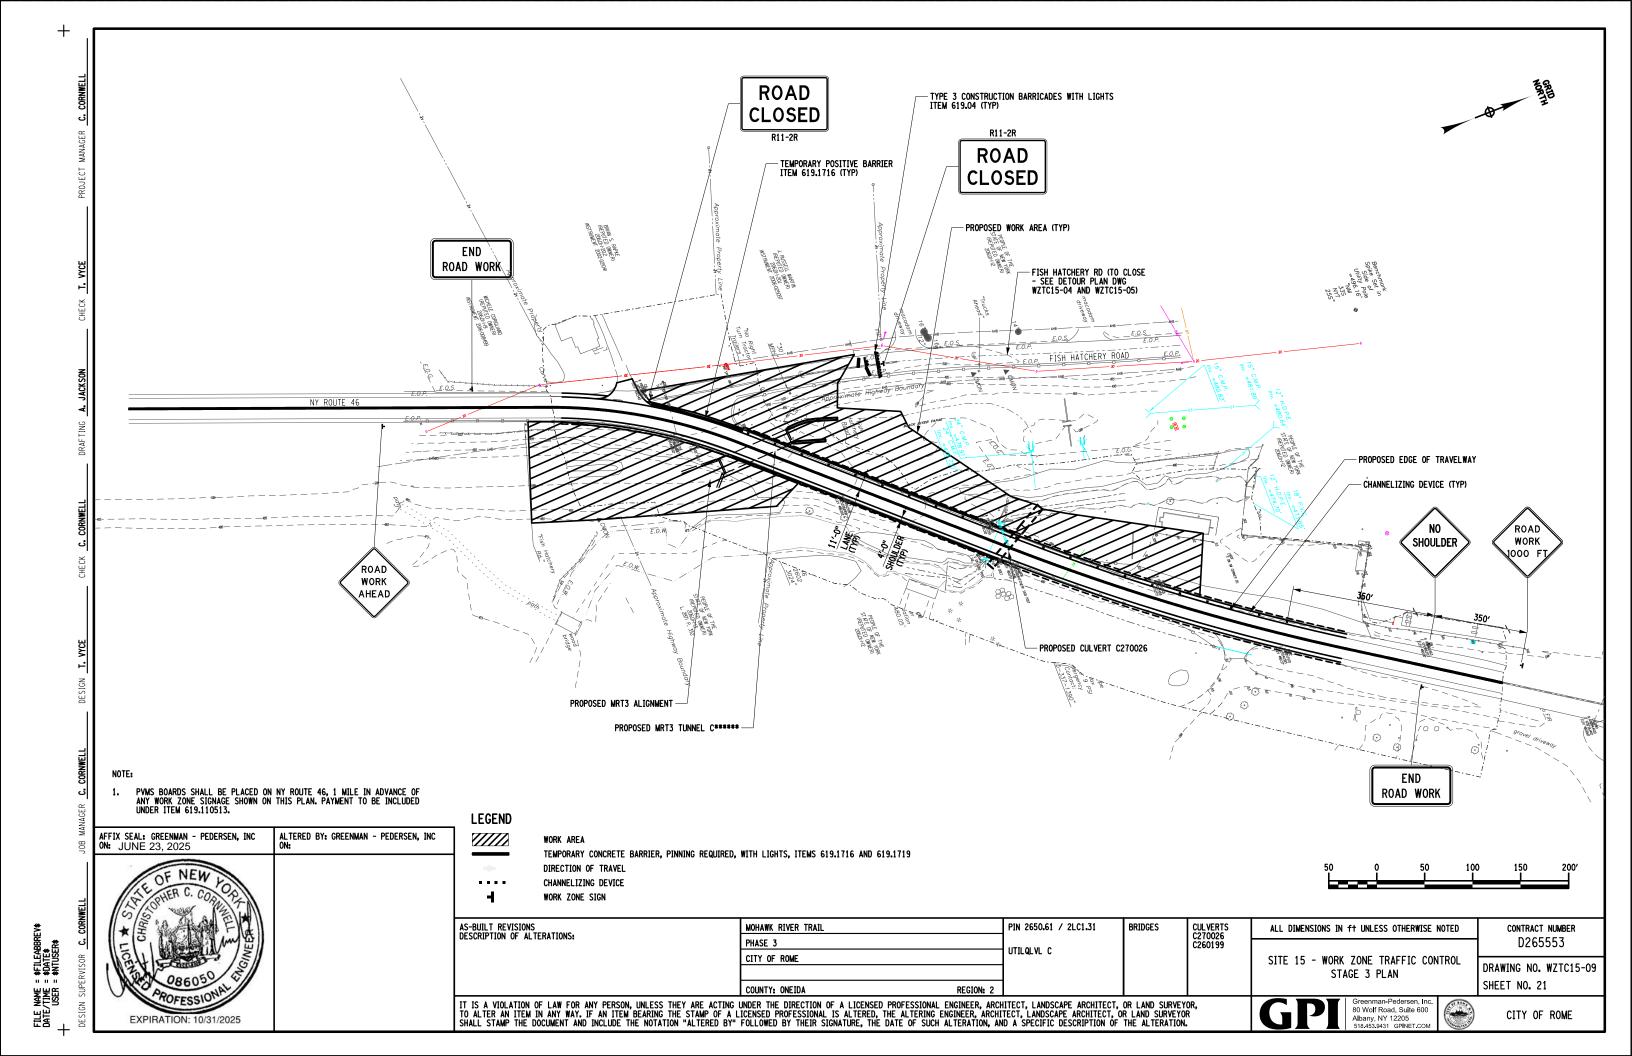
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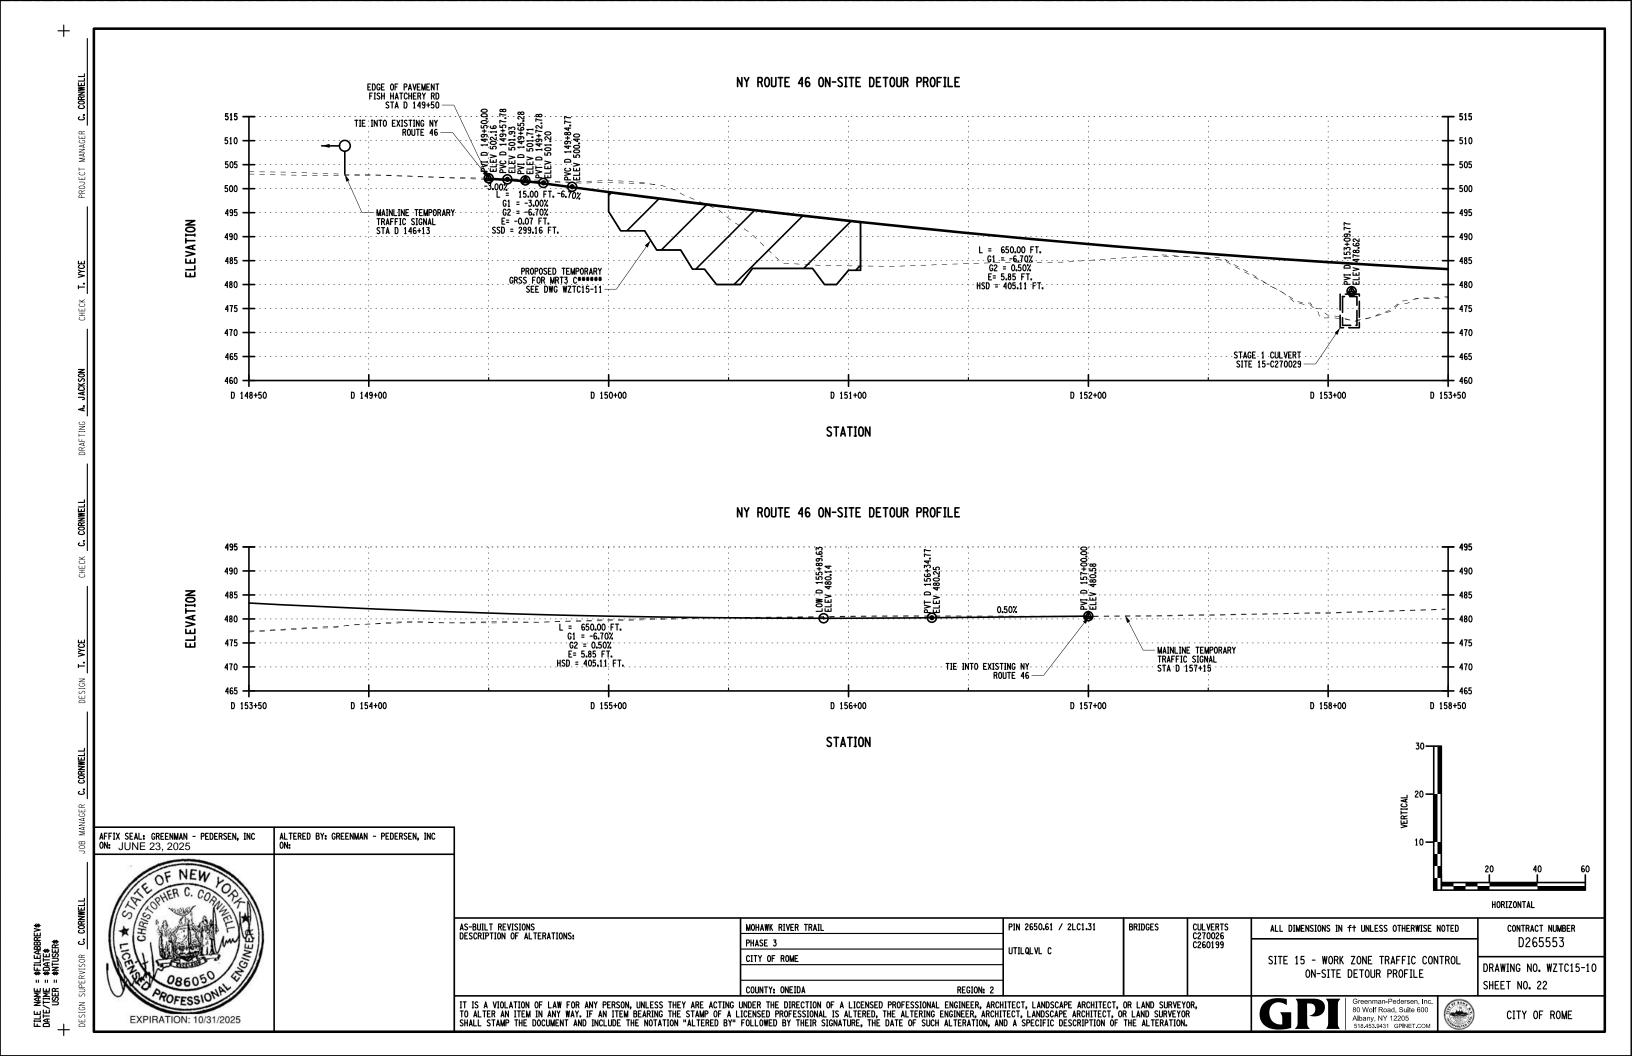
CITY OF ROME

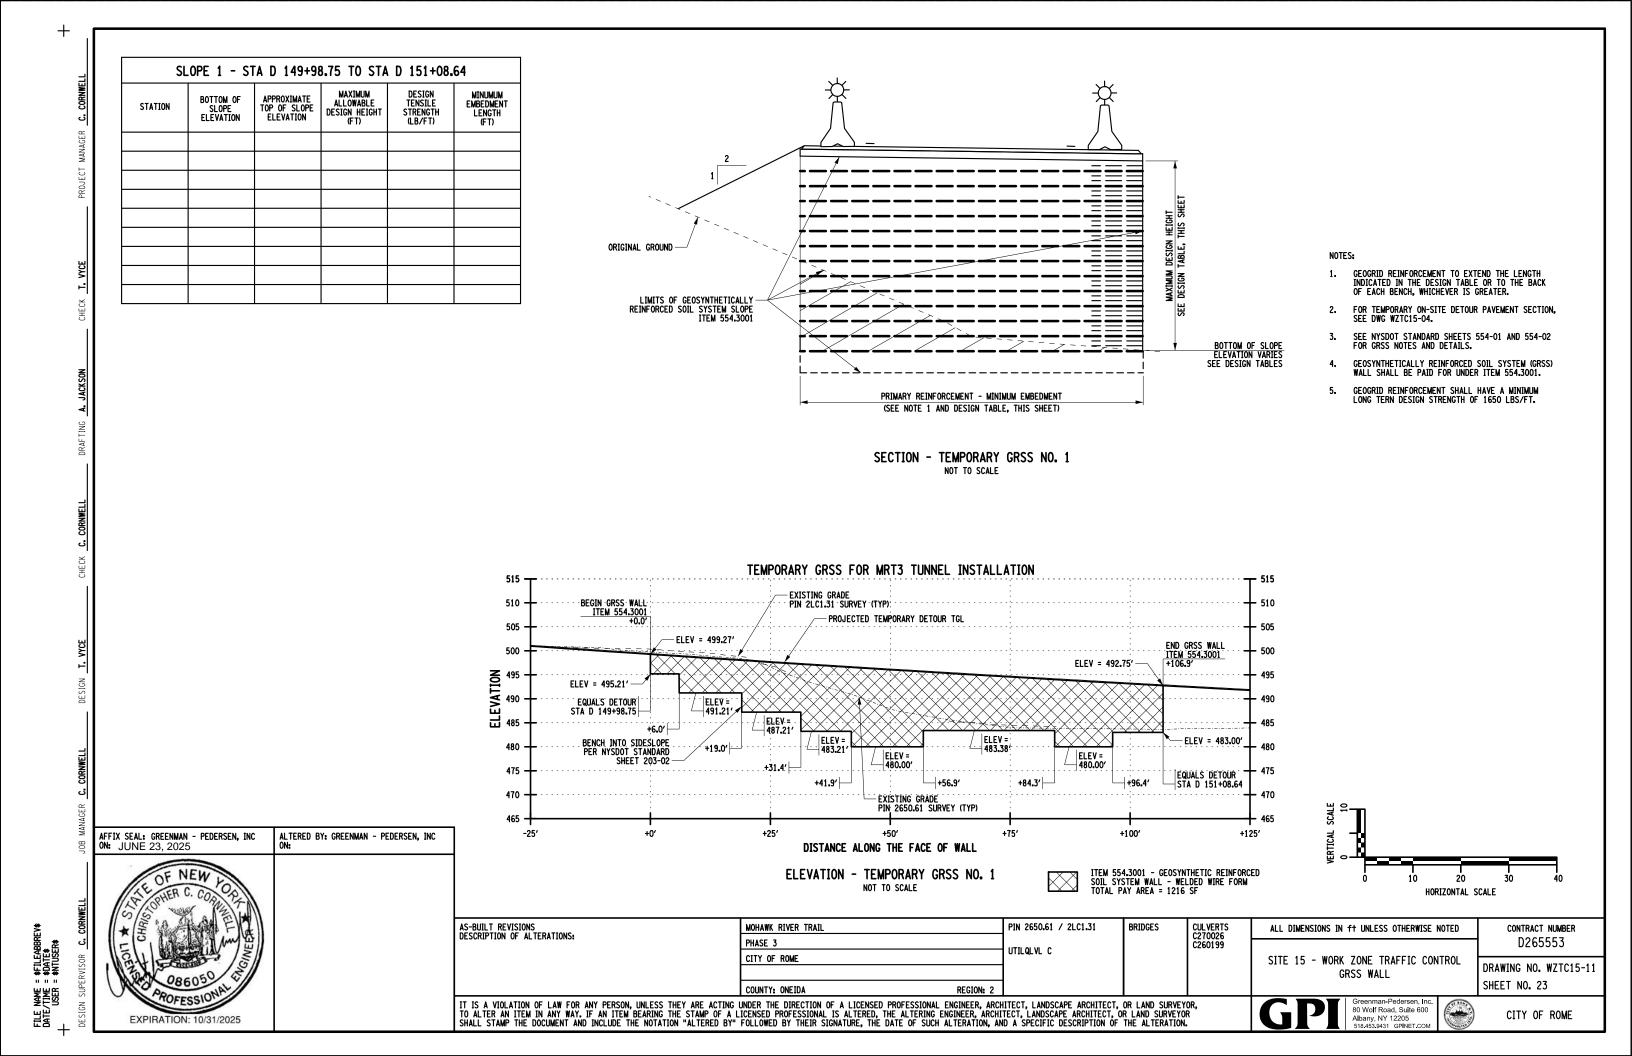


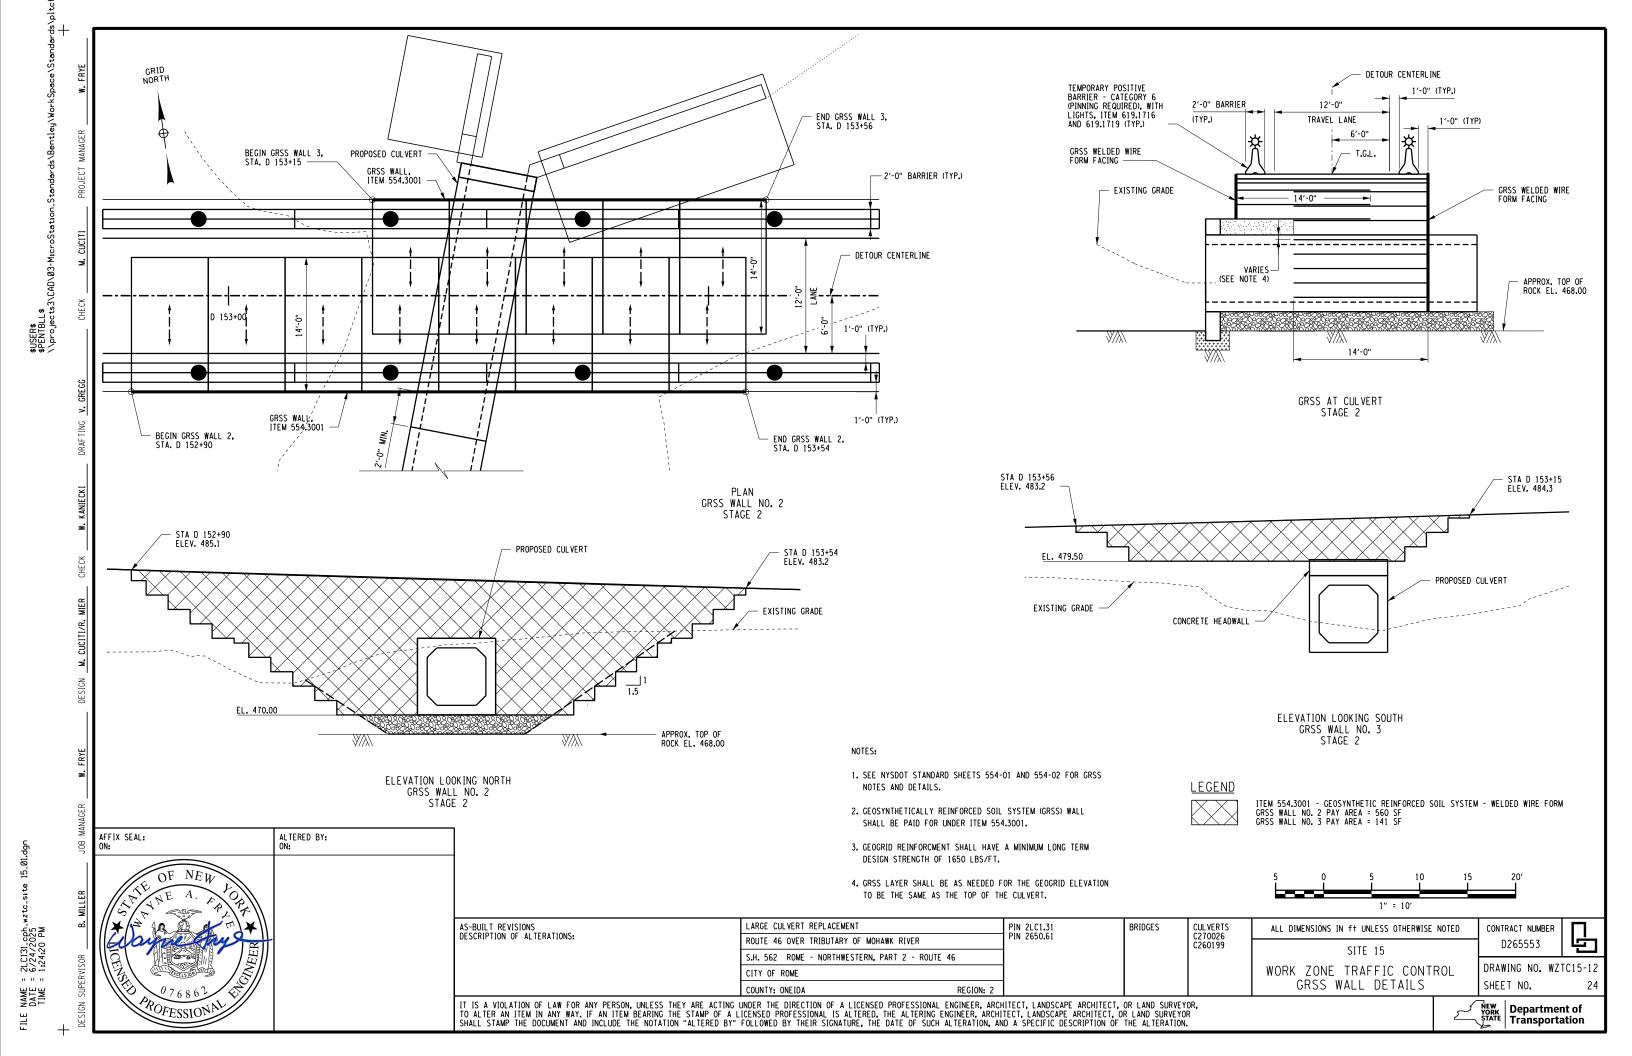
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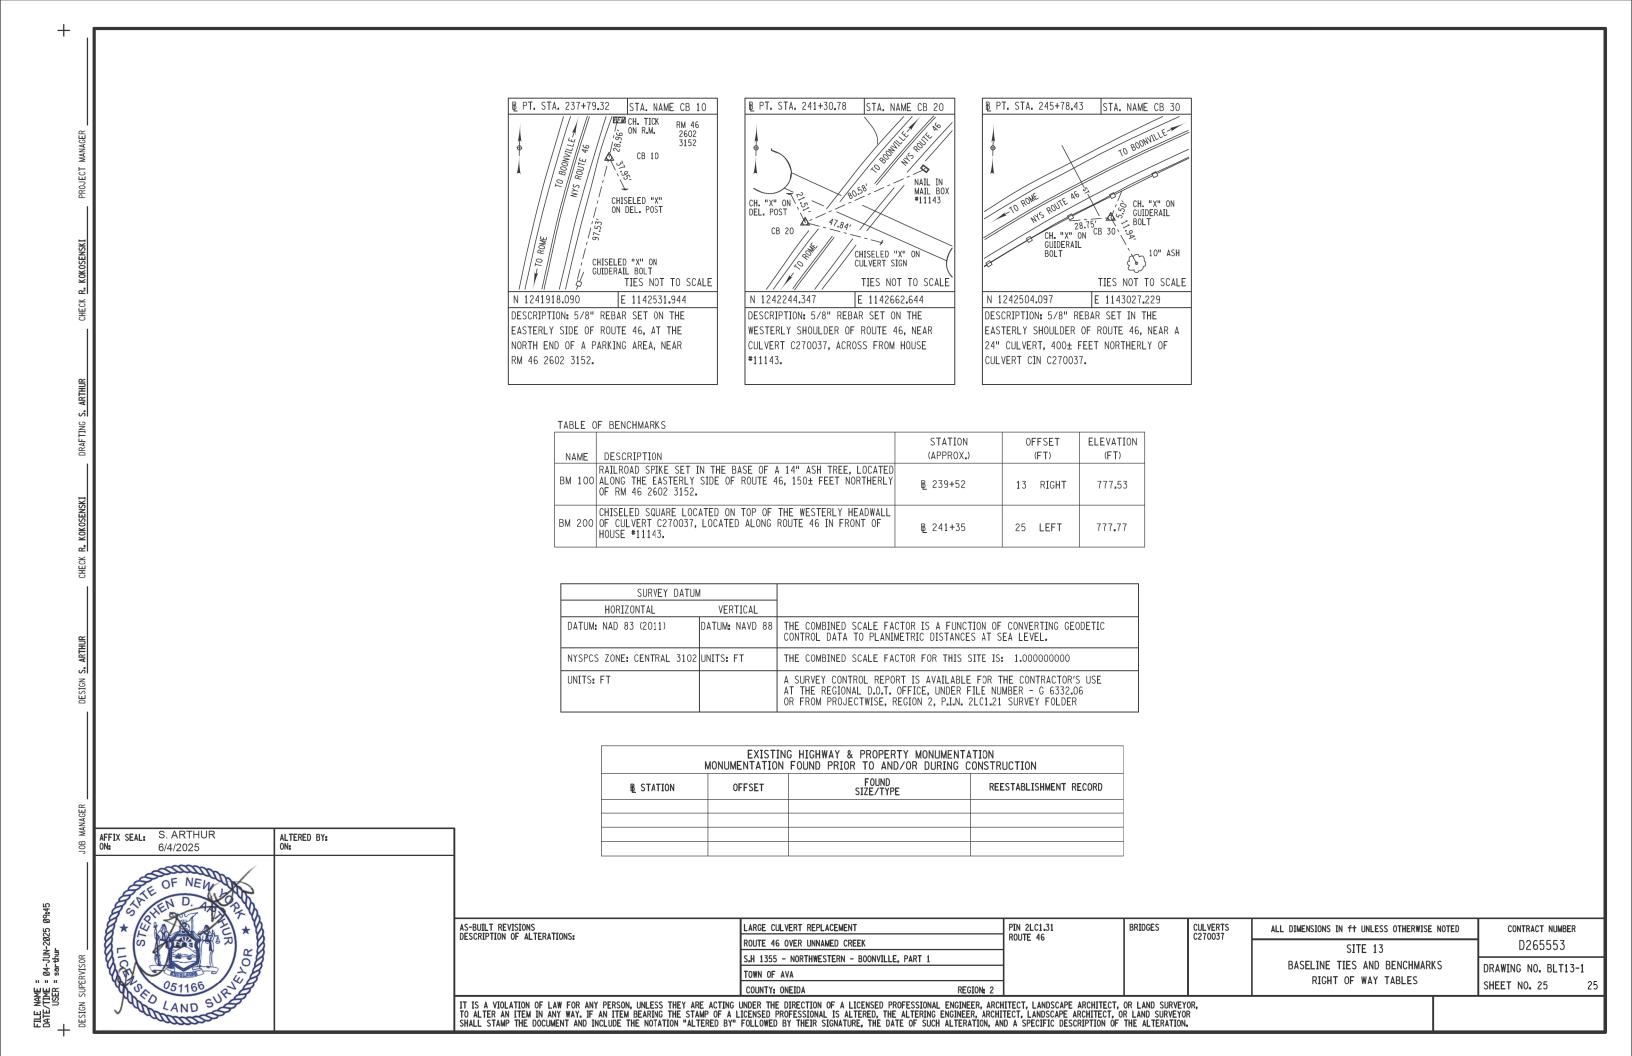















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№ PT. STA. 89+85.26 STA. NAME CB 10 NAIL IN WOOD FENCE POST CB 10 NAIL IN WOOD FENCE POST -32.01/2 HOUSE #1410 / TIES NOT TO SCALE N 1016124.852 E 1051169.646

DESCRIPTION: 5/8" CAPPED REBAR SET ON THE WESTERLY SHOULDER OF ROUTE 26, IN

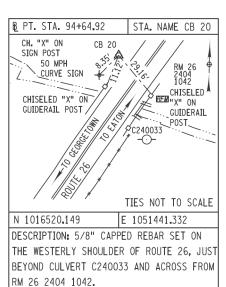FRONT OF HOUSE #1410.



₽ PT. STA. 96+66,43	STA. NAME CB 30
CH.	NYSEG 229 "X" ON N POST BUS STOP AHEAD"
	TIES NOT TO SCALE
N 1016680,828	1051562.938
DESCRIPTION: 5/8" CAPPE	D REBAR SET ON
THE WESTERLY SHOULDER	OF ROUTE 26,
200± FEET NORTHEASTER	LY OF CULVERT
C240033.	

TABLE OF BENCHMARKS

NAME	DESCRIPTION	STATION (APPROX.)	OFFSET (FT)	ELEVATION (FT)
	RAILROAD SPIKE SET IN THE BASE OF U.P. NYSEG 232, LOCATED ALONG THE WESTERLY SIDE OF ROUTE 26, 50± FEET NORTH OF RM 26 2404 1041.	® 89+73 F.T.P.B.	3 LEFT	1484.41
BM 2	RAILROAD SPIKE SET IN THE BASE OF U.P. NYSEG 231, LOCATED ALONG THE EASTERLY SIDE OF ROUTE 26, 280± FEET NORTH OF RM 26 2404 1041.	B 92+28	35 RIGH	Г 1478.44


SURVEY DATUM	И	
HORIZONTAL	VERTICAL	
DATUM: NAD 83 (2011)	DATUM: NAVD 88	THE COMBINED SCALE FACTOR IS A FUNCTION OF CONVERTING GEODETIC CONTROL DATA TO PLANIMETRIC DISTANCES AT SEA LEVEL.
NYSPCS ZONE: CENTRAL 3102	UNITS: FT	THE COMBINED SCALE FACTOR FOR THIS SITE IS: 1.000000000
UNITS: FT		A SURVEY CONTROL REPORT IS AVAILABLE FOR THE CONTRACTOR'S USE AT THE REGIONAL D.O.T. OFFICE, UNDER FILE NUMBER - G 63302.06 OR FROM PROJECTWISE, REGION 2, P.I.N. 2LC1.31 SURVEY FOLDER

	TABLE OF RIGHT OF WAY ACQUISITIONS						
MAP NO(S).	PARCEL NO.(S)	TRN. NO.	REPUTED OWNER(S)	TYPE OF ACQUISITION	DWG. NO.(S)	AREA SQ. FT.	REMARKS
7	11	100	JANICE A. TRASS	PE	GP14-1	3,454±	
7	12	100	JANICE A. TRASS	PE	GP14-1	1,894±	

ROW MARKERS

R.O.W. MARKERS					
NOTES: 1. DISCLAIMER THAT THE TABLE OF MONUMENTS IS FOR ESTIMATION PURPOSES ONLY. ALL MONUMENTS SHALL BE PLACED IN ACCORDANCE WITH RIGHT-OF-WAY APPROPRIATION MAPS. 2. WHEN WORK IS COMPLETED UNDER THIS SECTION, THE CONTRACTOR SHALL PROVIDE A SIGNED COPY OF THIS SHEET TO THE EIC AT THE COMPLETION OF THE PROJECT.					
B STATION	OFFSET	ITEM 625.03	ITEM 625.04	ITEM 625.05	ITEM 625.05010006
₽ 93+88±	LEFT			1	
B 94+15.44	LEFT	1			
B 94+71.39	LEFT	1			
₽ 95+04±	LEFT	1			
₽ 93+88±	RIGHT			1	1
B 94+36.78	RIGHT	1			
B 94+75.05	RIGHT	1			
№ 95+06±	RIGHT	1			

	EXISTING HIGHWAY & PROPERTY MONUMENTATION MONUMENTATION FOUND PRIOR TO AND/OR DURING CONSTRUCTION				
B STATION	OFFSET	FOUND SIZE/TYPE	REESTABLISHMENT RECORD		

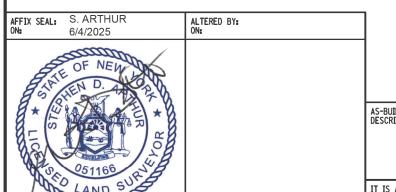



	GE CULVERT REPLACEMENT
RIPTION OF ALTERATIONS:	TE 26 OVER UNNAMED CREEK
S.H.	339 GEORGETOWN - ROUTES 26 & 80
TOWN	N OF GEORGETOWN
COU	NTY: MADISON REGION: 2

PIN 2LC1.31 ROUTE 26	BRIDGES	CULVERTS C240033	ALL DIMENSIONS IN ft UNLESS OTHERWISE NOTED	CONTRACT NUMBER
110012 20			SITE 14	D265553
			BASELINE TIES AND BENCHMARKS	DRAWING NO. BLT14-1
			RIGHT OF WAY TABLES	SHEET NO. 26 26

26

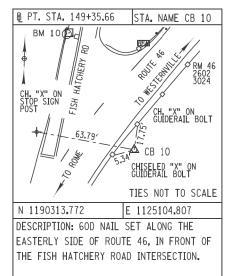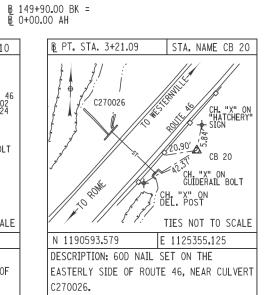FILE NAME = DATE/TIME = 04-JUN-2025 09:47 USER = sarthur





₽ PT. STA. 9+44.41	STA. NAME CB 2180
CH. "X" ON SIGN POST	PIN IN TOP OF CONC MON
// <i>/</i> /// -	TIES NOT TO SCALE
N 1191094.442 E	1125726.144
DESCRIPTION: 5/8" REBAR	SET ALONG THE
EASTERLY SHOULDER OF F	ROUTE 46, NEAR A
PARKING AREA ACROSS FR	OM THE "MOHAWK
RIVER FISH HATCHERY" SI	GN.

			TABLE OF RIGHT OF WAY ACQUISITIONS								
MAF NO(S		TRN. NO.	REPUTED OWNER(S)	TYPE OF ACQUISITION	DWG. NO.(S)	AREA SQ. FT.	REMARKS				
381	45		LANDS OF THE PEOPLE OF THE STATE OF NEW YORK UNDER THE PRESENT JURISDICTION OF THE DEPARTMENT OF ENVIRONMENTAL CONSERVATION AND THE EXECUTIVE DEPARTMENT, OFFICE OF PARKS, RECREATION AND HISTORIC PRESERVATION (ABANDONED BLACK RIVER CANAL)	C.U.O.	GP15-1	7,991±					
391	46		LANDS OF THE PEOPLE OF THE STATE OF NEW YORK UNDER THE PRESENT JURISDICTION OF THE DEPARTMENT OF ENVIRONMENTAL CONSERVATION	C.U.O.	GP15-1	7,337±					
	-										

R.O.W. MARKERS

NOTES: 1. DISCLAIMER THAT THE TABLE OF MONUMENTS IS FOR ESTIMATION PURPOSES ONLY. ALL MONUMENTS SHALL BE PLACED IN ACCORDANCE WITH RIGHT-OF-WAY APPROPRIATION MAPS. 2. WHEN WORK IS COMPLETED UNDER THIS SECTION, THE CONTRACTOR SHALL PROVIDE A SIGNED COPY OF THIS SHEET TO THE EIC AT THE COMPLETION OF THE PROJECT.										
₽ STATION	OFFSET	ITEM 625.03	ITEM 625.04	ITEM 625.05						
B 1+29±	LEFT	1								
B 3+36.18	LEFT	1								
B 3+92.58	LEFT	1								
₽ 5+44±	LEFT			1						

EXISTING HIGHWAY & PROPERTY MONUMENTATION MONUMENTATION FOUND PRIOR TO AND/OR DURING CONSTRUCTION									
B STATION	OFFSET	FOUND SIZE/TYPE	REESTABLISHMENT RECORD						
B_ 2+60.65	58.10' LEFT	CONCRETE MONUMENT							
<u>₿</u> 10+29.94 B.T.P.A.	4.65' RIGHT	CONCRETE MONUMENT							

TABLE OF BENCHMARKS

NAME	DESCRIPTION	STATION (APPROX.)	OFFSET (FT)	ELEVATION (FT)
BM 10	RAILROAD SPIKE SET IN THE BASE OF U.P. NM *37, LOCATED ALONG THE WESTERLY SIDE OF FISH HATCHERY ROAD, NEAR RM 46 2602 3024.	B ₂ 149+54	92 LEFT	501.40
BM 20	CHISELED "X" ON THE SOUTHWESTERLY CORNER OF A CATCH BASIN, LOCATED IN THE PARKING LOT OF THE MOHAWK RIVER FISH HATCHERY, ALONG THE WESTERLY SIDE OF ROUTE 46 NEAR RM 46 2602 3025.	® 5+32	71 LEFT	478.13

SURVEY DATUM	И	
HORIZONTAL	VERTICAL	
DATUM: NAD 83 (2011)	DATUM: NAVD 88	THE COMBINED SCALE FACTOR IS A FUNCTION OF CONVERTING GEODETIC CONTROL DATA TO PLANIMETRIC DISTANCES AT SEA LEVEL.
NYSPCS ZONE: CENTRAL 3102	UNITS: FT	THE COMBINED SCALE FACTOR FOR THIS SITE IS: 1.000000000
UNITS: FT		A SURVEY CONTROL REPORT IS AVAILABLE FOR THE CONTRACTOR'S USE AT THE REGIONAL D.O.T. OFFICE, UNDER FILE NUMBER - G 63302.06 OR FROM PROJECTWISE, REGION 2, P.I.N. 2LC1.31 SURVEY FOLDER

AFFIX SEAL: ON:	S. ARTHUR 6/4/2025	ALTERED BY: ON:
A STEEL STEEL	OF NEW TO A TO	

DISTRIBUTION DE LA CASTA DEL CASTA DE LA CASTA DE LA CASTA DE LA CASTA DEL CASTA DE LA CASTA DEL CASTA DEL CASTA DE LA CASTA D	
BUILT REVISIONS LARGE CULVERT REPLACEMENT PIN 2LC1.31 BRIDGES CULVERTS ALL DIMENSIONS IN ft UNLESS OTHE	WISE NOTED
ROUTE 46 OVER UNNAMED CREEK S.H. 562 ROME - NORTHWESTERN, PART2 - ROUTE 46 BASELINE TIES AND BENCI	MARKS
CITY OF ROME COUNTY: ONEIDA REGION: 2 RIGHT OF WAY TABLE	S

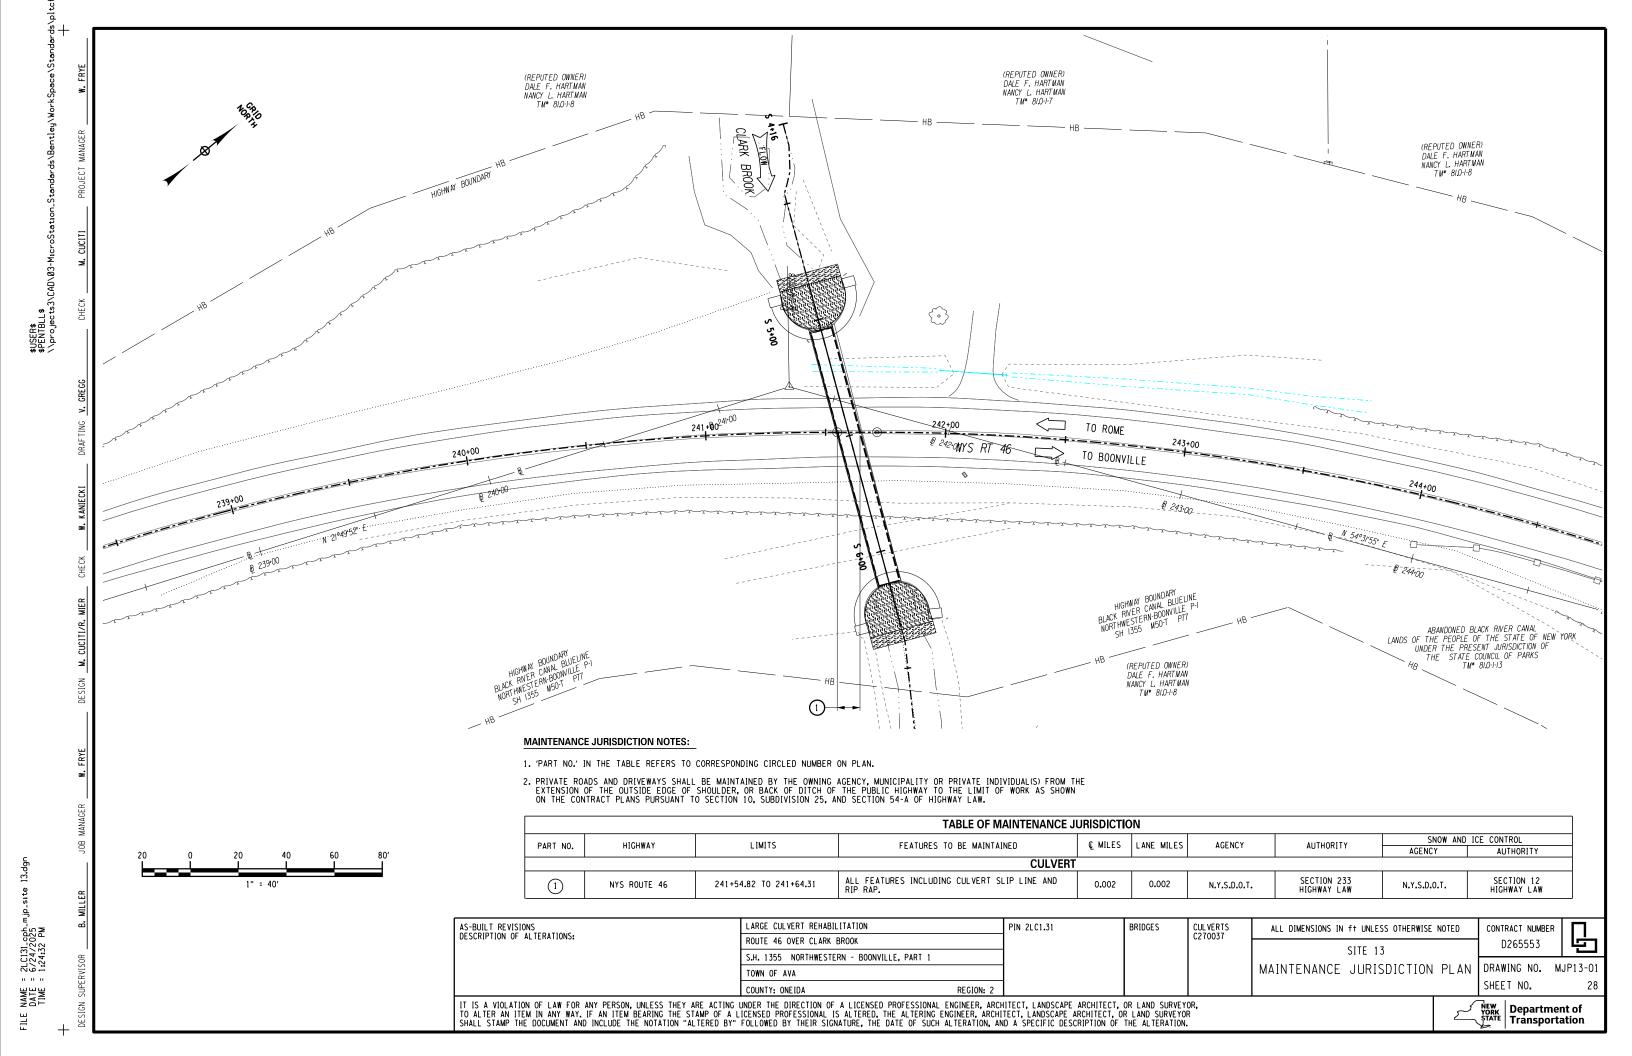
IT IS A VIOLATION OF LAW FOR ANY PERSON, UNLESS THEY ARE ACTING UNDER THE DIRECTION OF A LICENSED PROFESSIONAL ENGINEER, ARCHITECT, LANDSCAPE ARCHITECT, OR LAND SURVEYOR, TO ALTER AN ITEM IN ANY WAY. IF AN ITEM BEARING THE STAMP OF A LICENSED PROFESSIONAL IS ALTERED, THE ALTERING ENGINEER, ARCHITECT, LANDSCAPE ARCHITECT, OR LAND SURVEYOR SHALL STAMP THE DOCUMENT AND INCLUDE THE NOTATION "ALTERED BY" FOLLOWED BY THEIR SIGNATURE, THE DATE OF SUCH ALTERATION, AND A SPECIFIC DESCRIPTION OF THE ALTERATION.

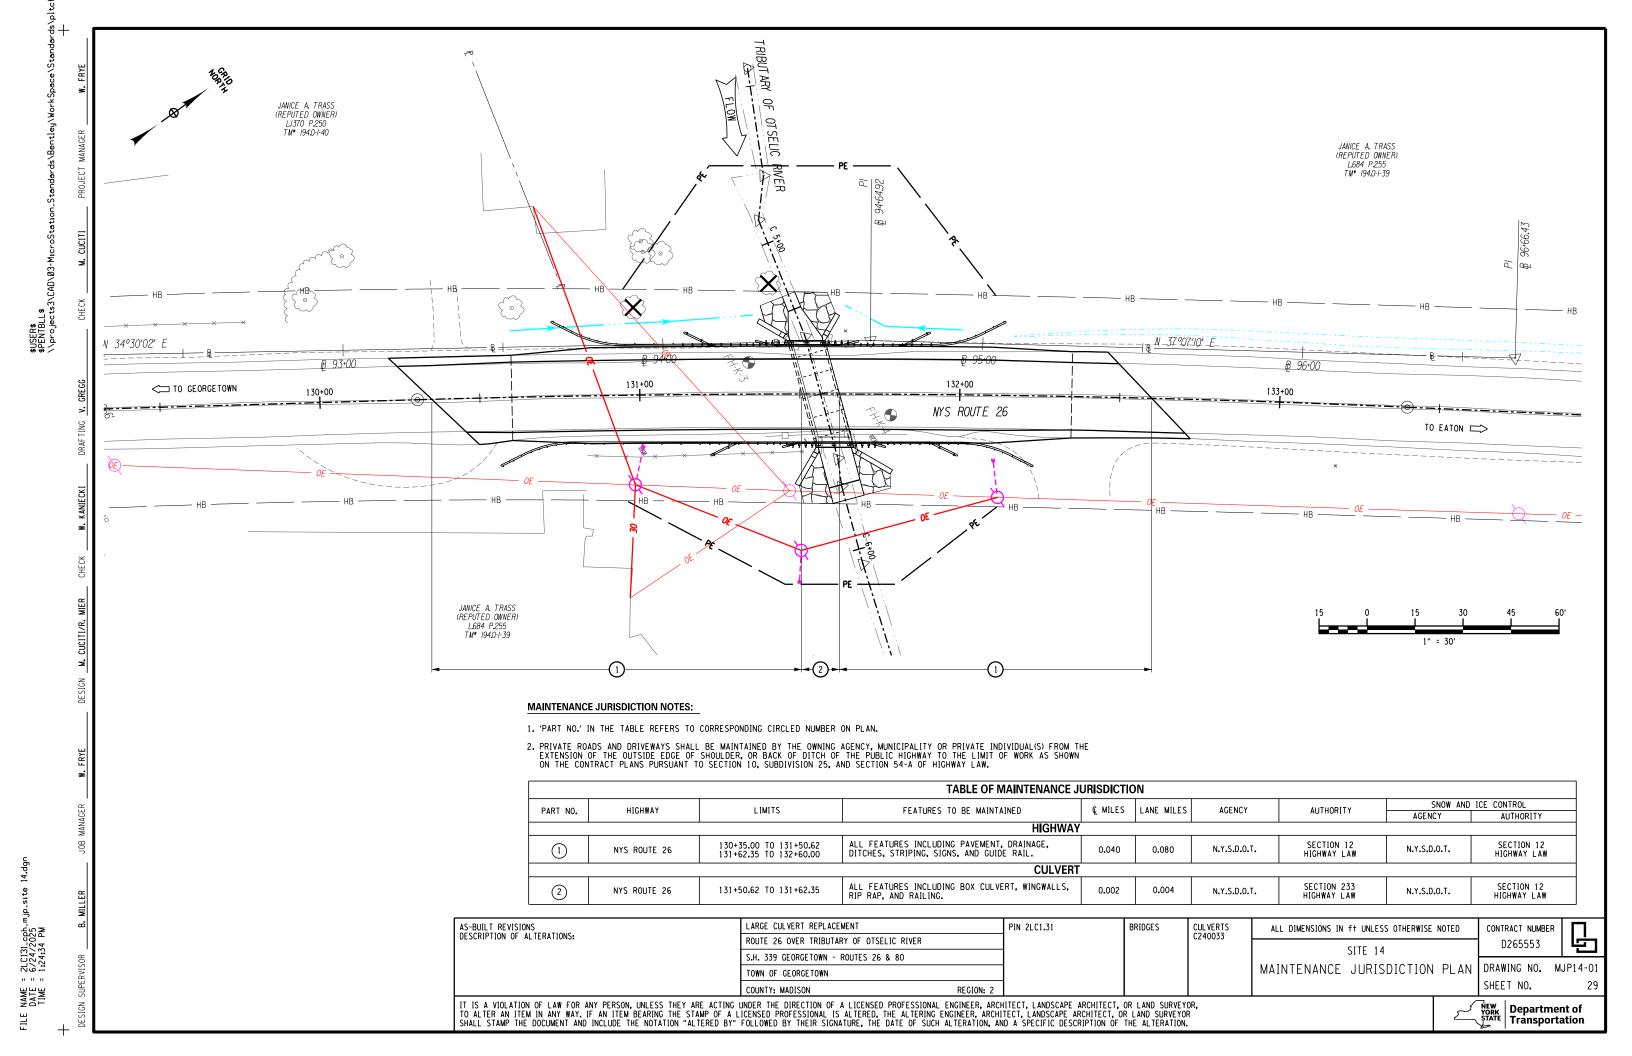
NEW YORK Department of Transportation

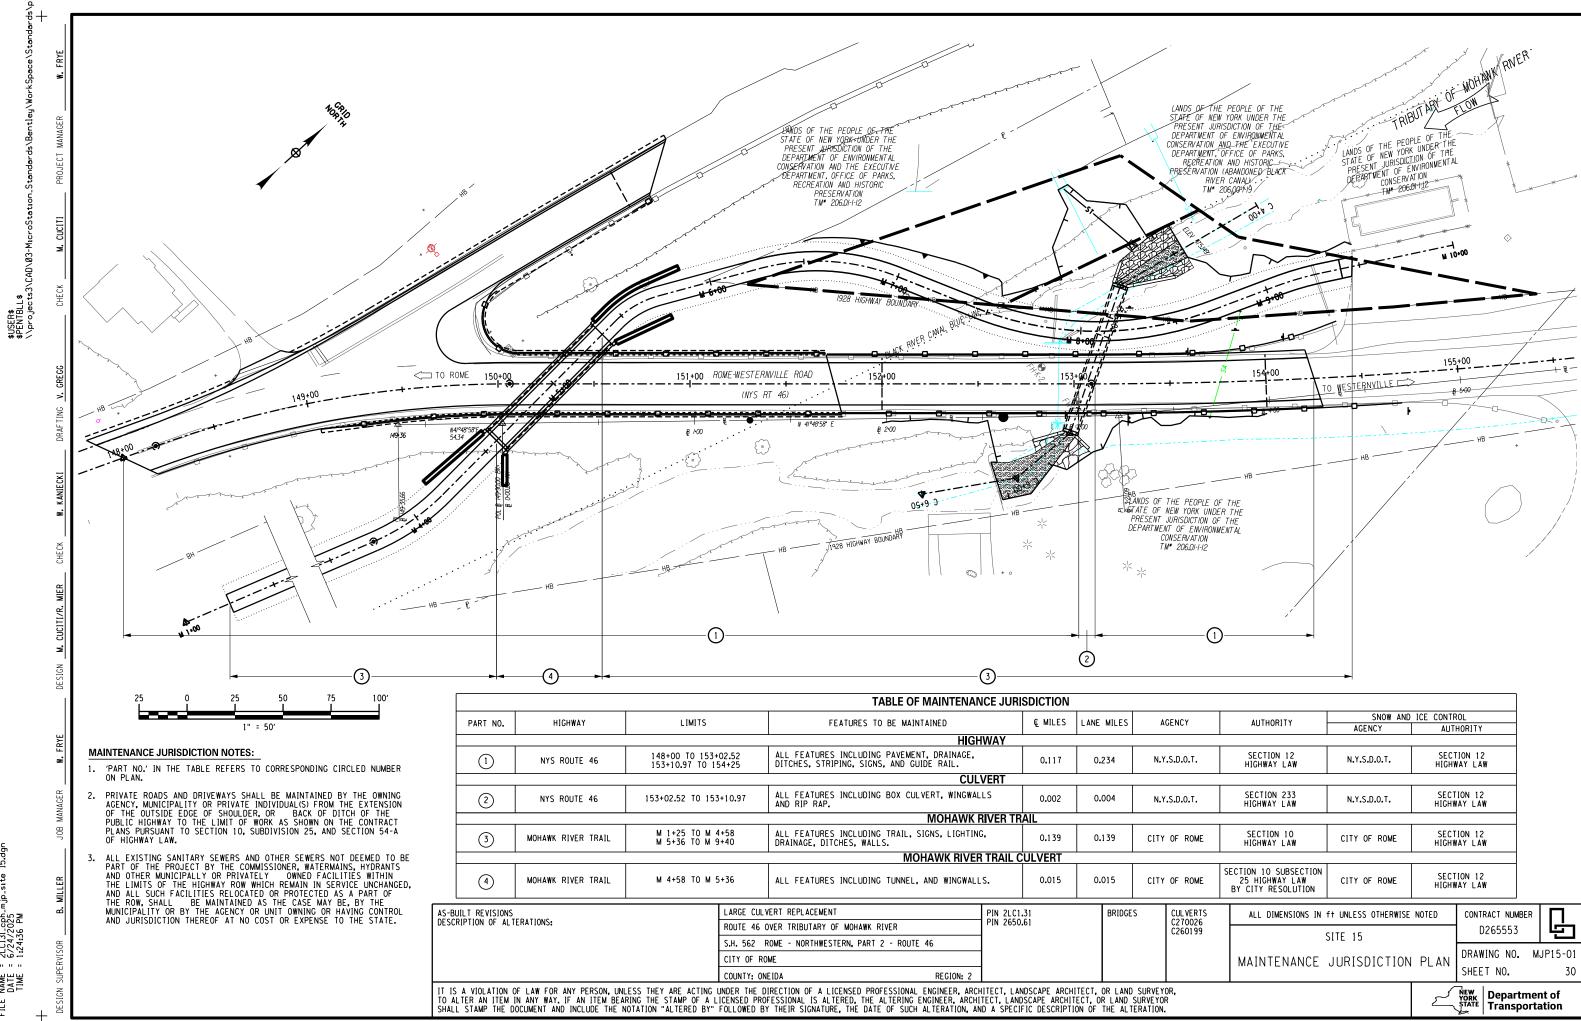
SHEET NO. 27

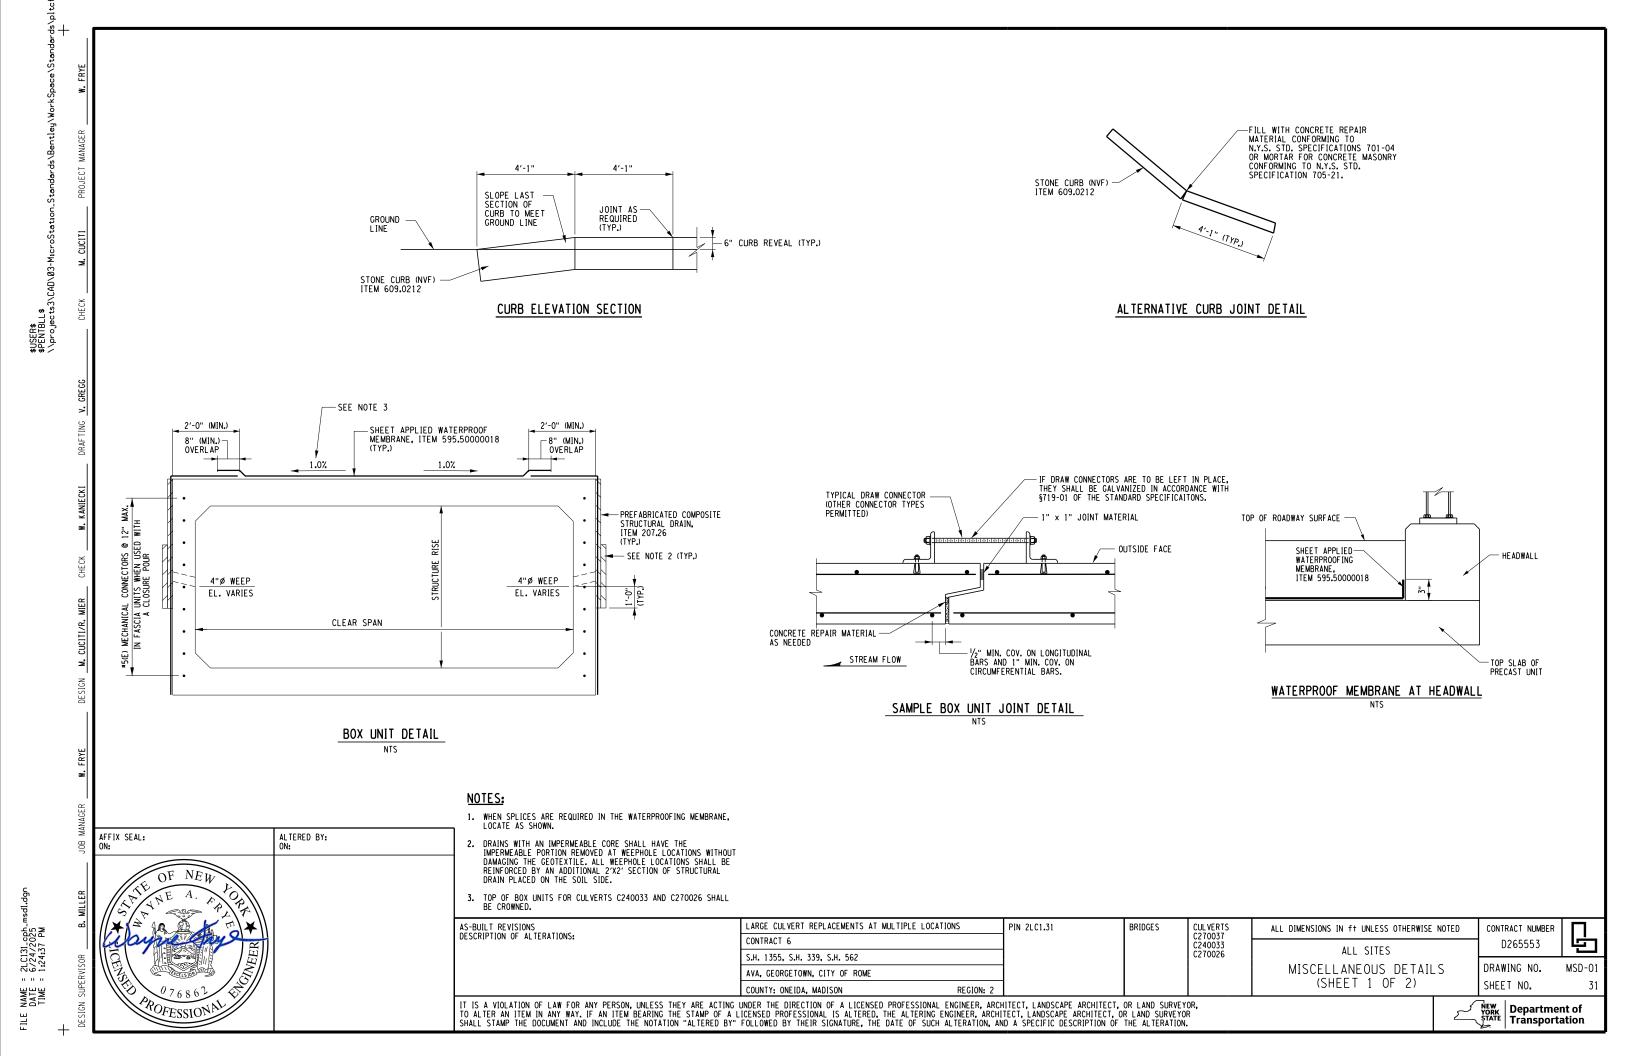
CONTRACT NUMBER D265553

DRAWING NO. BLT15-1











CUT-OFF WALL NOTES:

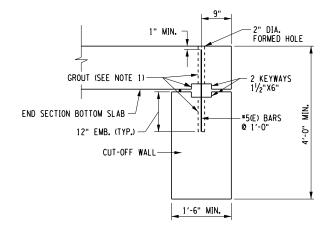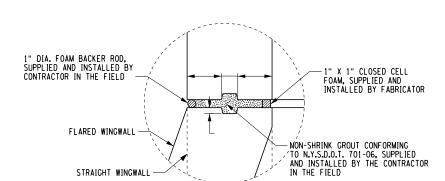1. DOWEL BARS USED TO ATTACH THE CUT-OFF WALL TO THE BOX CULVERT SHALL BE DRILLED AND GROUTED PER THE REQUIREMENTS OF STANDARD SPECIFICATION SECTION 586 EXCEPT THE GROUT SHALL MEET THE REQUIREMENTS OF §701-06. THE KEYMAY SHALL BE GROUTED WITH THE SAME MATERIAL AS THE DOWELS, PLACE A BEAD OF CAULK, CLOSED CELL FOAM OR OTHER SUITABLE MATERIAL ON BOTH SIDES OF THE KEYWAY TO CONTAIN THE GROUT.






CUT-OFF WALL DETAIL


NTS


JOINT DETAIL THIS DETAIL SHOWN IS AN EXAMPLE. OTHER DETAILS MAY BE PROPOSED FOR EVALUATION BY THE STATE.

PRECAST WINGWALL NOTES:

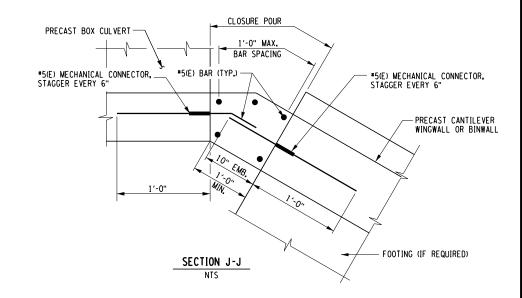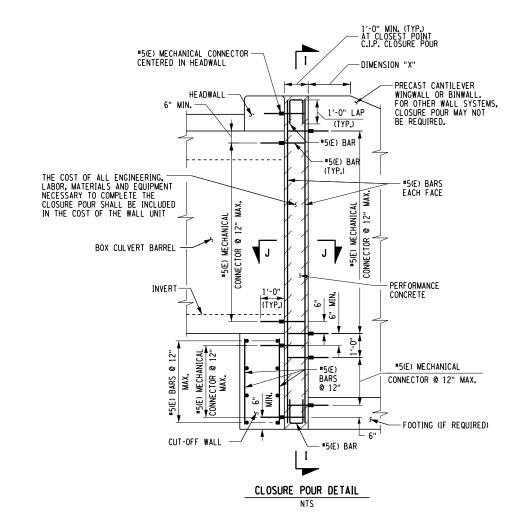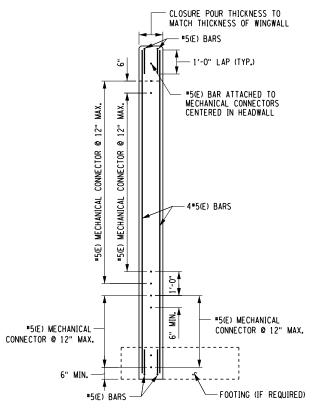
- 1. TALL WALLS WITH FOOTINGS MAY USE A DOWEL BAR LAPPED TO A VERTICAL BAR.
- 2. BAR SIZE AND SPACING TO BE DETERMINED BY CONTRACTOR.
- ACTUAL WALL THICKNESS AND FOOTING DIMENSIONS TO BE DETERMINED BY CONTRACTOR.
- BASED ON HANDLING AND SHIPPING CONSTRAINTS, THE CONTRACTOR MAY ELECT TO USE MULTIPLE WINGWALL UNITS TO SATISFY WALL LENGTH REQUIRED ON THE PLANS, THE JOINT DETAIL BETWEEN WINGWALL UNITS SHALL BE IN ACCORDANCE
- 5. TEMPERATURE/SHRINKAGE REINFORCEMENT PROVIDED SHALL BE CHECKED BY THE CONTRACTOR TO BE IN COMPLIANCE WITH THE CURRENT DESIGN SPECIFICATIONS.
- WHERE EPOXY COATED THREADED INSERTS ARE SHOWN, ANY NON-CORROSIVE MECHANICAL CONNECTOR MEETING \$709-10 MAY BE USED AS ALTERNATIVE.
- ALL REINFORCEMENT COVER ON CAST IN PLACE CONCRETE SHALL BE 2" UNLESS
- 8. ALL REINFORCEMENT COVER ON PRECAST UNITS SHALL BE 1" UNLESS NOTED OTHERWISE.







SECTION 1-I CLOSURE POUR REINFORCEMENT SECTION

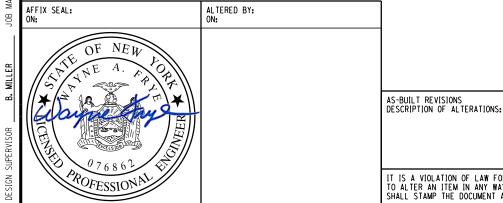

LARGE CULVERT REPLACEMENTS AT MULTIPLE LOCATIONS CONTRACT 6 S.H. 1355, S.H. 339, S.H. 562 AVA, GEORGETOWN, CITY OF ROME COUNTY: ONEIDA, MADISON

PIN 2LC1.31 BRIDGES

CUL VERTS 0240033 C270026

ALL DIMENSIONS IN ft UNLESS OTHERWISE NOTED ALL SITES

CONTRACT NUMBER D265553 MISCELLANEOUS DETAILS (SHEET 2 OF 2)

DRAWING NO. SHEET NO.

IT IS A VIOLATION OF LAW FOR ANY PERSON, UNLESS THEY ARE ACTING UNDER THE DIRECTION OF A LICENSED PROFESSIONAL ENGINEER, ARCHITECT, LANDSCAPE ARCHITECT, OR LAND SURVEYOR, TO ALTER AN ITEM IN ANY WAY. IF AN ITEM BEARING THE STAMP OF A LICENSED PROFESSIONAL IS ALTERED, THE ALTERING ENGINEER, ARCHITECT, LANDSCAPE ARCHITECT, OR LAND SURVEYOR SHALL STAMP THE DOCUMENT AND INCLUDE THE NOTATION "ALTERED BY" FOLLOWED BY THEIR SIGNATURE, THE DATE OF SUCH ALTERATION, AND A SPECIFIC DESCRIPTION OF THE ALTERATION.

New YORK Department or Transportation

MSD-02

AFFIX SEAL: ON:

ו	
= 6/24/2025 = 1:24:39 PM	
DATE = TIME =	

GUIDE RAIL NEW INSTALLATION TABLE								ES
FROM STATION	TO STATION	SIDE	LENGTH	FACTOR	COMMENTS	606.10	606.120102	606.120201
			SITE 14					
131+90.9	131+93.9	LT	3.0	1.0	North			1
130+95.6	131+13.6	LT	18.0	1.0	West	18		1
130+79.7	131+21.7	RT	42.0	1.0	South	42		1
131+99.7	132+02.7	RT	3.0	1.0	East			1
			SITE 15					
151+74.0	153+60.0	LT	198.0	1.0	North	180	1	
151+74.0	154+69.9	RT	306.0	1.0	South, replace end piece	288		
153+03.0	153+21.0	LT	18.0	1.3	North rail over culvert	23		
152+92.5	153+10.5	RT	18.0	1.3	South rail over culvert	23		
	SITE 15	- MRT (PIN	2650.61) - 9	SEE DWG.	MTMRT-01			
						575	1	4

GUIDE RAIL REMOVAL TABLE									
FROM STATION	TO STATION	SIDE	LENGTH	FACTOR	FACTOR COMMENTS				
	PAID FOR UNDER ITEM 206.01								
			SITE	15					
151+74.0	153+60.0	LT	277.0	1.0	North	277			
151+74.0	154+69.9	9.9 RT 385.0 1.0 South		306					
·									

ITEM 685.1102 WHITE EPOXY REFLECTORIZED PAVEMENT STRIPES - 20 MIL										
FROM STATION	TO STATION	SIDE	QTY	TYPE	LENGTH (FT)	WIDTH (IN)	PAYMENT FACTOR	PAYABLE LENGTH		
SITE 14										
130+00	132+75	LT	1	WEL	275.00	6.0	1.5	412.5		
130+00	132+75	RT	1	WEL	275.00	6.0	1.5	412.5		
				SITE 15	<u> </u>					
151+75	154+50	LT	1	WEL	275.00	6.0	1.5	412.5		
151+75	154+50	RT	1	WEL	275.00	6.0	1.5	412.5		
		SITE 15 -	MRT (PIN	2650.61) -	SEE DWG	. MTMRT-	01			
TOTALS:										

ITEM 685.1202 YELLOW EPOXY REFLECTORIZED PAVEMENT STRIPES - 20 MIL										
FROM STATION	TO STATION	SIDE	QTY	TYPE	LENGTH (FT)	WIDTH (IN)	PAYMENT FACTOR	PAYABLE LENGTH		
SITE 14										
130+00	132+75	CL	2	YFBL	550.00	4.0	1	550.0		
				SITE 15	j					
151+75	154+50	CL	2	YFBL	550.00	4.0	1	550.0		
•		SITE 15 -	MRT (PIN	2650.61) -	SEE DWG	. MTMRT-	01			
	1100									



ALTERED BY: ON:

AS-BUILT REVISIONS DESCRIPTION OF ALTERATIONS:

LARGE CULVERT REPLACEMENTS AT MULTIPLE LOCATIONS CONTRACT 6 S.H. 1355, S.H. 339, S.H. 562 AVA, GEORGETOWN, CITY OF ROME COUNTY: ONEIDA, MADISON REGION: 2 BRIDGES

PIN 2LC1.31

CUL VERTS C270037 C240033 C270026

ALL DIMENSIONS IN ft UNLESS OTHERWISE NOTED ALL SITES MISCELLANEOUS TABLES

CONTRACT NUMBER D265553


DRAWING NO. SHEET NO.

MT-01



SUMMARY OF EARTHWORK (ITEMS 203.02 AND 203.03 ONLY)						
SOURCE	1	EXCAVATION			ITEM 203.03	
	T _E	c _R	T _U	C _T	F _T	
SITE 13	-	-	-	-	_	
SITE 14	480	-	-	480	970	
SITE 15	1810	-	-	1810	2890	
SITE 15 (MRT)	1479			1479	2472	
TOTALS (CY)	3769	-	-	3769	6332	

SUMMARY OF STRUCTURAL EXCAVATION (ITEM 206.01 ONLY)					
SOURCE	EXCA	ITEM			
SOUNCE	ROCK	NON-ROCK	206.01		
SITE 13	-	-	-		
SITE 14	-	-	-		
SITE 15	-	1560	1560		
SITE 15 (MRT)	-	4198	4198		
TOTALS (CY)	-	5758	5758		

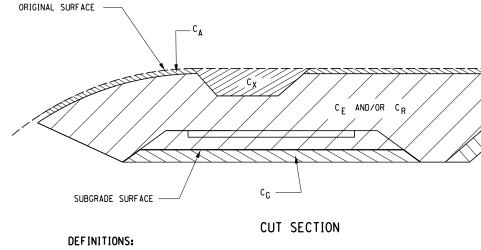

 ${\tt C}_{\tt B}$ - EXCAVATION FOR REQUIRED BENCHING, (BOTH LONGITUDINAL AND TRANSVERSE).

CG - EXCAVATION FOR SUBGRADE IMPROVEMENT.

 C_P - EXCAVATION FROM CUT SLOPE NECESSARY TO PLACE SLOPE PROTECTION.

 $c_{\rm E}$ - Portion of cut assumed to be earth suitable for embankment construction, excluding $c_{\rm G}$ and $c_{\rm P}$.

 T_{E} - $(C_{B}$ + C_{G} + C_{P} + C_{E}) TOTAL EARTH EXCAVATION ASSUMED SUITABLE FOR EMBANKMENT CONSTRUCTION.

 C_Δ - EXCAVATION OF TOPSOIL (UNSUITABLE MATERIAL) IN CUT.

 c_{S} - excavation of topsoil (unsuitable material) under embankment.

 C_X - <code>EXCAVATION</code> OF <code>UNSUITABLE</code> <code>MATERIAL</code> IN <code>CUT: SWAMP</code> OR <code>DUMP</code>

 ${\tt C_0}$ - excavation of unsuitable material beneath embankment: swamp or dump

 T_U - $(C_A$ + C_S + C_X + C_0) TOTAL EXCAVATION ASSUMED UNSUITABLE FOR EMBANKMENT CONSTRUCTION.

 $\boldsymbol{c}_{\,R}$ - PORTION OF CUT ASSUMED TO BE ROCK, INCLUDING $\boldsymbol{c}_{\,G}$ IF APPLICABLE.

 $C_T - (T_E + T_U + C_R)$ TOTAL EXCAVATION.

SUMMARY OF TRENCH AND CULVERT EXCAVATION (ITEM 206.0201 ONLY)					
SOURCE	EXCA	ITEM			
SOURCE	ROCK	NON-ROCK	206.0201		
SITE 13	-	58	58		
SITE 14	-	30	30		
SITE 15	72	28	100		
SITE 15 (MRT)	-	26	26		
TOTALS (CY)	72	142	214		



 C_S OR F_S

DEFINITIONS:

SUBGRADE SURFACE

 ${\sf F}_{\sf B}$ - FILL REQUIRED TO REPLACE BENCHES.

 F_S - FILL REQUIRED TO REPLACE TOPSOIL REMOVED BENEATH EMBANKMENTS.

 ${\sf F}$ - FILL REQUIRED TO COMPLETE EMBANKMENT TO SUBGRADE SURFACE AND SIDE-SLOPES AFTER FOUNDATION IS PREPARED.

ORIGINAL SURFACE -

 F_T - $(F_B + F_S + F)$ TOTAL FILL REQUIRED.

 $^{T}\!_{A}$ - $^{(T}\!_{E}$ × $^{F}\!_{E}$ + $^{C}\!_{R}$ × $^{F}\!_{R})$ THE VOLUME WHICH THE SUITABLE EXCAVATED MATERIAL COULD OCCUPY IN EMBANKMENT.

F_E - SHRINKAGE FACTOR FOR EARTH

F_R - SWELL FACTOR FOR ROCK

NOTES:

THE CONTRACTOR'S ATTENTION IS DIRECTED TO THE FACT THAT THESE TABLES ARE ESTIMATED, AND ARE PROVIDED FOR THE PURPOSE OF PREPARING AN ESTIMATE. THEY ARE NOT TO BE CONSTRUED AS BEING EXACT. THEY ARE INTENDED TO QUANTIFY AND QUALIFY THE NATURE OF THE WORK TO BE PERFORMED. SIGNIFICANT DIFFERENCE FROM THIS REPRESENTATION, WHEN ENCOUNTERED DURING THE ACTUAL WORK, WILL BE HANDLED ACCORDING TO THE SPECIFICATIONS GOVERNING THIS PROJECT.


203.02 UNCLASSIFIED EXCAVATION AND DISPOSAL

203.03 EMBANKMENT IN PLACE

206.01 STRUCTURE EXCAVATION

206.0201 TRENCH AND CULVERT EXCAVATION

AS-BUILT REVISIONS DESCRIPTION OF ALTERATIONS:	LARGE CULVERT REPLACEMENTS AT MULTIPLE LOCATIONS	PIN 2LC1.31	BRIDGES	CUL VERTS C270037 C240033 C270026	ALL DIMENSIONS IN ft UNLESS OTHERWISE NOTED	CONTRACT NUMBER	
	CONTRACT 6				ALL CLIEC	D265553	
	S.H. 1355, S.H. 339, S.H. 562		C2700	C270026	ALL SITES		
	AVA, GEORGETOWN, CITY OF ROME	1			EARTHWORK SUMMARY	DRAWING NO.	ESS-01
	COUNTY: ONEIDA, MADISON REGION: 2					SHEET NO.	34
IT IS A VIOLATION OF LAW FOR ANY PERSON, UNLESS THEY ARE ACTING UNDER THE DIRECTION OF A LICENSED PROFESSIONAL ENGINEER, ARCHITECT, LANDSCAPE ARCHITECT, OR LAND SURVEYOR, TO ALTER AN ITEM IN ANY WAY. IF AN ITEM BEARING THE STAMP OF A LICENSED PROFESSIONAL IS ALTERED, THE ALTERING ENGINEER, ARCHITECT, LANDSCAPE ARCHITECT, OR LAND SURVEYOR SHALL STAMP THE DOCUMENT AND INCLUDE THE NOTATION "ALTERED BY" FOLLOWED BY THEIR SIGNATURE, THE DATE OF SUCH ALTERATION, AND A SPECIFIC DESCRIPTION OF THE ALTERATION.					٤	NEW YORK Departme	

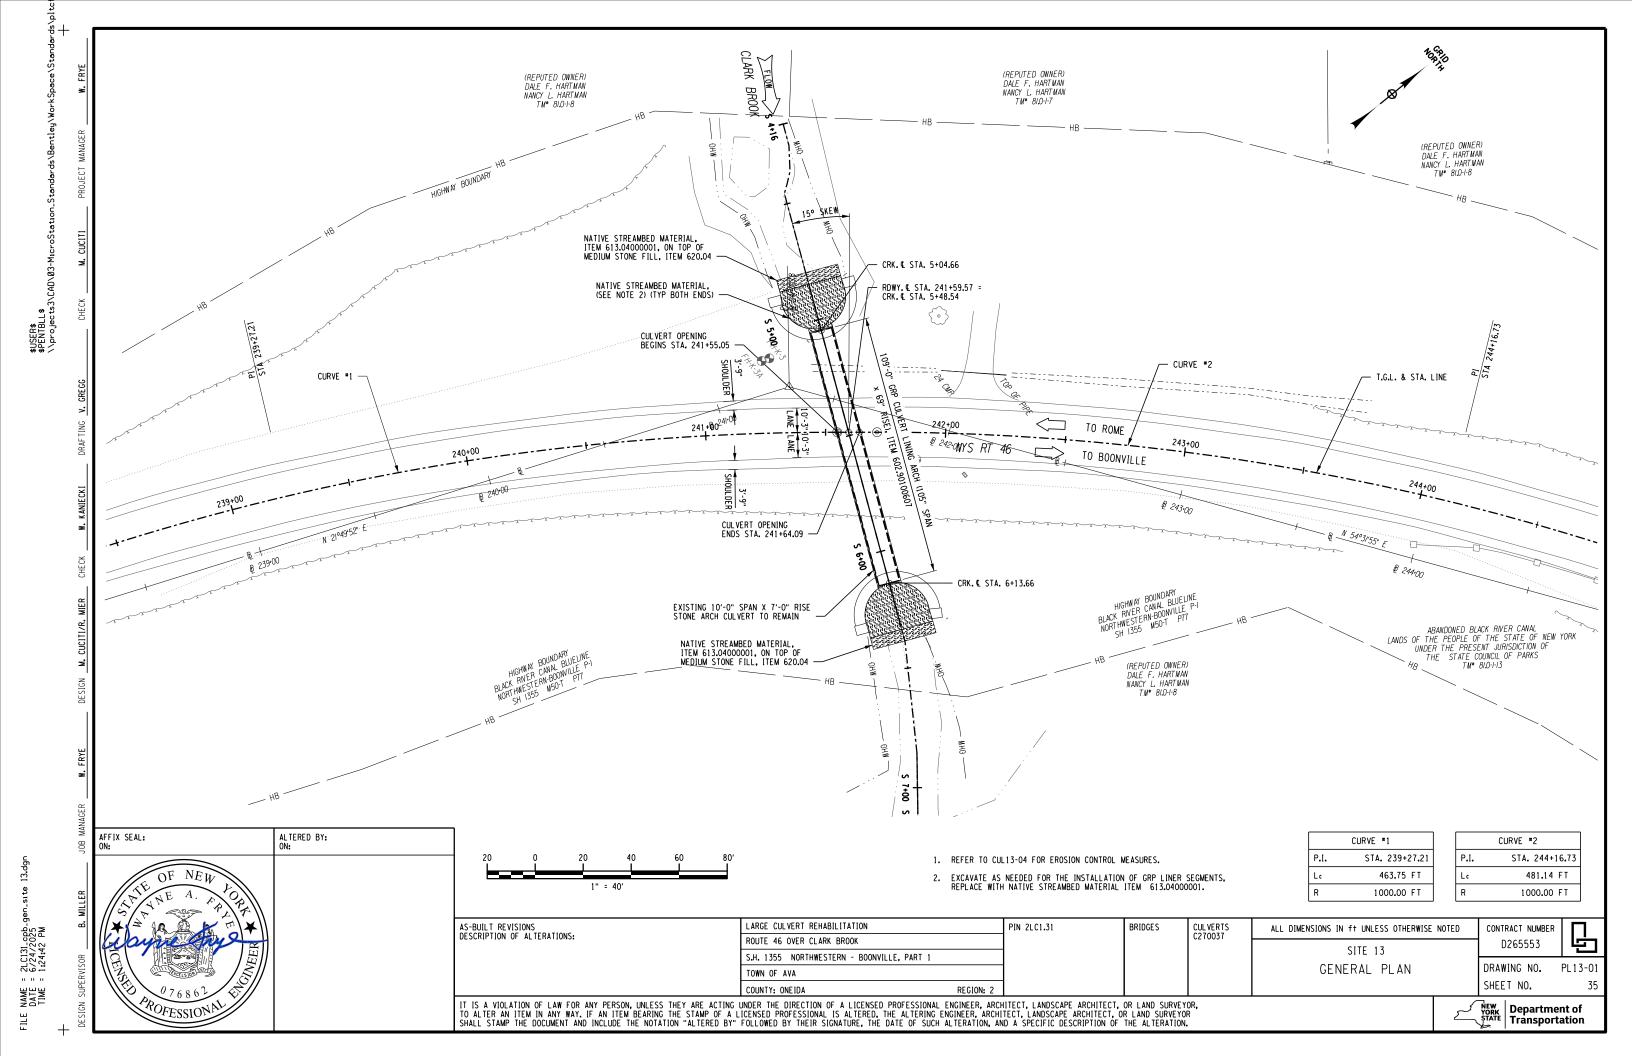

AFFIX SEAL:

INDEX DESCRIPTION DRAWING NO. NOTES & INDEX CUL 13-01 38 CULVERT PLAN & SECTION CUL 13-02 CUL 13-03 39 CULVERT TRANSVERSE SECTION 40 EXCAVATION PLAN, SECTION, AND EROSION CONTROL MEASURES CUL13-04

GENERAL / CULVERT LINING NOTES:

THE CONTRACTOR'S ATTENTION IS DIRECTED TO THE FACT THAT, DUE TO THE NATURE OF RECONSTRUCTION PROJECTS, THE EXACT EXTENT OF RECONSTRUCTION WORK CANNOT ALWAYS BE ACCURATELY DETERMINED PRIOR TO THE COMMENCEMENT OF WORK THESE CONTRACT DOCUMENTS HAVE BEEN PREPARED BASED ON FIELD INSPECTION AND OTHER INFORMATION AVAILABLE AT THE TIME, ACTUAL FIELD CONDITIONS MAY REQUIRE MODIFICATIONS TO CONSTRUCTION DETAILS AND WORK QUANTITIES. THE CONTRACTOR SHALL PERFORM THE WORK IN ACCORDANCE WITH

THE LENGTH OF EACH STRUCTURE SEGMENT SHALL BE DETERMINED BY THE CONTRACTOR, DEPTH OF COVER OVER THE CULVERT BEING RELINED VARIES AND THE WATER TABLE IS ESTIMATED AT 13 FEET BELOW GRADE AT THE ROADWAY.

A BEVEL SHALL BE FORMED AROUND THE ENTIRE CIRCUMFERENCE OF THE INLET.

SKIDS MAY BE INSTALLED ALONG ARCH CULVERT AND TIMBER FLOOR TO FACILITATE INSTALLATION. NEW INVERTS SHALL BE RAISED BY LEAST EXTENT POSSIBLE AND STILL PROVIDE A MINIMUM ANNULAR SPACE OF 1 INCH FOR GROUTING BETWEEN THE NEW AND EXISTING CULVERTS.

REFER TO NYSDOT STANDARD SPECIFICATIONS SECTION 602 FOR CLEANING, PREPARATION, AND INSPECTION OF EXISTING ARCH CULVERT PRIOR TO LINING OPERATION, PAID FOR UNDER ITEM 602.90100607.

DUE TO CHANGING FIELD CONDITIONS, PRIOR TO ORDERING LINER, AND AFTER CLEARING SOIL FROM THE CULVERT INTERIOR, CONTRACTOR SHALL VERIFY THE RISE, SPAN, AND LENGTH; AND MINIMUM RADIUS OF THE CULVERT, COST TO BE INCLUDED IN THE UNIT PRICE FOR ITEM 602.90100607.

THE CONTRACTOR SHALL PERFORM ALL WORK WITH CARE SO THAT ANY MATERIALS WHICH ARE TO REMAIN IN PLACE. OR WHICH ARE TO REMAIN THE PROPERTY OF THE STATE, WILL NOT BE DAMAGED. IF THE CONTRACTOR DAMAGES ANY MATERIALS WHICH ARE TO REMAIN IN PLACE OR WHICH ARE TO REMAIN THE PROPERTY OF THE STATE, THE DAMAGED MATERIALS SHALL BE REPAIRED OR REPLACED IN A MANNER SATISFACTORY TO THE ENGINEER AT THE EXPENSE OF

THE PIPE LINER IS REQUIRED TO POSSESS ADEQUATE STRUCTURAL CAPACITY TO CARRY THE ENTRIE CALCULATED DEAD LOAD AND HL-93 LIVE LOADING (PROVIDING A MINIMUM 1.2 INVENTORY RATING FACTOR).

THE CONTRACTOR SHALL NOT BE ALLOWED TO DROP WASTE GROUT, DEBRIS AND OTHER MATERIAL TO THE AREA BELOW THE CULVERT, PLATFORMS, NETS, SCREENS OR OTHER PROTECTIVE DEVICES SHALL BE USED TO CATCH THE MATERIAL. IF THE ENGINEER DETERMINES THAT ADEQUATE PROTECTIVE DEVICES ARE NOT BEING EMPLOYED, THE WORK SHALL BE SUSPENDED UNTIL ADEQUATE PROTECTION IS PROVIDED. ALL MATERIAL FALLING ON THE AREA BELOW AND AJACENT TO THE CULVERT SHALL BE REMOVED AND DISPOSED OF BY THE CONTRACTOR AT NO COST TO THE STATE.

FINAL PLACEMENT OF THE PROPOSED LINER SHALL BE A.O.B.E.

FOR DETAILS SEE SHEETS MSD-01 THROUGH MSD-03.

HYDRAULIC NOTES:

THE COST OF DEWATERING THE ENTIRE EXCAVATION, REGARDLESS OF THE SOURCE OF WATER, SHALL BE PAID UNDER ITEM 602,90100607.

ORDINARY HIGH-WATER IS ESTIMATED TO BE 774.82. ORDINARY HIGH-WATER IS DEFINED AS THE WATER SURFACE ELEVATION FOR THE MEAN ANNUAL FLOOD, WHICH IS THE FLOOD THAT HAS A RECURRENCE INTERVAL OF 2 YEARS.

ORDINARY WATER IS ESTIMATED TO BE 768.90. ORDINARY WATER IS DEFINED AS THE HIGHEST SURFACE WATER ELEVATION LIKELY TO BE ENCOUNTERED DURING ONE CONSTRUCTION SEASON (EXCLUDING MAJOR FLOODS). IT IS ALWAYS LESS THAN THE ORDINARY HIGH-WATER ELEVATION AND IT IS USUALLY AN OBSERVED ELEVATION RATHER

LOW WATER IS ESTIMATED TO BE 768.00 LOW WATER IS DEFINED AS THE NORMAL LOW WATER ELEVATION PREVALENT DURING ONE CONSTRUCTION SEASON FOR MORE THAN 25% OF THE TIME. IT IS AN OBSERVED ELEVATION RATHER THAN

THE 2-YEAR STORM EVENT HAS A FLOW OF 262.80 CFS.

THE 50-YEAR STORM EVENT HAS A FLOW OF 608.40 CFS

STREAM PROTECTION

DURING THE COURSE OF CONSTRUCTION, THE CONTRACTOR SHALL CONDUCT OPERATIONS IN SUCH A MANNER AS TO PREVENT OR REDUCE TO A MINIMUM ANY DAMAGE TO ANY STREAM FROM POLLUTION BY DEBRIS, SEDIMENT, OR OTHER FOREIGN MATERIAL, OR FROM MANIPULATION OF EQUIMENT AND/OR MATERIALS IN OR NEAR SUCH STREAMS. THE CONTRACTOR SHALL NOT RETURN DIRECTLY TO A STREAM ANY WATER WHICH HAS BEEN USED FOR WASH PURPOSES OR OTHER SIMILAR OPERATIONS WHICH CAUSE THE WATER TO BECOME POLLUTED WITH SAND, SILT, CEMENT, OIL, OR OTHER IMPURITIES, IF THE CONTRACTOR USES WATER FROM A STREAM, THE CONTRACTOR SHALL CONSTRUCT AN INTAKE OR TEMPORARY DAM REQUIERED TO PROECT AND MAINTAIN WATER RIGHTS AND TO SUSTAIN FISH LIFE

FOUNDATION NOTES:

THE CONTRACTOR SHALL TAKE CARE TO PROTECT THE TIMBER FLOORING BELIEVED TO EXIST BELOW THE EXISTING STRUCTURE. THE CONTRACTOR SHALL NOT PLACE STONE FILL OVER THE TIMBER FLOOR. IF TIMBER FLOORING IS DISCOVERED TO EXIST WITHIN THE EXCAVATION LIMITS SHOWN, THE LIMITS SHALL BE ADJUSTED A.O.B.E.



ALTERED BY:

ARGE CULVERT REHABILITATION ROUTE 46 OVER CLARK BROOK S.H. 1355 NORTHWESTERN - BOONVILLE, PART 1 TOWN OF AVA COUNTY: ONE IDA

PIN 2LC1.31 BRIDGES **CUL VERTS** C270037

ALL DIMENSIONS IN ft UNLESS OTHERWISE NOTED SITE 13

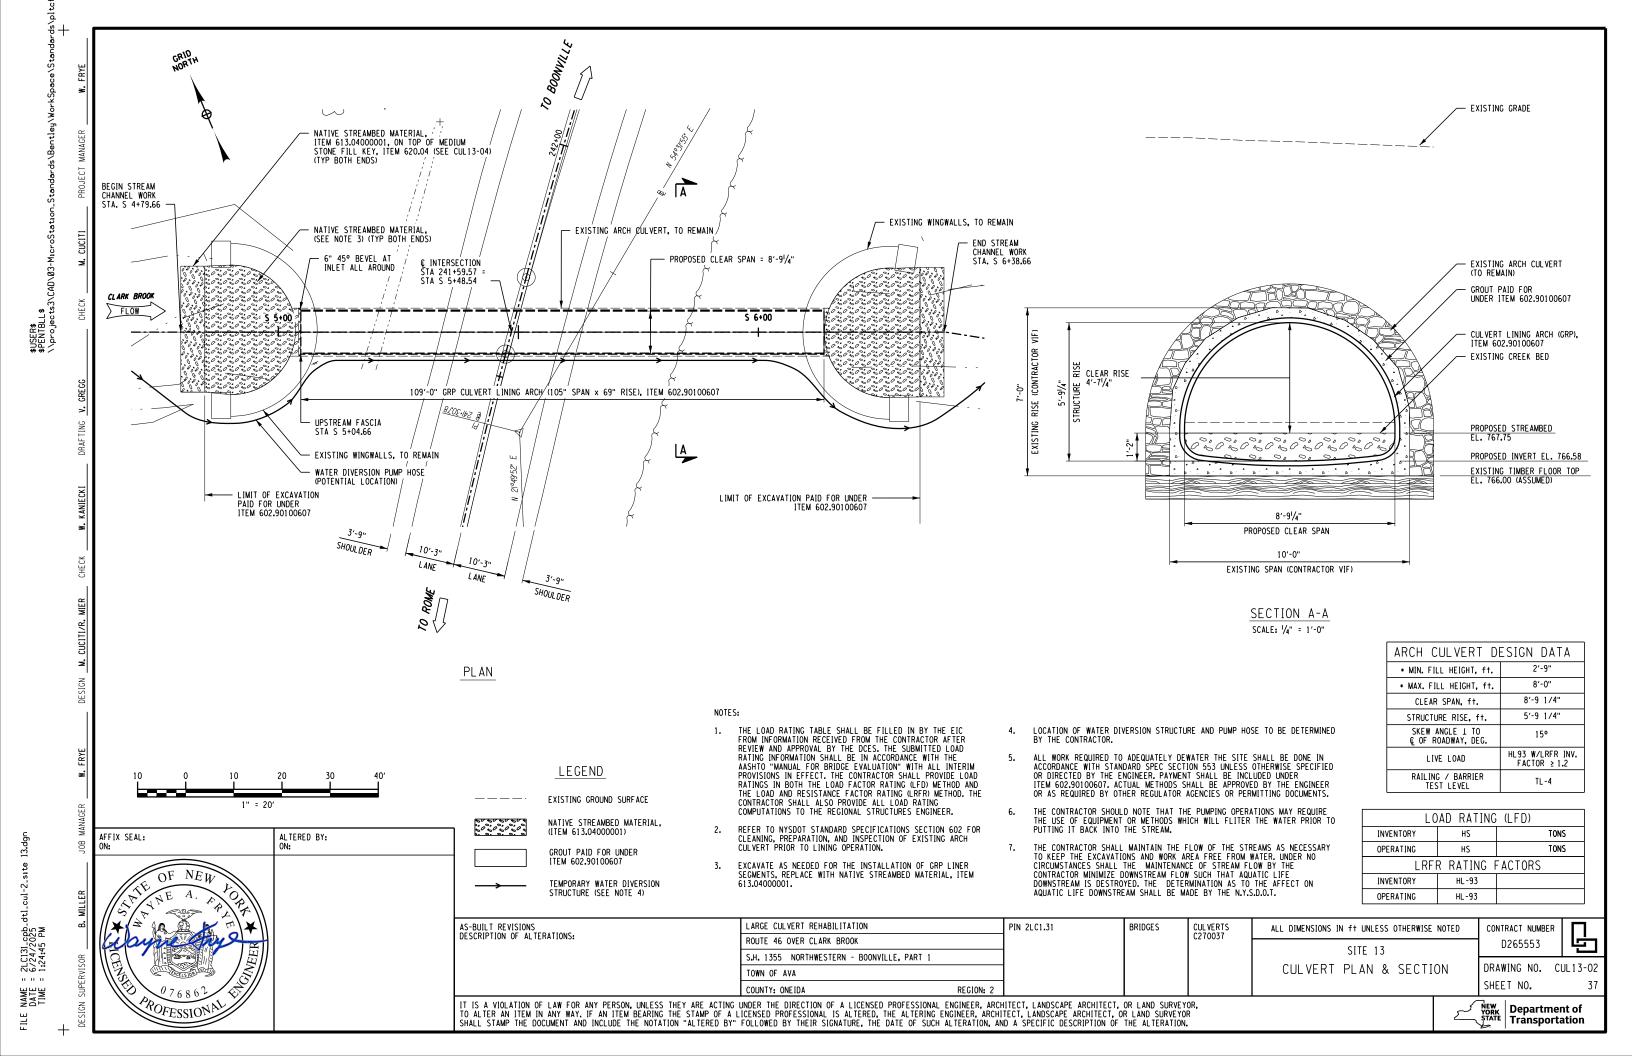
NOTES & INDEX

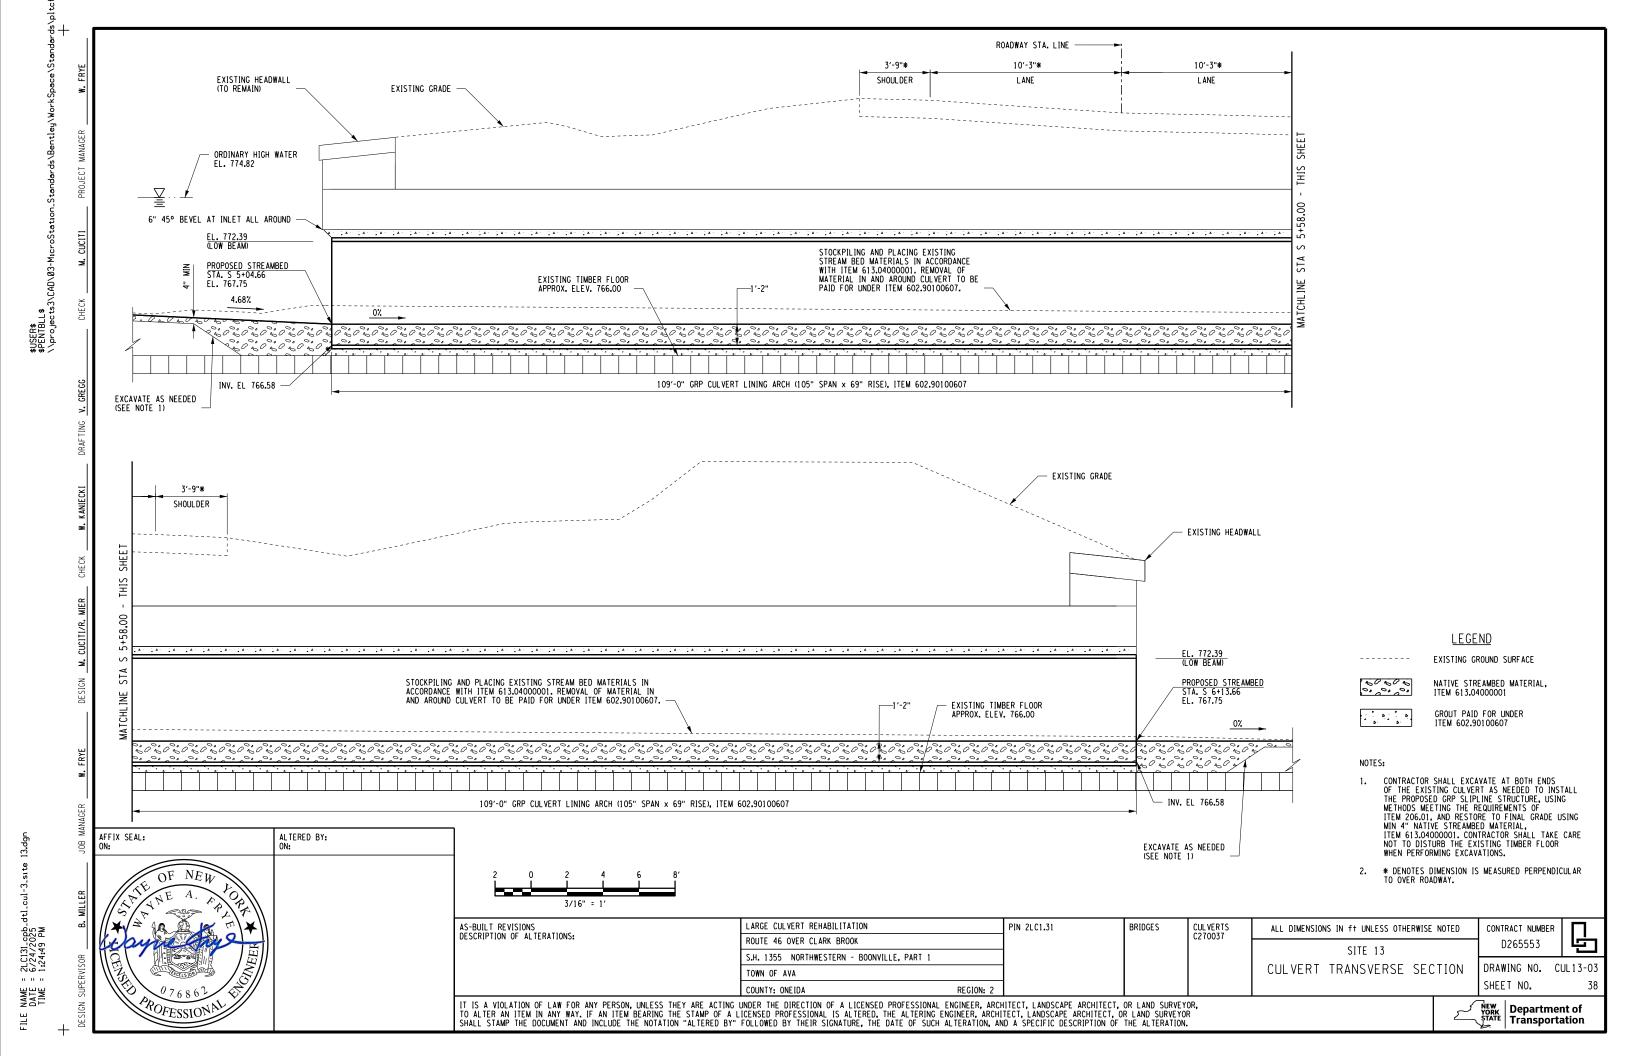
CONTRACT NUMBER D265553

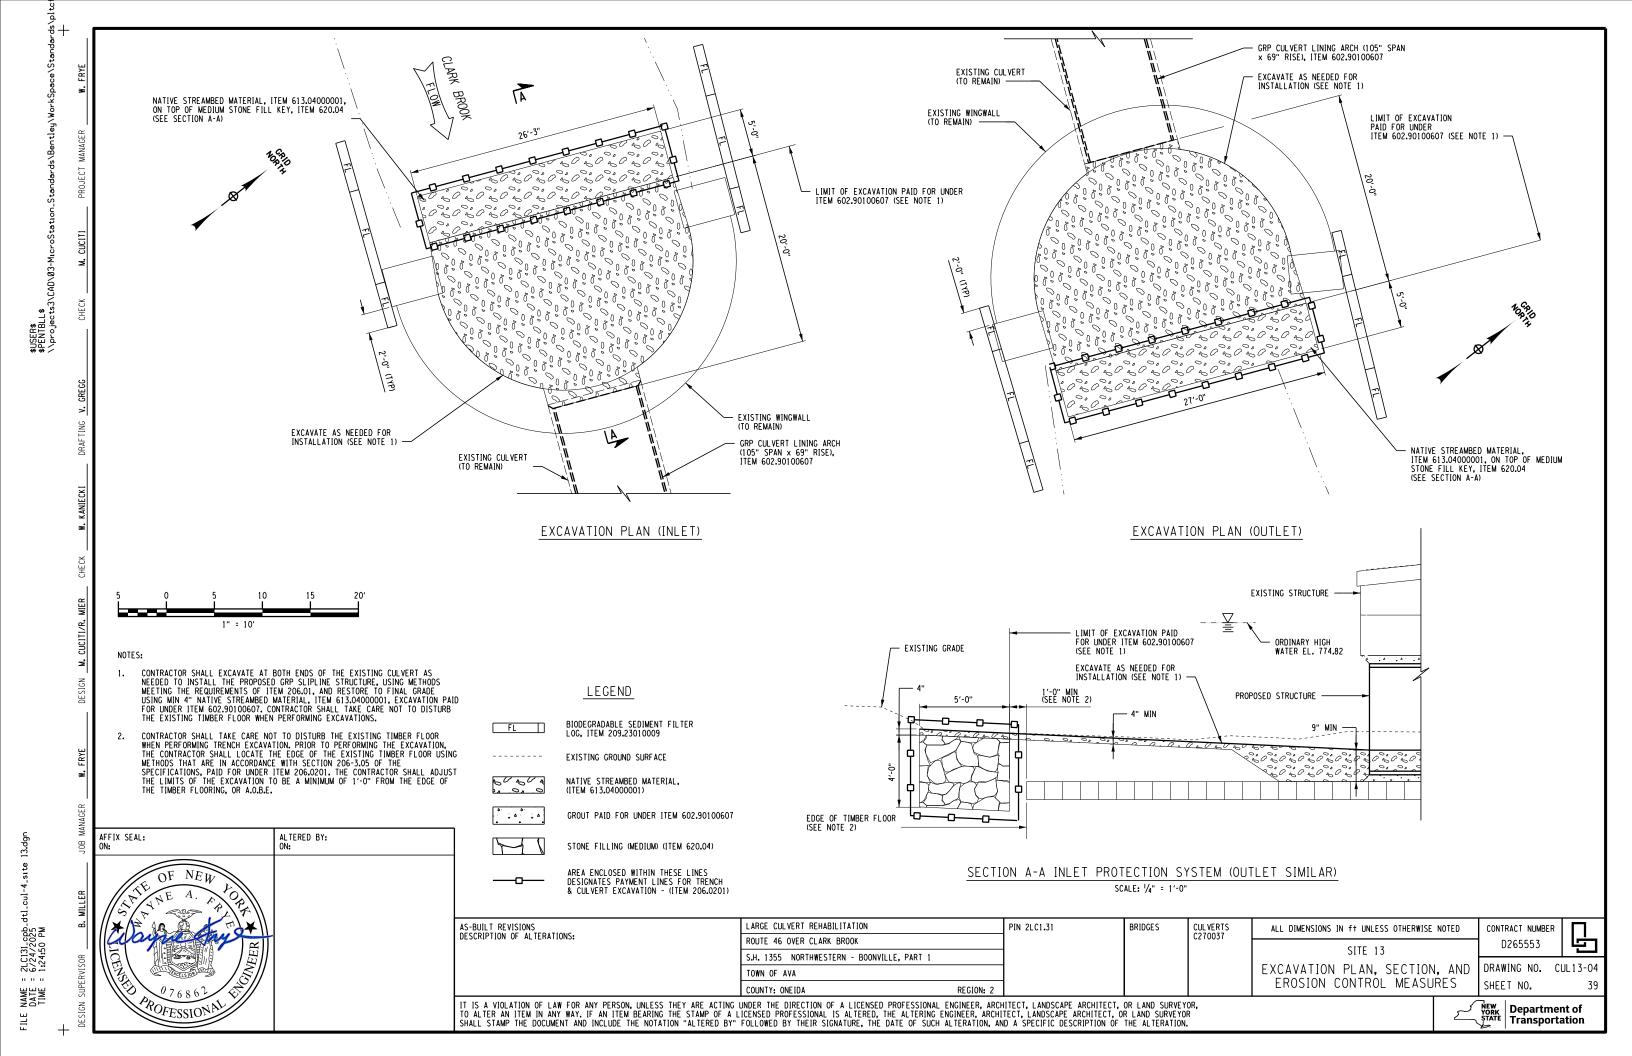
DRAWING NO. CUL 13-01 SHEET NO.

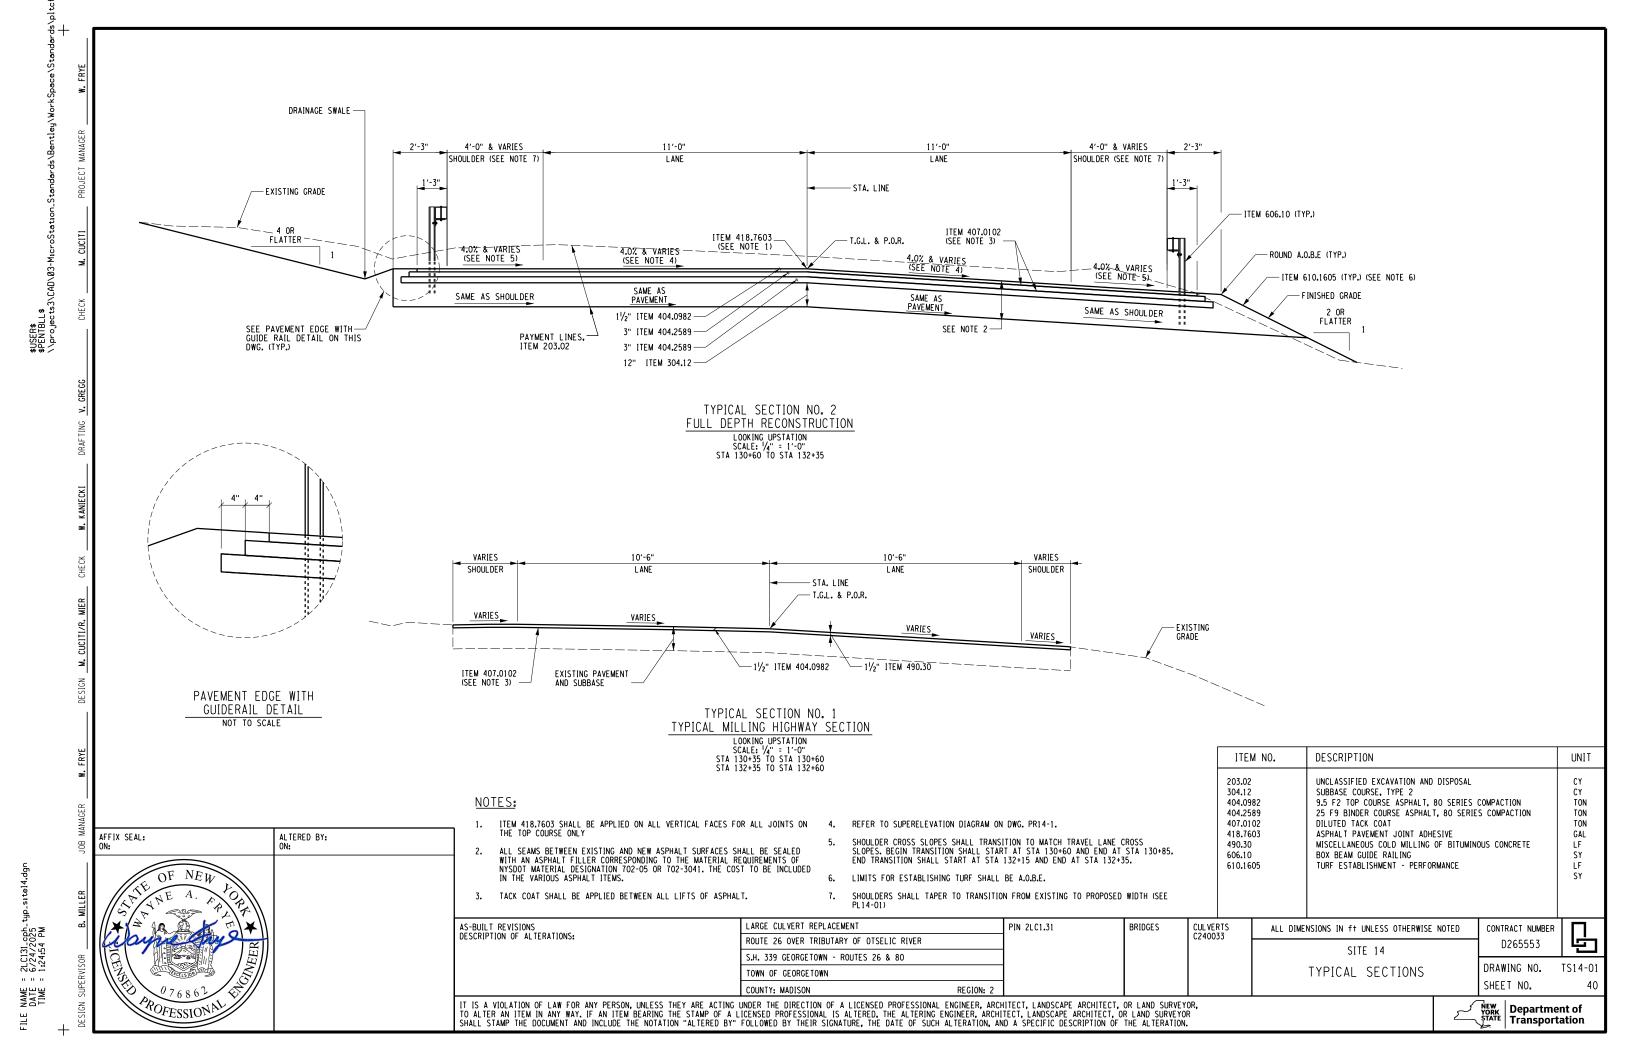
IT IS A VIOLATION OF LAW FOR ANY PERSON, UNLESS THEY ARE ACTING UNDER THE DIRECTION OF A LICENSED PROFESSIONAL ENGINEER, ARCHITECT, LANDSCAPE ARCHITECT, OR LAND SURVEYOR, TO ALTER AN ITEM IN ANY WAY. IF AN ITEM BEARING THE STAMP OF A LICENSED PROFESSIONAL IS ALTERED, THE ALTERING ENGINEER, ARCHITECT, LANDSCAPE ARCHITECT, OR LAND SURVEYOR SHALL STAMP THE DOCUMENT AND INCLUDE THE NOTATION "ALTERED BY" FOLLOWED BY THEIR SIGNATURE, THE DATE OF SUCH ALTERATION, AND A SPECIFIC DESCRIPTION OF THE ALTERATION.

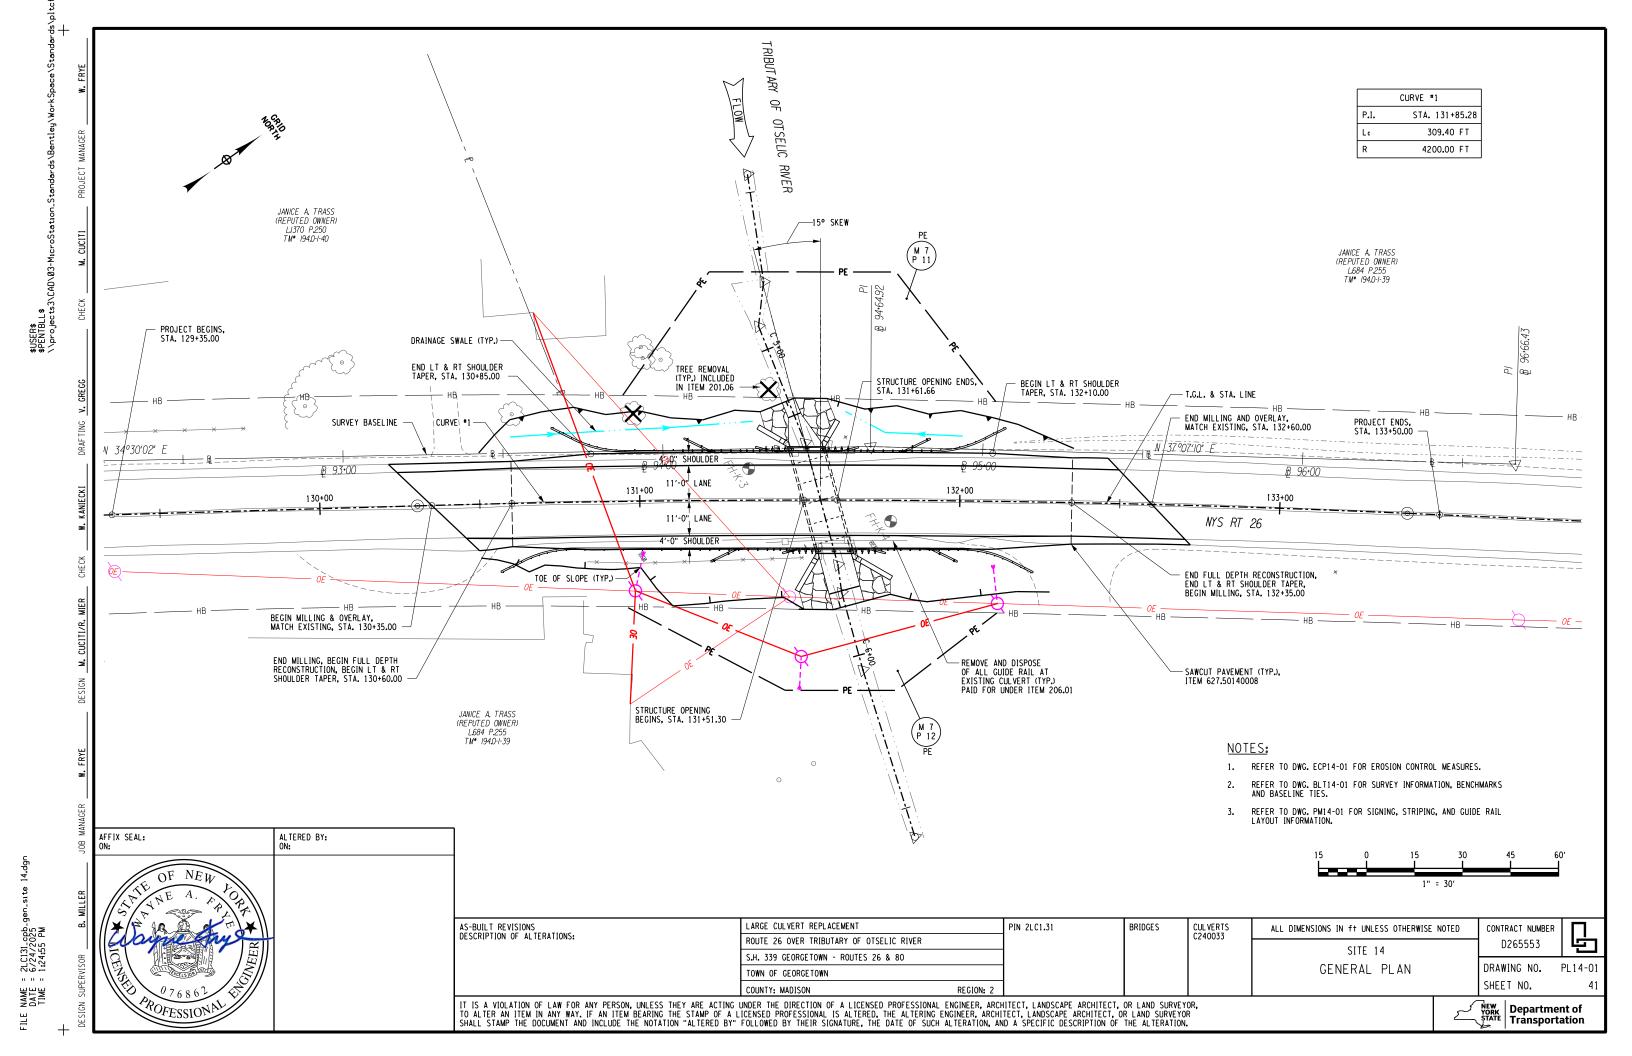


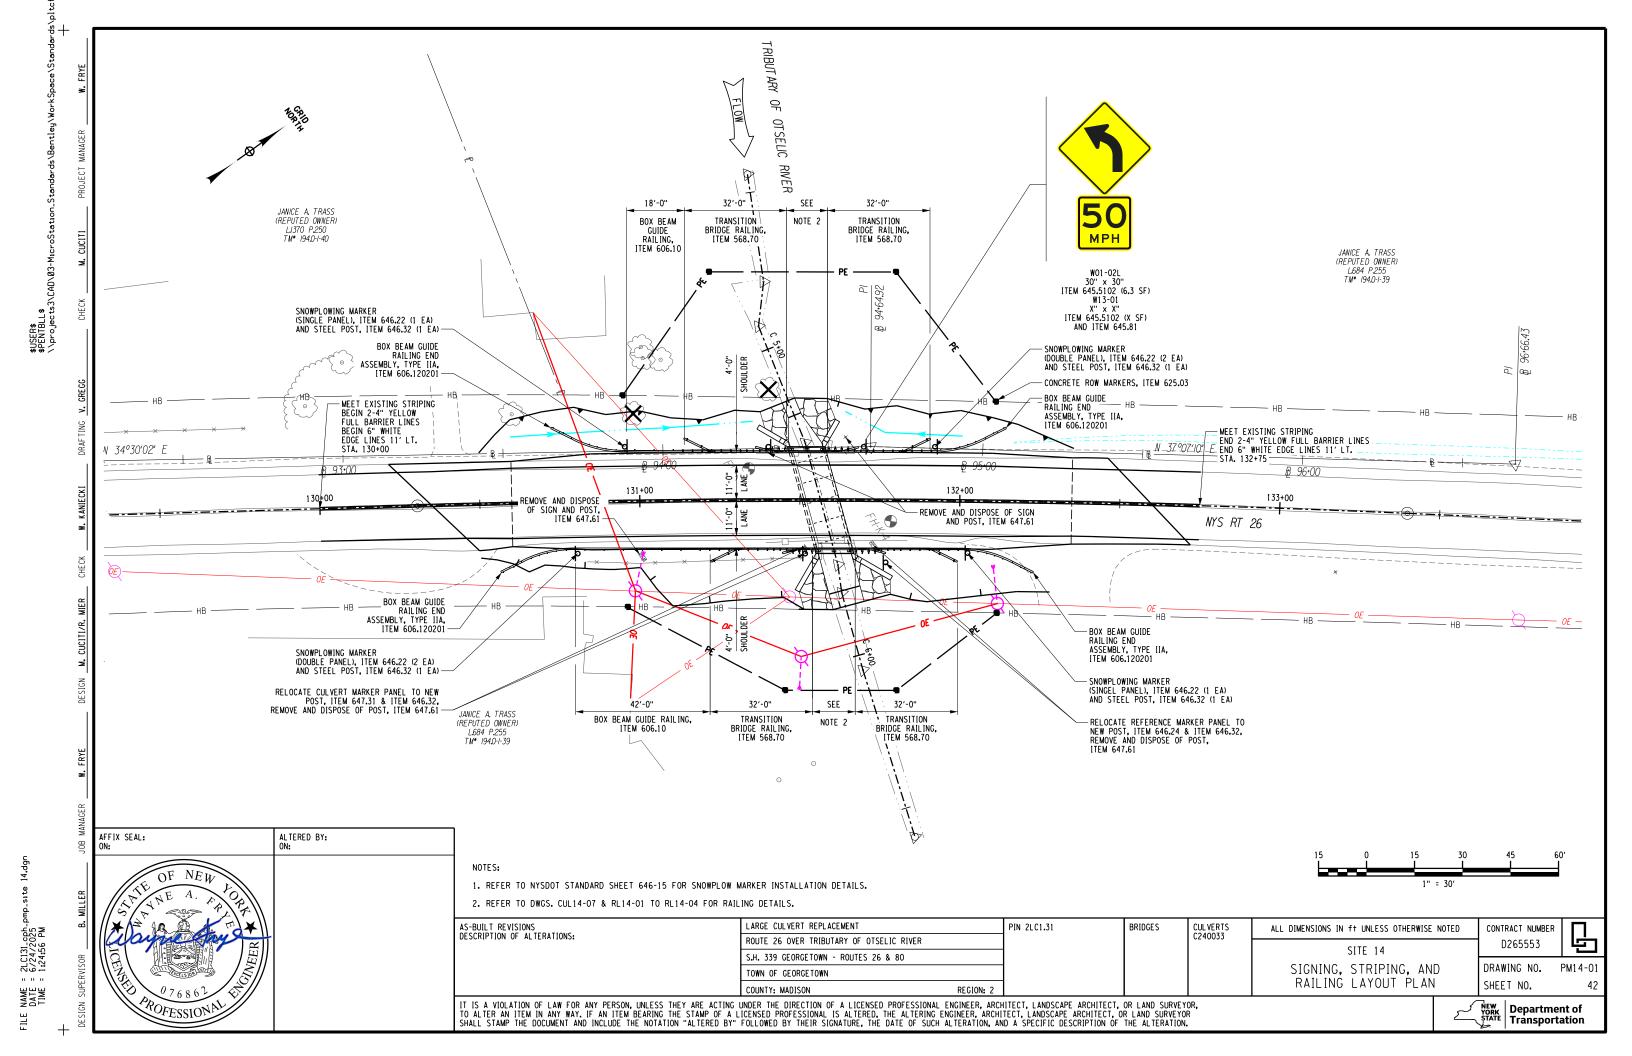


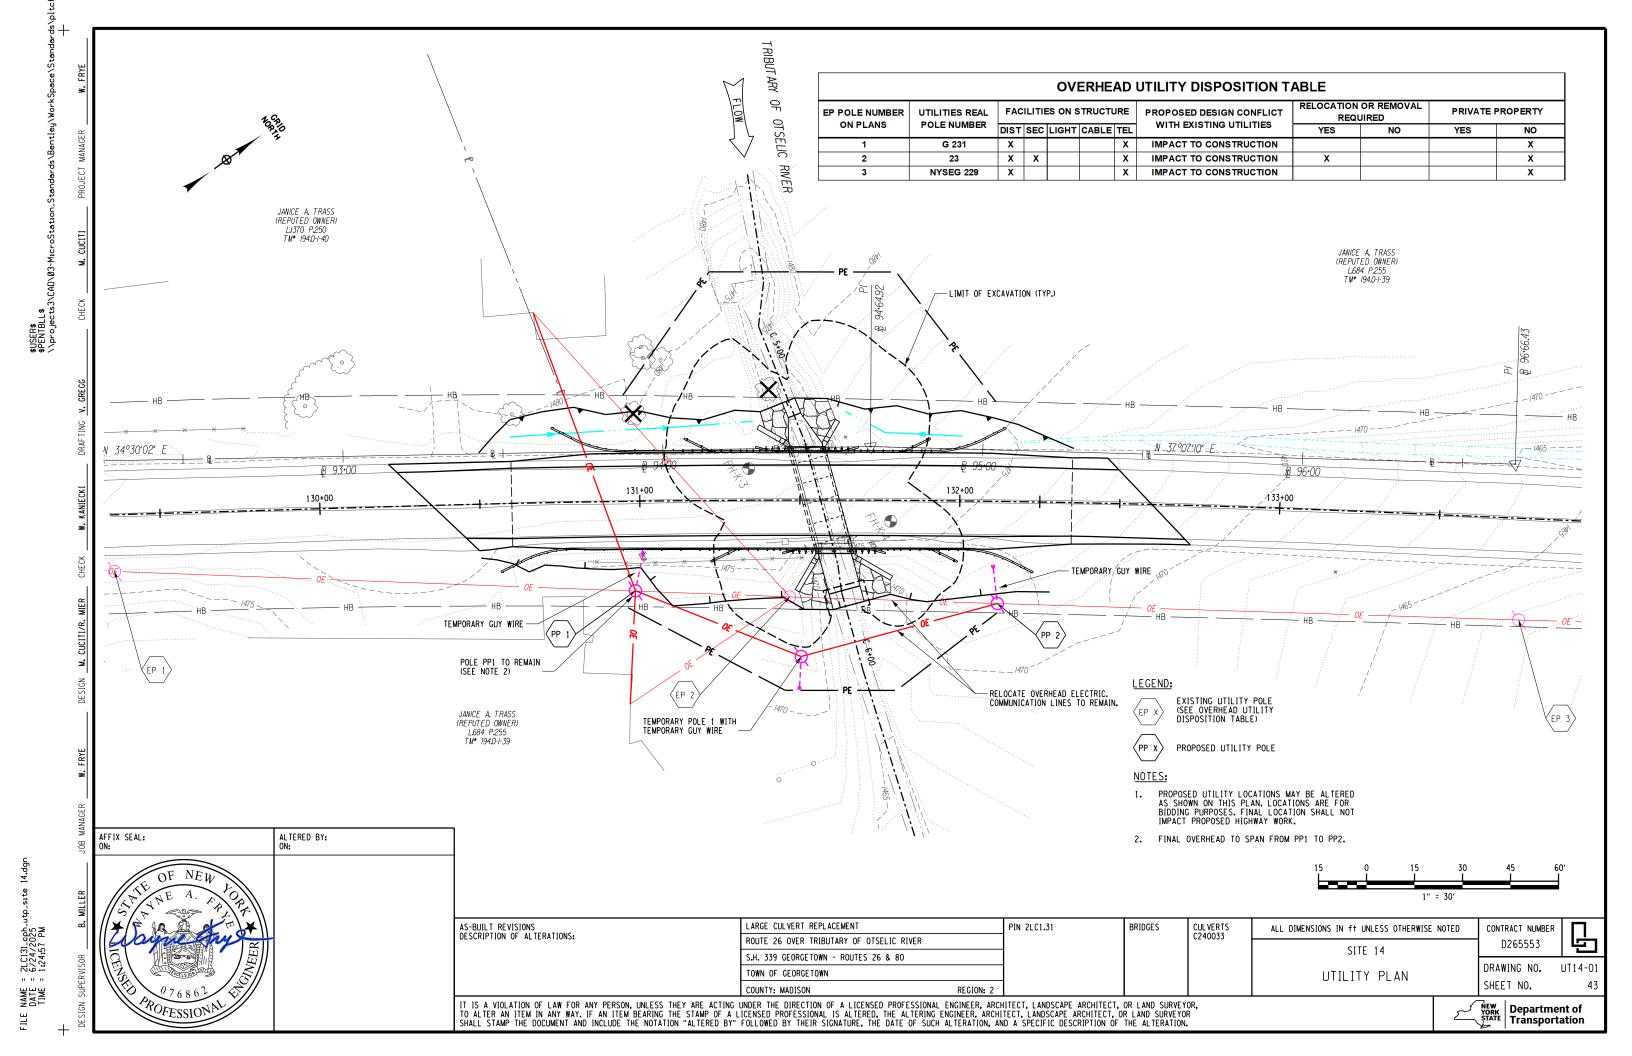


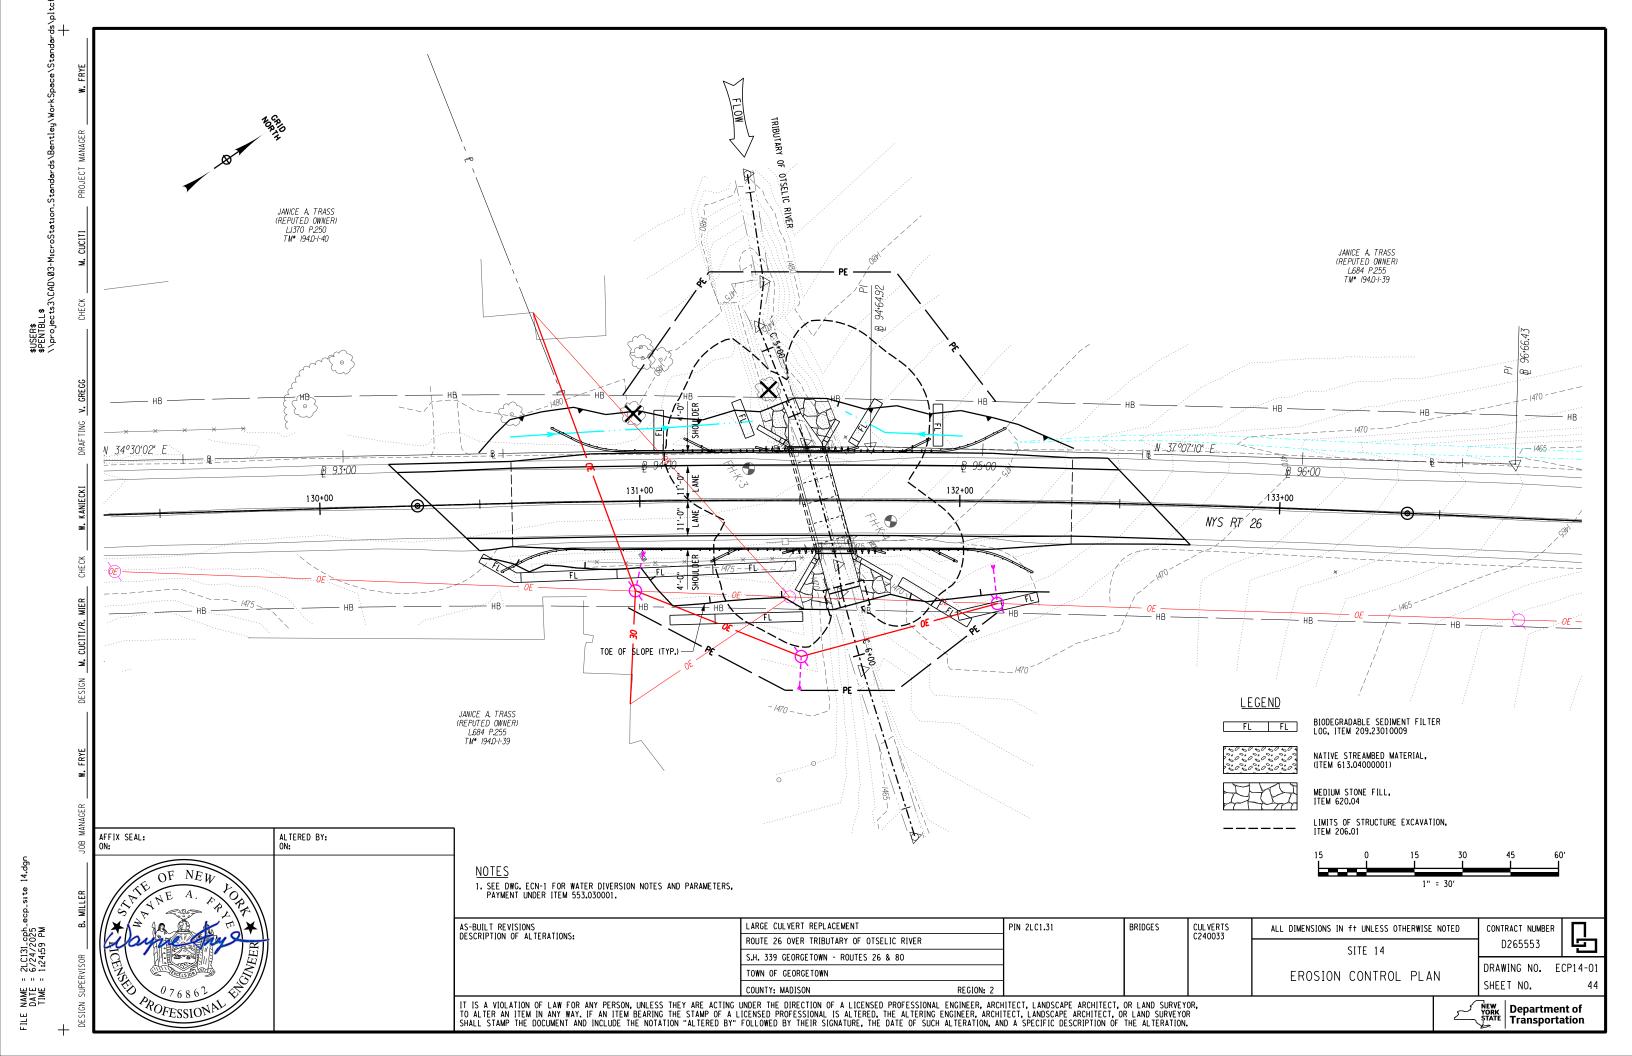












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	DATE	TIME	

AFFIX SEAL:

	INDEX					
SHEET NO.	DESCRIPTION	DRAWING NO.				
46	NOTES & INDEX	CUL 1 4-01				
47	CULVERT PLAN & ELEVATION	CUL 1 4-02				
48	CULVERT TRANSVERSE SECTION	CUL 14-03				
49	EXCAVATION PLAN	CUL 14-04				
50	EXCAVATION SECTIONS	CUL 1 4-05				
51	EXCAVATION SECTIONS	CUL 1 4-06				
52	RAILING LAYOUT AND HEADWALL DETAILS	CUL 14-07				

PRECAST CONCRETE BOX CULVERT NOTES:

ACTUAL WALL AND SLAB THICKNESSES, REINFORCEMENT SIZE AND SPACING TO BE DETERMINED BY FABRICATOR'S ENGINEER. IF THE ACTUAL TOP SLAB THICKNESS IS LESS THAN THE 1'-O" ASSUMED, THEN THE LOW BEAM ELEVATION SHALL BE HELD. IF THE ACTUAL TOP SLAB THICKNESS IS GREATER THAN 1'-O", CONTACT THE ENGINEER IN CHARGE.

THE LENGTH OF EACH STRUCTURE SEGMENT SHALL BE DETERMINED BY THE CONTRACTOR.

FOR MECHANICAL CONNECTORS IN TOP SLAB, SEE DWGS. CUL14-07 AND RL14-02.

ALL EXPOSED EDGES SHALL HAVE A CHAMFER OF 1".

REINFORCEMENT SHALL BE A.S.T.M. A615/M, GRADE 60 AND MEETING THE REQUIREMENTS OF SECTION 556 OF THE SPECIFICATIONS. THE MINIMUM CLEARANCE FOR REINFORCEMENT SHALL BE AS DETAILED ON THE PLANS. THE TOP MAT OF REINFORCEMENT SHALL BE EPOXY COATED.

THE ENTIRE TOP SLAB AND LEGS OF THE BOX UNIT SHALL BE COVERED WITH SHEET APPLIED WATERPROOFING MEMBRANE. STRIPS OF WATERPROOFING MEMBRANE SHALL BE PLACED OVER THE JOINTS BETWEEN THE BOX AND END

WHERE EPOXY THREADED INSERTS ARE SHOWN ANY NON-CORROSIVE MECHANICAL CONNECTOR MEETING STANDARD SPECIFICATION SECTION 709-10 MAY BE USED AS AN ALTERNATIVE.

DOWEL BARS USED TO ATTACH THE CUT-OFF WALL TO THE BOX CULVERT SHALL BE DRILLED AND GROUTED PER THE REQUIREMENTS OF STANDARD SPECIFICATION SECTION 586 EXCEPT THE GROUT SHALL MEET THE REQUIREMENTS OF §701-06 (PULL-OUT TEST NOT REQUIRED). THE KEYWAY SHALL BE GROUTED WITH THE SAME MATERIAL AS THE DOWELS. PLACE A BEAD OF CAULK, CLOSED CELL FOAM OR OTHER SUITABLE MATERIAL ON BOTH SIDES OF THE KEYWAY TO CONTAIN THE GROUT.

TOP OF BOX UNITS SHALL BE CROWNED AT 1.0% FROM & BOX TO DRAIN.

PRECAST CONCRETE BOX UNIT REFORCEMENT COVER REQUIREMENTS:
- TOP OF PRECAST BOX UNIT 2"

- ALL OTHER PRECAST BOX UNIT FACES 1"

SEE SHEETS MSD-01 AND MSD-02 FOR MISCELLANEOUS DETAILS.

GENERAL NOTES:

OVERHEAD ELECTRIC LINES AND A UTILITY POLE ARE IN PROXIMITY TO THIS CULVERT.

RECORD PLANS FOR THIS STRUCTURE ARE AVAILABLE AT THE NYSDOT DEPARTMENT OF TRANSPORTATION REGIONAL

HYDRAULIC NOTES:

THE COST OF DEWATERING THE ENTIRE EXCAVATION, REGARDLESS OF THE SOURCE OF WATER, SHALL BE INCLUDED IN THE UNIT PRICE BID FOR THE EXCAVATION ITEM(S).

ORDINARY HIGH- WATER IS ESTIMATED TO BE 1469.70. ORDINARY HIGH-WATER IS DEFINED AS THE WATER SURFACE ELEVATION FOR THE MEAN ANNUAL FLOOD, WHICH IS THE FLOOD THAT HAS A RECURRENCE INTERVAL OF 2 YEARS.

ORDINARY WATER IS ESTIMATED TO BE 1469.40. ORDINARY WATER IS DEFINED AS THE HIGHEST SURFACE WATER ELEVATION LIKELY TO BE ENCOUNTERED DURING ONE CONSTRUCTION SEASON (EXCLUDING MAJOR FLOODS). IT IS ALWAYS LESS THAN THE ORDINARY HIGH-WATER ELEVATION AND IT IS USUALLY AN OBSERVED ELEVATION RATHER THAN A COMPUTED ONE.

LOW WATER IS ESTIMATED TO BE 1469.30. LOW WATER IS DEFINED AS THE NORMAL LOW WATER ELEVATION PREVALENT DURING ONE CONSTRUCTION SEASON FOR MORE THAN 25% OF THE TIME. IT IS AN OBSERVED ELEVATION RATHER THAN A COMPUTED ONE.


THE 2-YEAR STORM EVENT HAS A FLOW OF 27.24 CFS.

THE 50-YEAR STORM EVENT HAS A FLOW OF 95.64 CFS.

FOUNDATION NOTES:

UNLESS OTHERWISE SHOWN ON THE CONTRACT PLANS, REMOVE EXISTING SUBSTRUCTURES AS FOLLOWS:

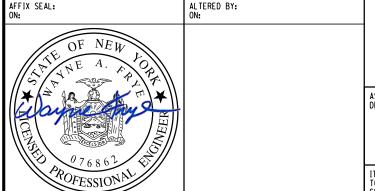- 1. COMPLETELY REMOVE THE PORTION OF THE EXISTING SUBSTRUCTURE WITHIN A LATERAL LIMIT OF 3 FEET
- 2. REMOVE THE PORTION OF THE EXISTING SUBSTRUCTURE THAT IS OUTSIDE OF THIS LATERAL LIMIT AS FOLLOWS:
 - A. EXISTING SUBSTRUCTURE LOCATED UNDER ROADWAY REMOVE TO 2.0 FEET BELOW SUBGRADE
 - B. EXISTING SUBSTRUCTURE LOCATED UNDER APPROACH EMBANKMENT END SLOPE REMOVE TO ELEVATION WHERE IT INTERSECTS THE BOTTOM OF THE STONE FILLING.
 - C. EXISTING SUBSTRUCTURE AT ALL OTHER LOCATIONS REMOVE TO 1.0 FOOT BELOW FINISHED GRADE.



ARGE CULVERT REPLACEMENT AS-BUILT REVISIONS DESCRIPTION OF ALTERATIONS: ROUTE 26 OVER TRIBUTARY OF OTSELIC RIVER S.H. 339 GEORGETOWN - ROUTES 26 & 80 TOWN OF GEORGETOWN

PIN 2LC1.31

CUL VERTS BRIDGES

C240033

ALL DIMENSIONS IN ft UNLESS OTHERWISE NOTED

SITE 14 NOTES & INDEX CONTRACT NUMBER D265553

DRAWING NO. CUL 14-01 SHEET NO.



IT IS A VIOLATION OF LAW FOR ANY PERSON, UNLESS THEY ARE ACTING UNDER THE DIRECTION OF A LICENSED PROFESSIONAL ENGINEER, ARCHITECT, LANDSCAPE ARCHITECT, OR LAND SURVEYOR, TO ALTER AN ITEM IN ANY WAY. IF AN ITEM BEARING THE STAMP OF A LICENSED PROFESSIONAL IS ALTERED, THE ALTERING ENGINEER, ARCHITECT, LANDSCAPE ARCHITECT, OR LAND SURVEYOR SHALL STAMP THE DOCUMENT AND INCLUDE THE NOTATION "ALTERED BY" FOLLOWED BY THEIR SIGNATURE, THE DATE OF SUCH ALTERATION, AND A SPECIFIC DESCRIPTION OF THE ALTERATION.

LOAD RATING (LFD)							
INVENTORY	HS	TONS					
OPERATING	HS	TONS					
LRFR RATING FACTORS							
INVENTORY	HL-93						
OPERATING	HL-93						
THE LOAD RATING TABLE SHALL BE FILLED IN BY THE EIC FRO							


INE LUAD MAINN IABLE SHALL BE FILLED IN BY THE EIG FROM INFORMATION RECEIVED FROM THE CONTRACTOR AFTER REVIEW AND APPROVAL BY THE DCES. THE SUBMITTED LOAD RATING INFORMATION SHALL BE IN ACCORDANCE WITH THE AASHTO "MANUAL FOR BRIDGE EVALUATION" WITH ALL INTERIM PROVISIONS IN EFFECT. THE CONTRACTOR SHALL PROVIDE LOAD RATINGS IN BOTH THE LOAD FACTOR RATING (LFD) METHOD AND THE LOAD AND RESISTANCE FACTOR RATING (LRFR) METHOD, THE CONTRACTOR SHALL ALSO PROVIDE ALL LOAD RATING COMPUTATIONS TO THE REGIONAL STRUCTURES ENGINEER.


BOX CULVERT DE	SIGN DATA
CLEAR SPAN, ft.	10.0
STRUCTURE RISE, ft.	6.0
* MIN. FILL HEIGHT, ft.	0.8
* MAX. FILL HEIGHT, ft.	2.8
SKEW ANGLE 1 TO © OF ROADWAY, DEG.	15
LIVE LOAD	HL93 W/LRFR INV. FACTOR ≥ 1.2
** RAILING / BARRIER TEST LEVEL	TL-4


- *BASED ON ASSUMED TOP SLAB THICKNESS OF 1 FT. FABRICATOR SHALL ADJUST BASED ON ACTUAL TOP SLAB THICKNESS. (DESIGNER TO FILL IN VALUE) MEASURED FROM THE TOP OF THE TOP SLAB TO THE TOP OF THE PAVEMENT.
- **THE FABRICATOR SHALL PROVIDE A POSITIVE CONNECTION BETWEEN THE SEGMENT WITH AN ATTACHED HEADWALL AND ITS ADJACENT SEGMENT.


	GEOTECHNICAL WINGWALL DESIGN DATA						
	FRICTION ANGLE OF SOIL RETAINED BY THE WALL (DEGREES)	FRICTION ANGLE OF FOUNDATION SOIL (DEGREES)	TOTAL SOIL UNIT WEIGHT (Ib/ft ³)	MAXIMUM SERVICE LIMIT STATE BEARING RESISTANCE (ID/ft)	NOMINAL COEFFICIENT OF FRICTION FOR SLIDING	STRENGTH LIMIT STATE RESISTANCE FACTOR FOR SLIDING	STRENGTH LIMIT STATE RESISTANCE FACTOR FOR BEARING
Γ	34	32	120	4.0	0.5	0.90	0.45

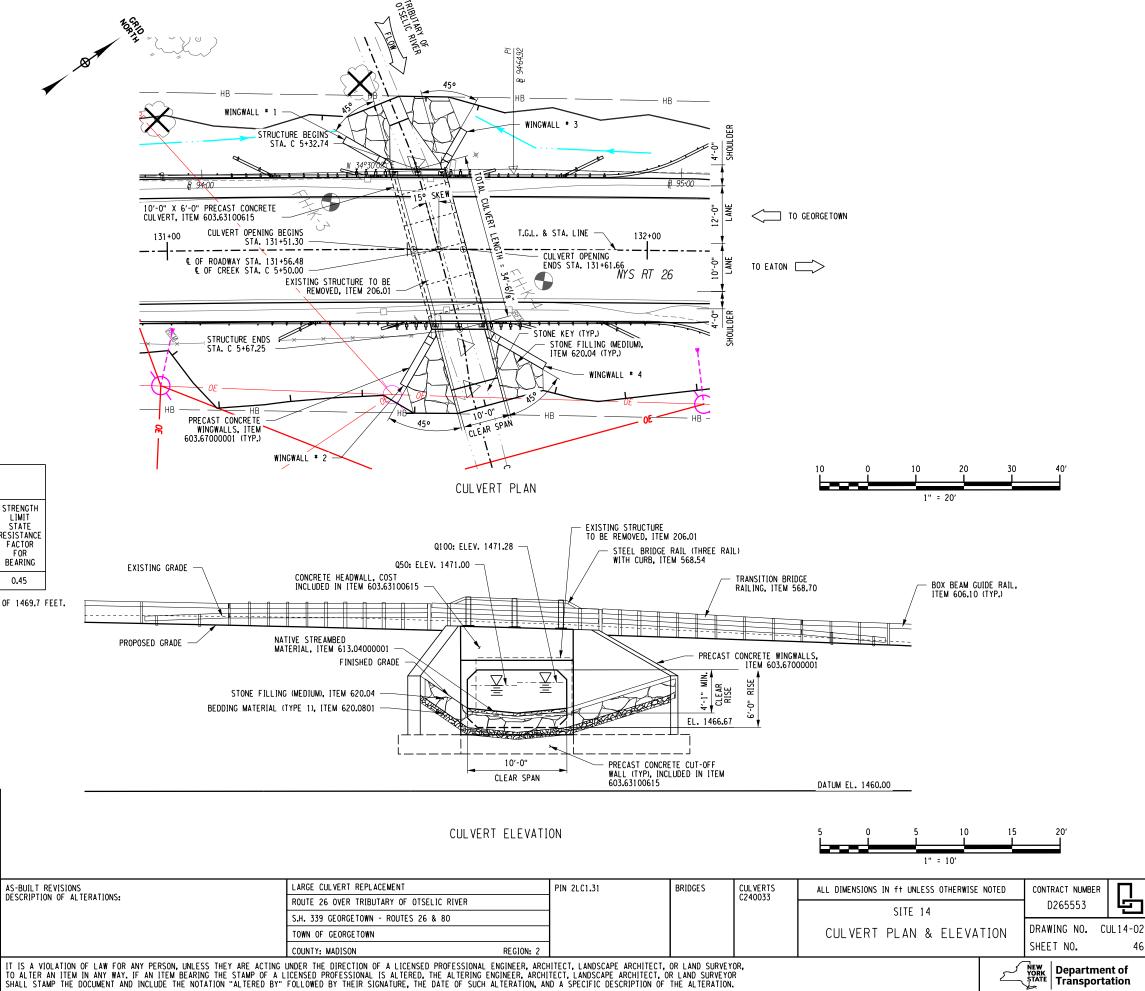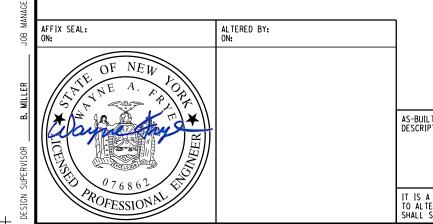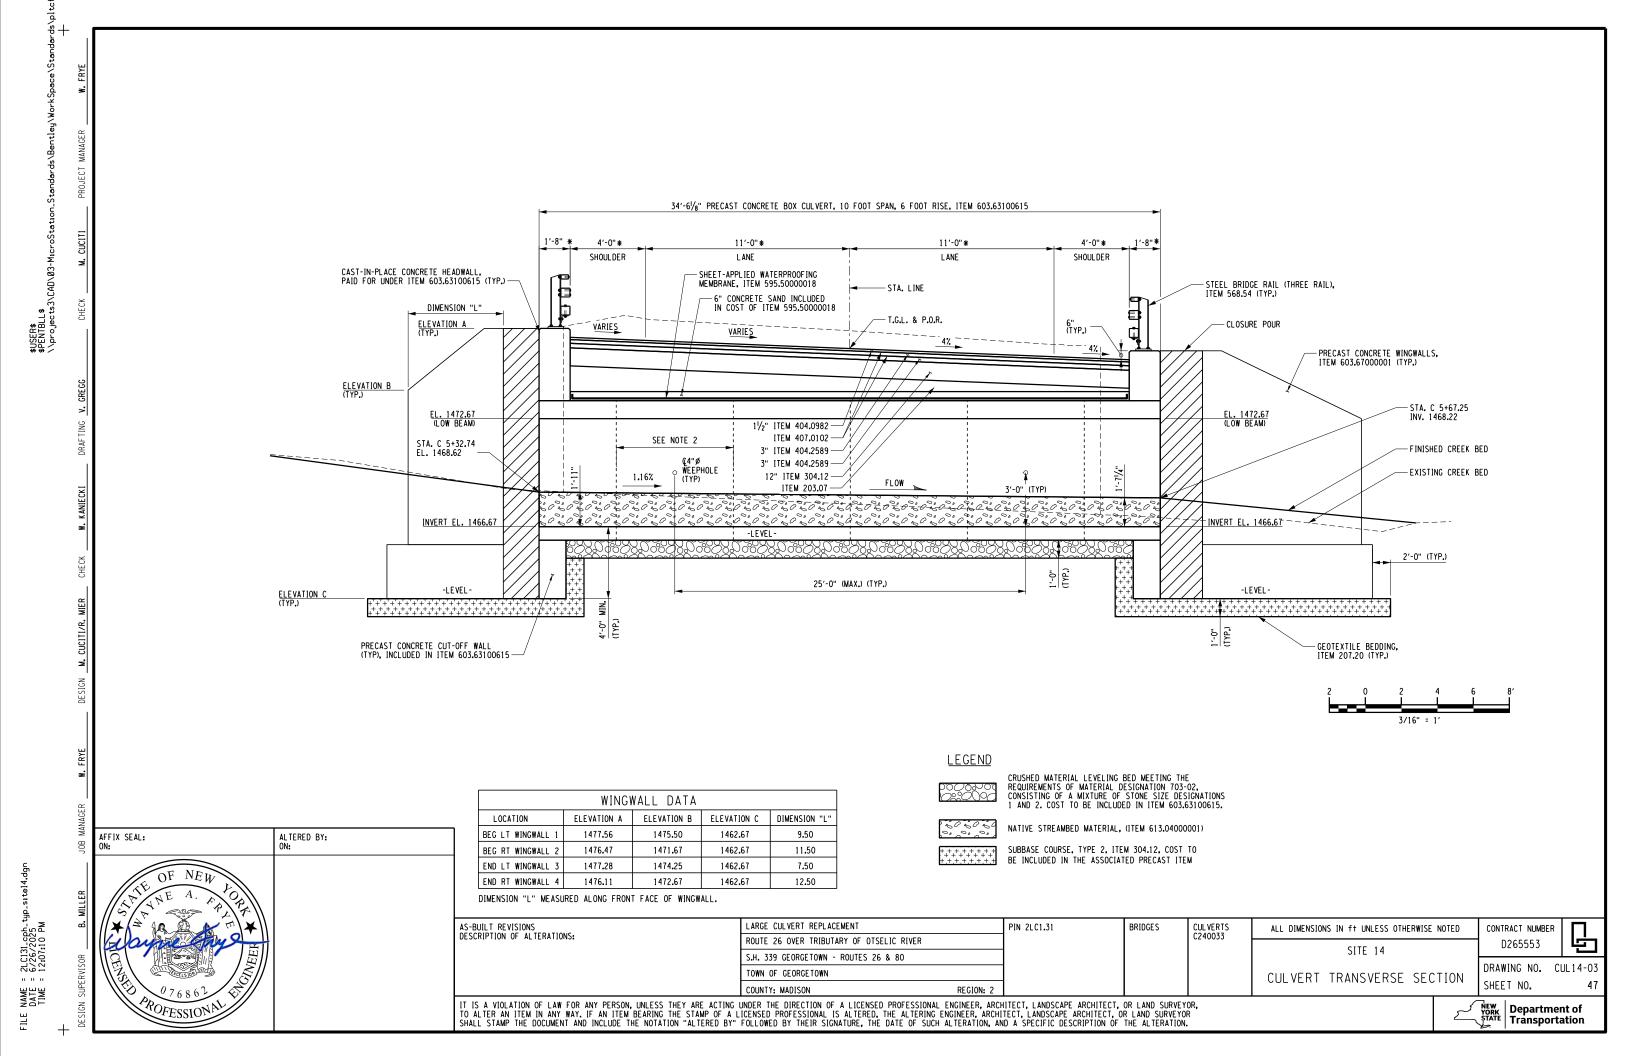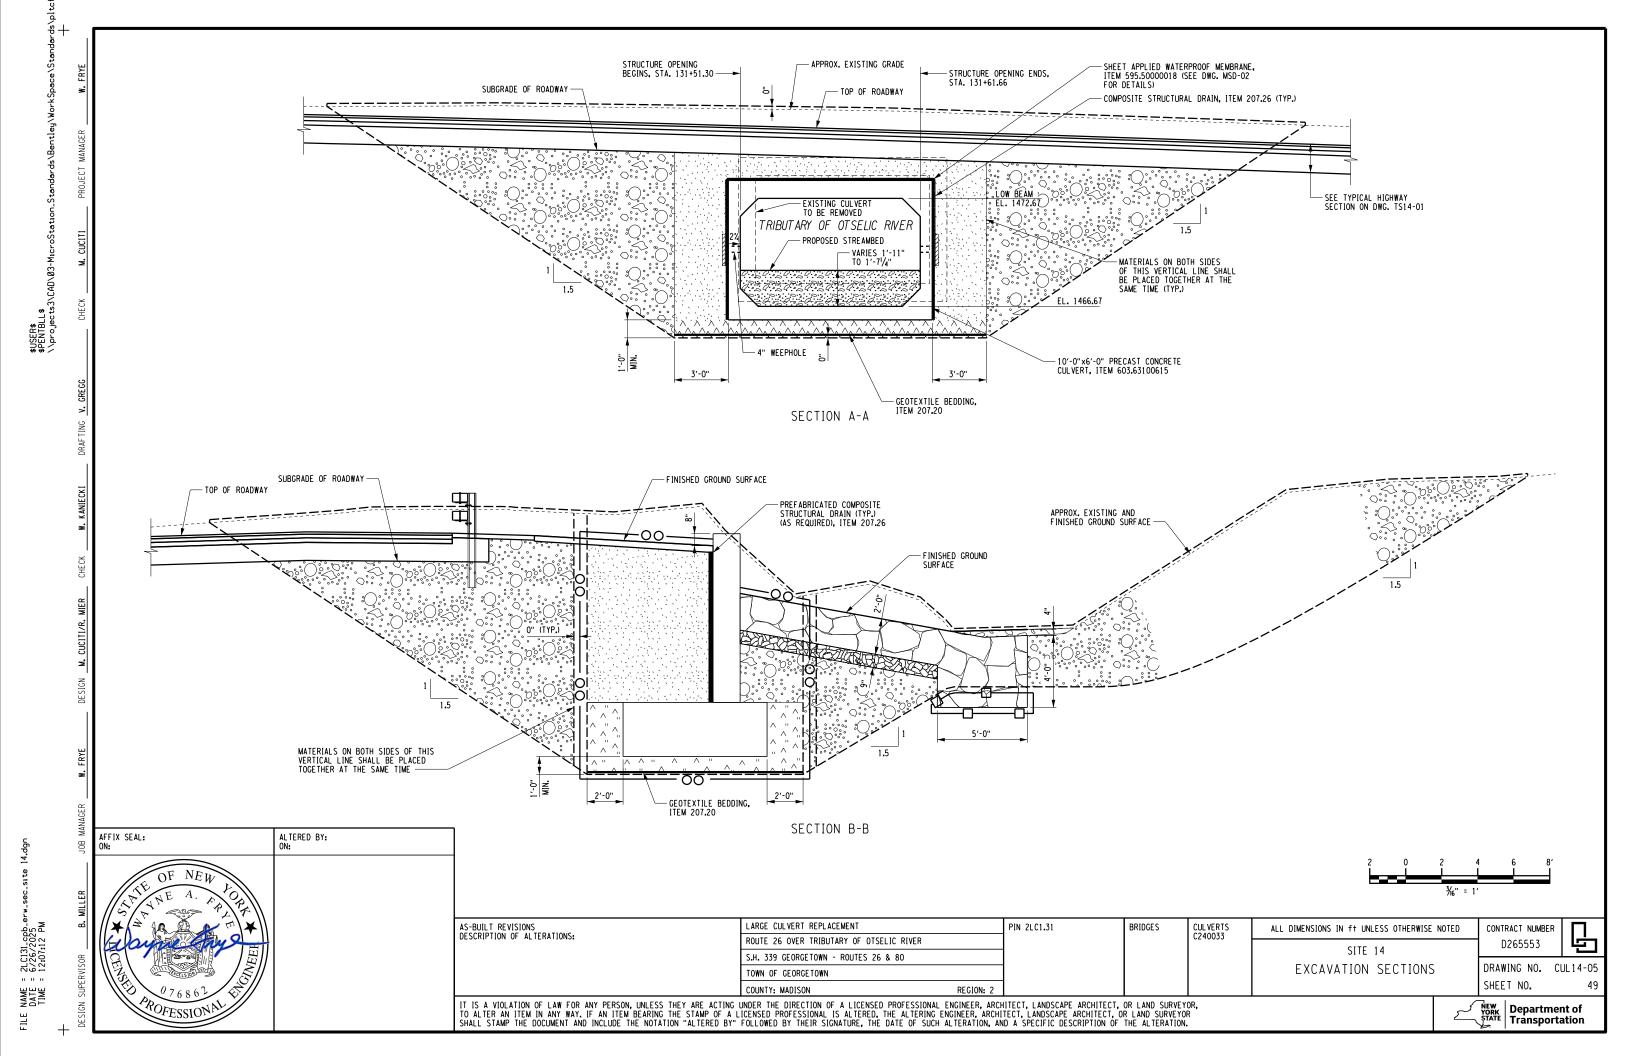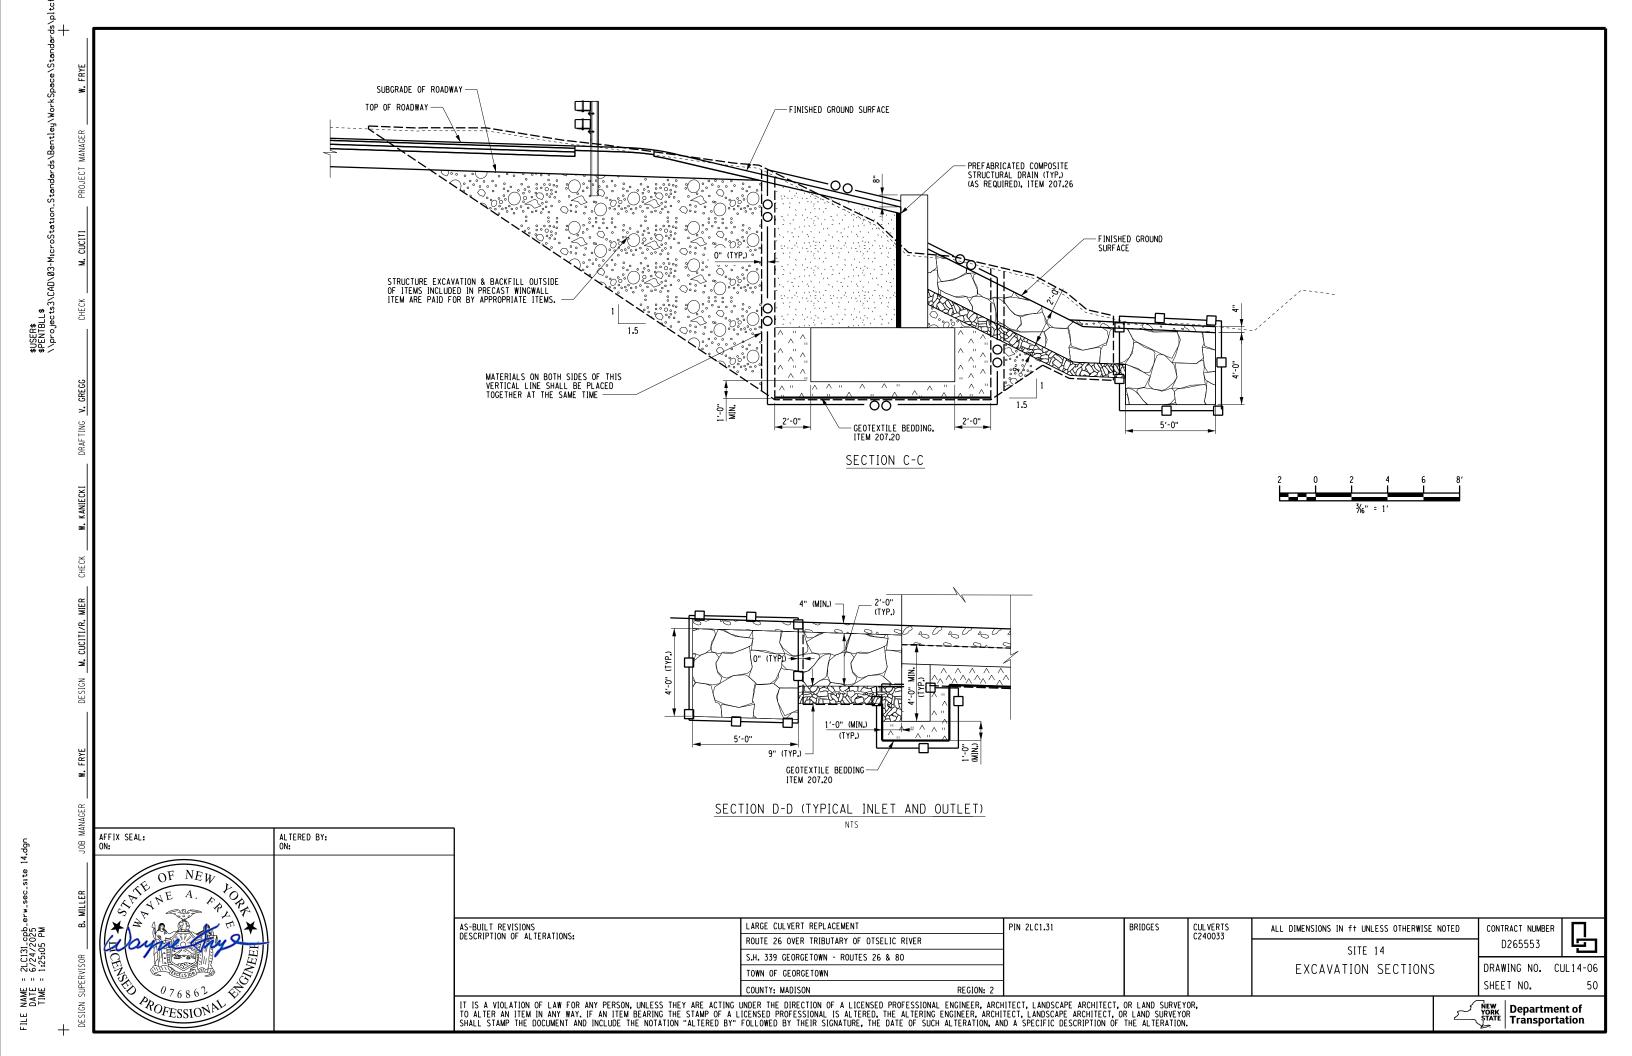
- 1. FOR THE SLIDING AND ECCENTRICITY ANALYSES, ASSUME A GROUND WATER ELEVATION OF 1469.7 FEET.
- 2. FOR THE BEARING ANALYSES, ASSUME A GROUNDWATER ELEVATION OF 1463 FEET.
- 3. USE SUBMERGED UNIT WEIGHTS BELOW THE GROUNDWATER ELEVATIONS PROVIDED.
- 4. ASSUME A SURCHARGE LOAD OF 250 POUNDS PER SQUARE FOOT.

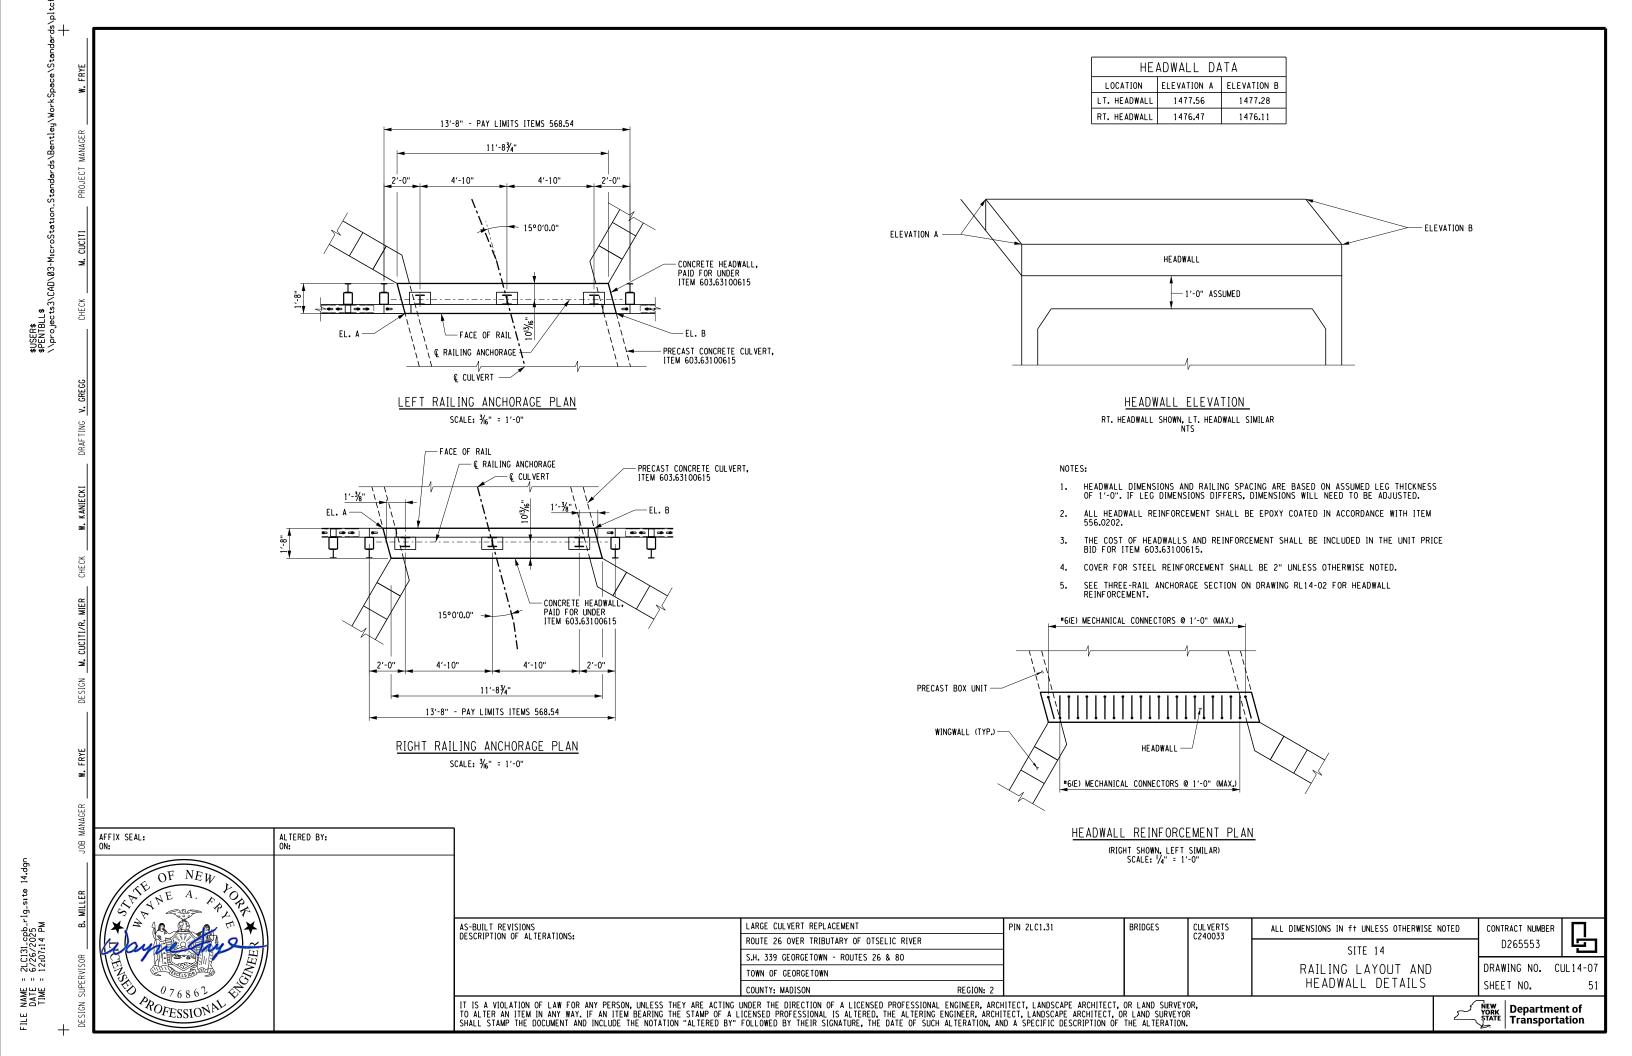


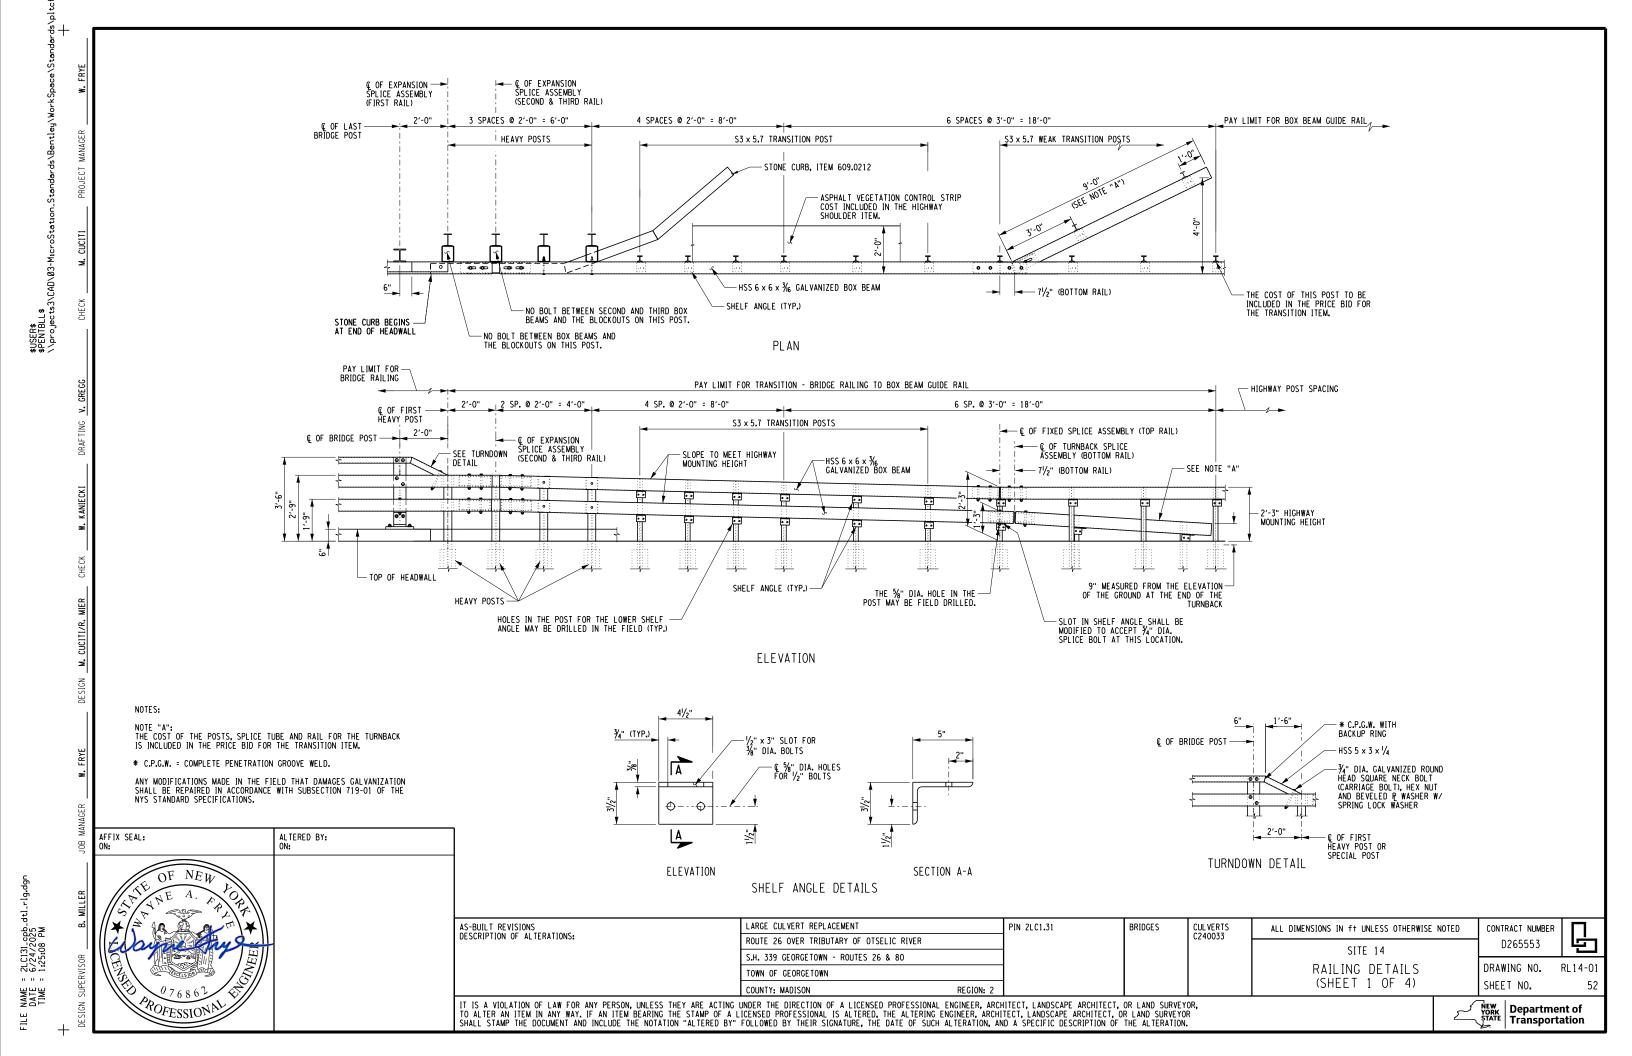


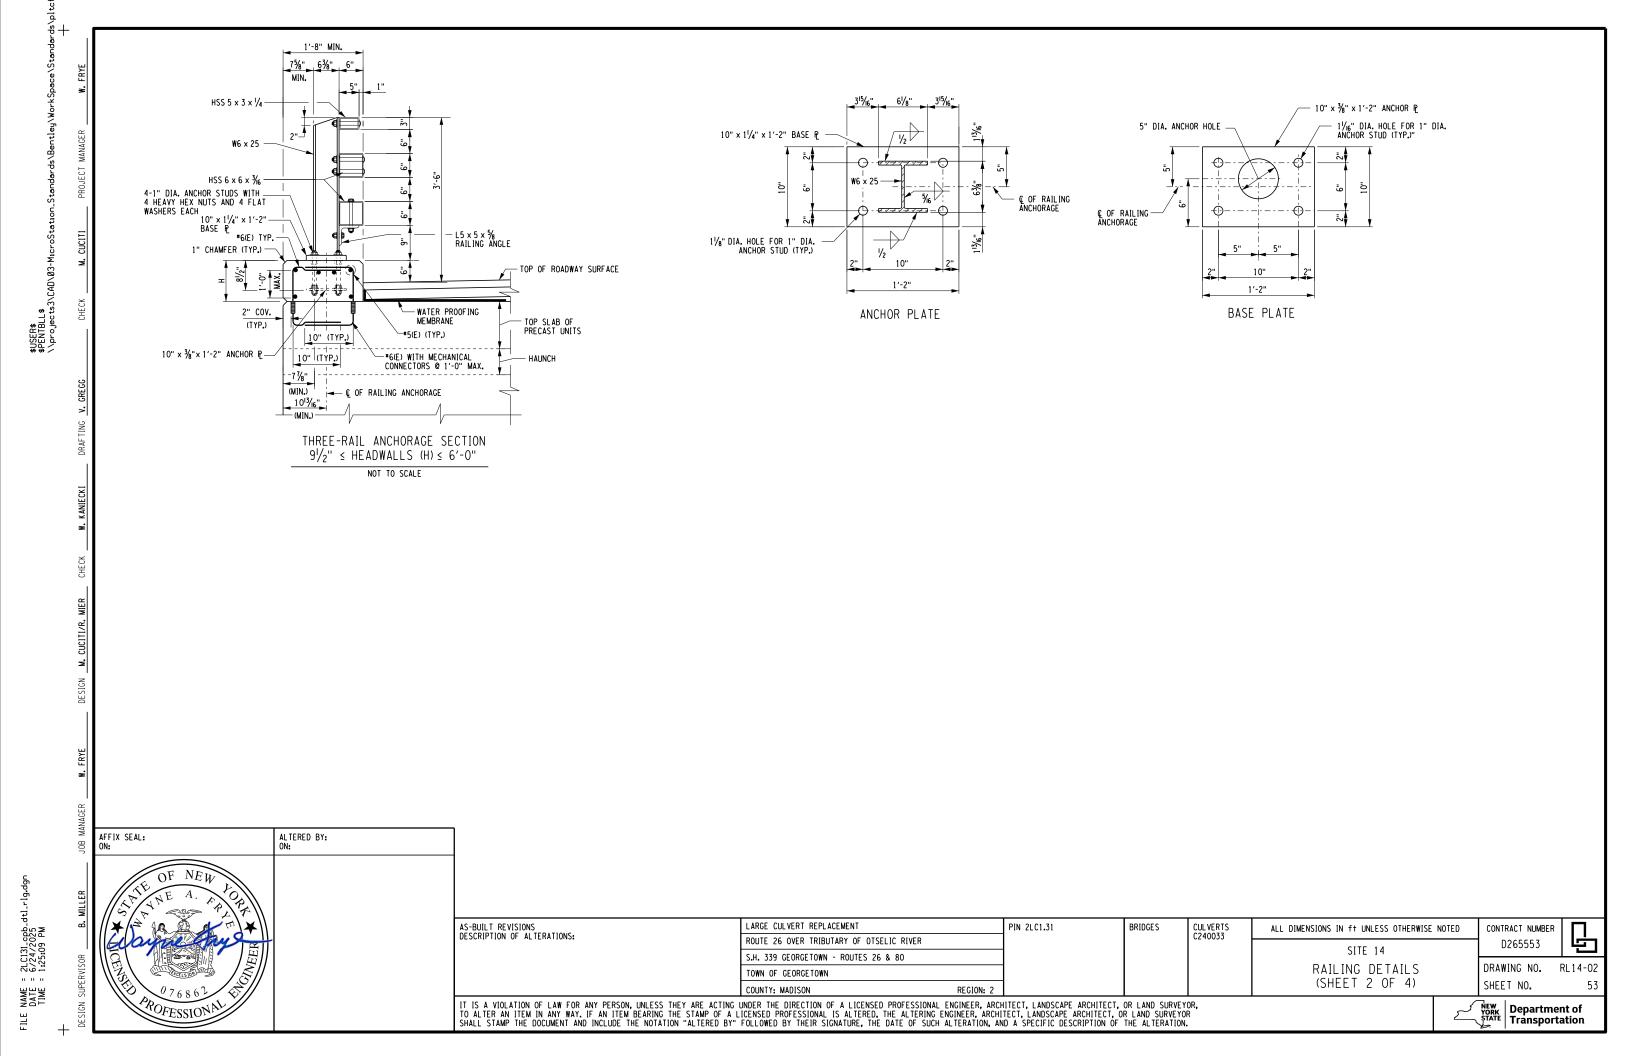


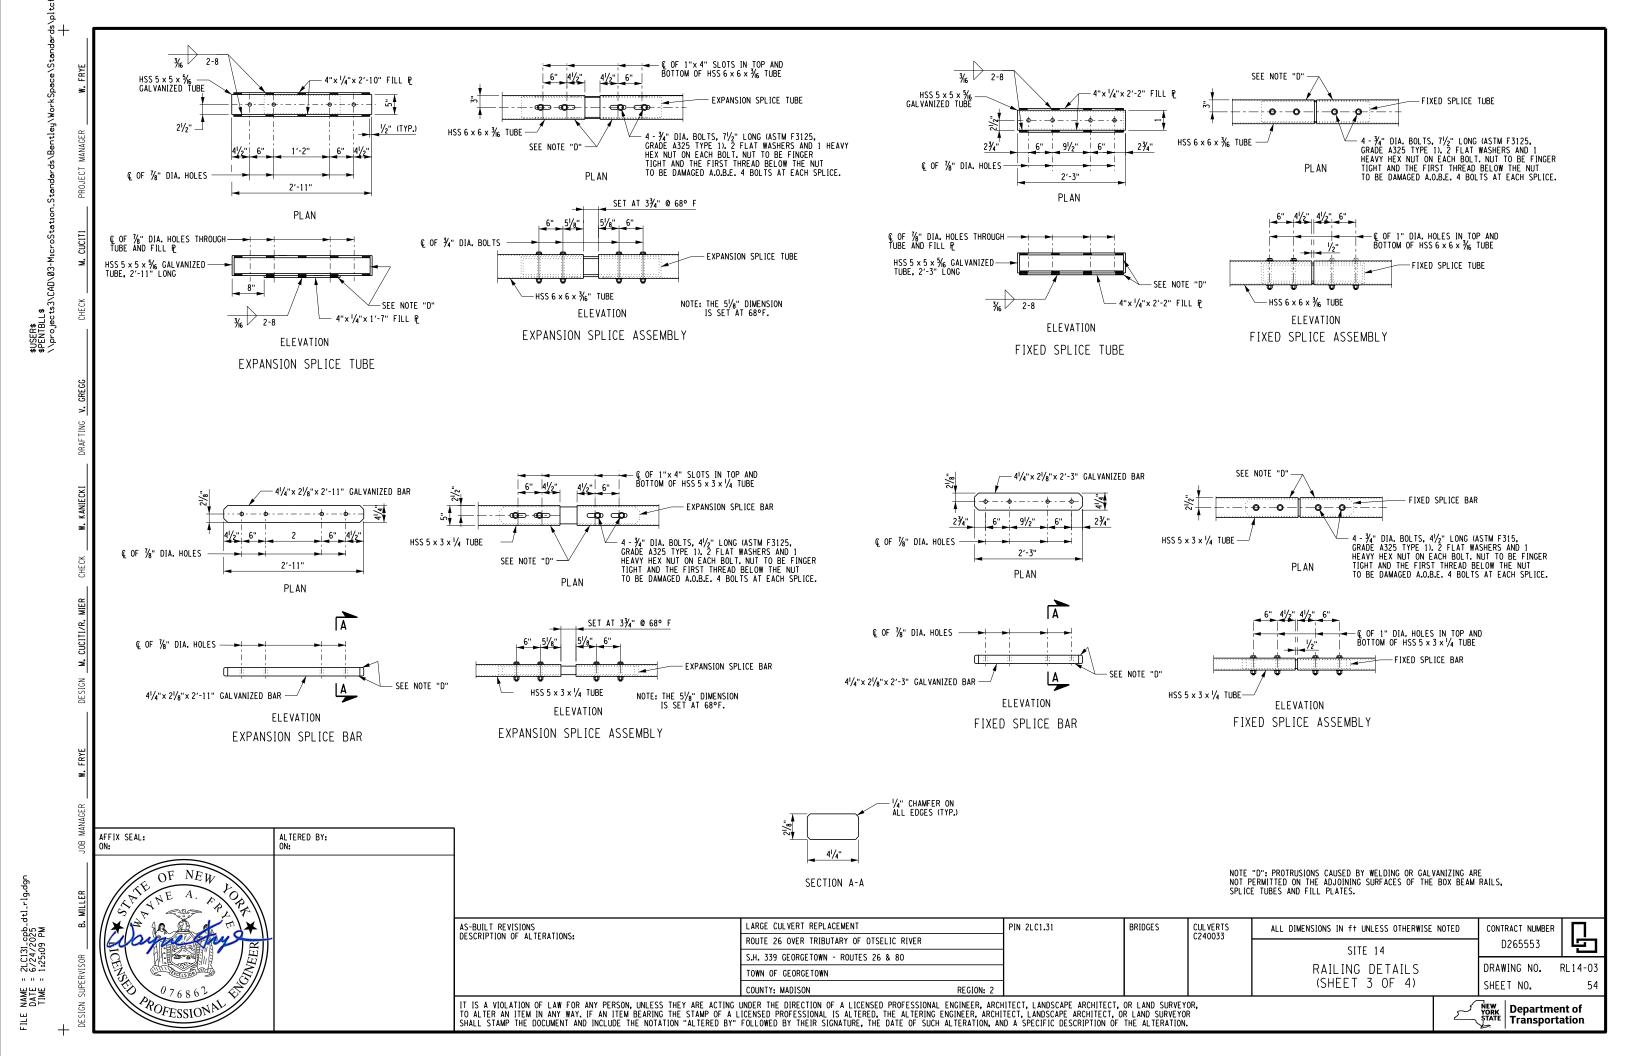


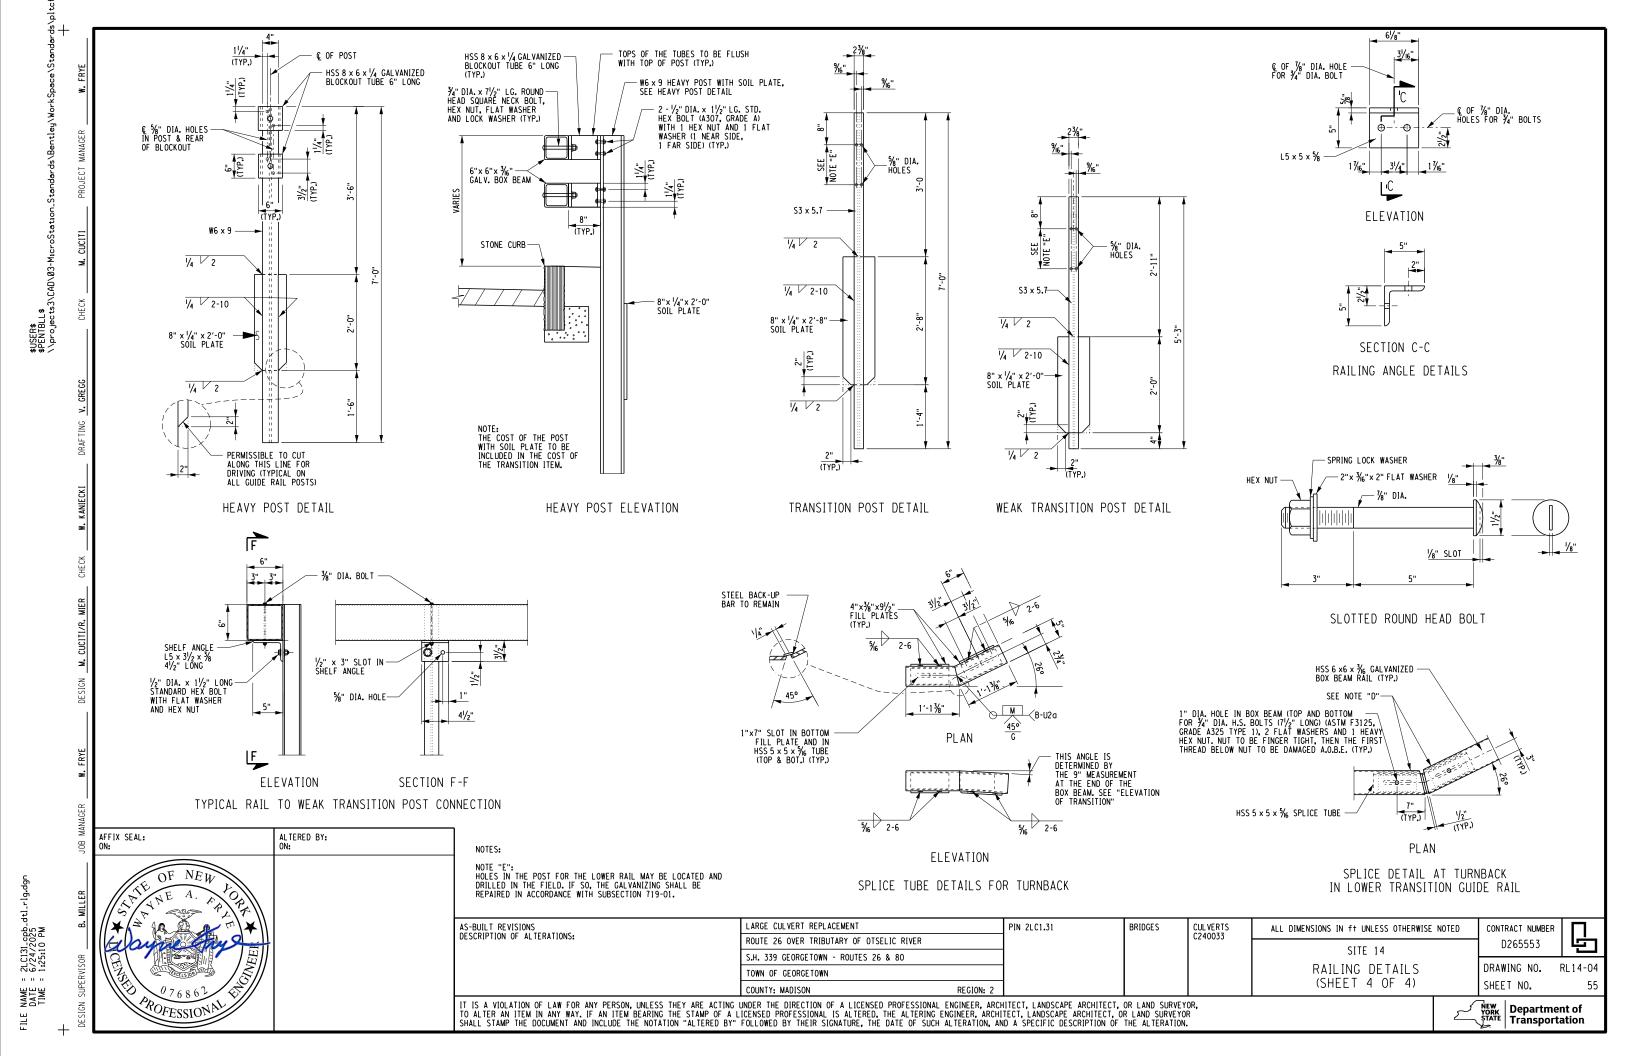


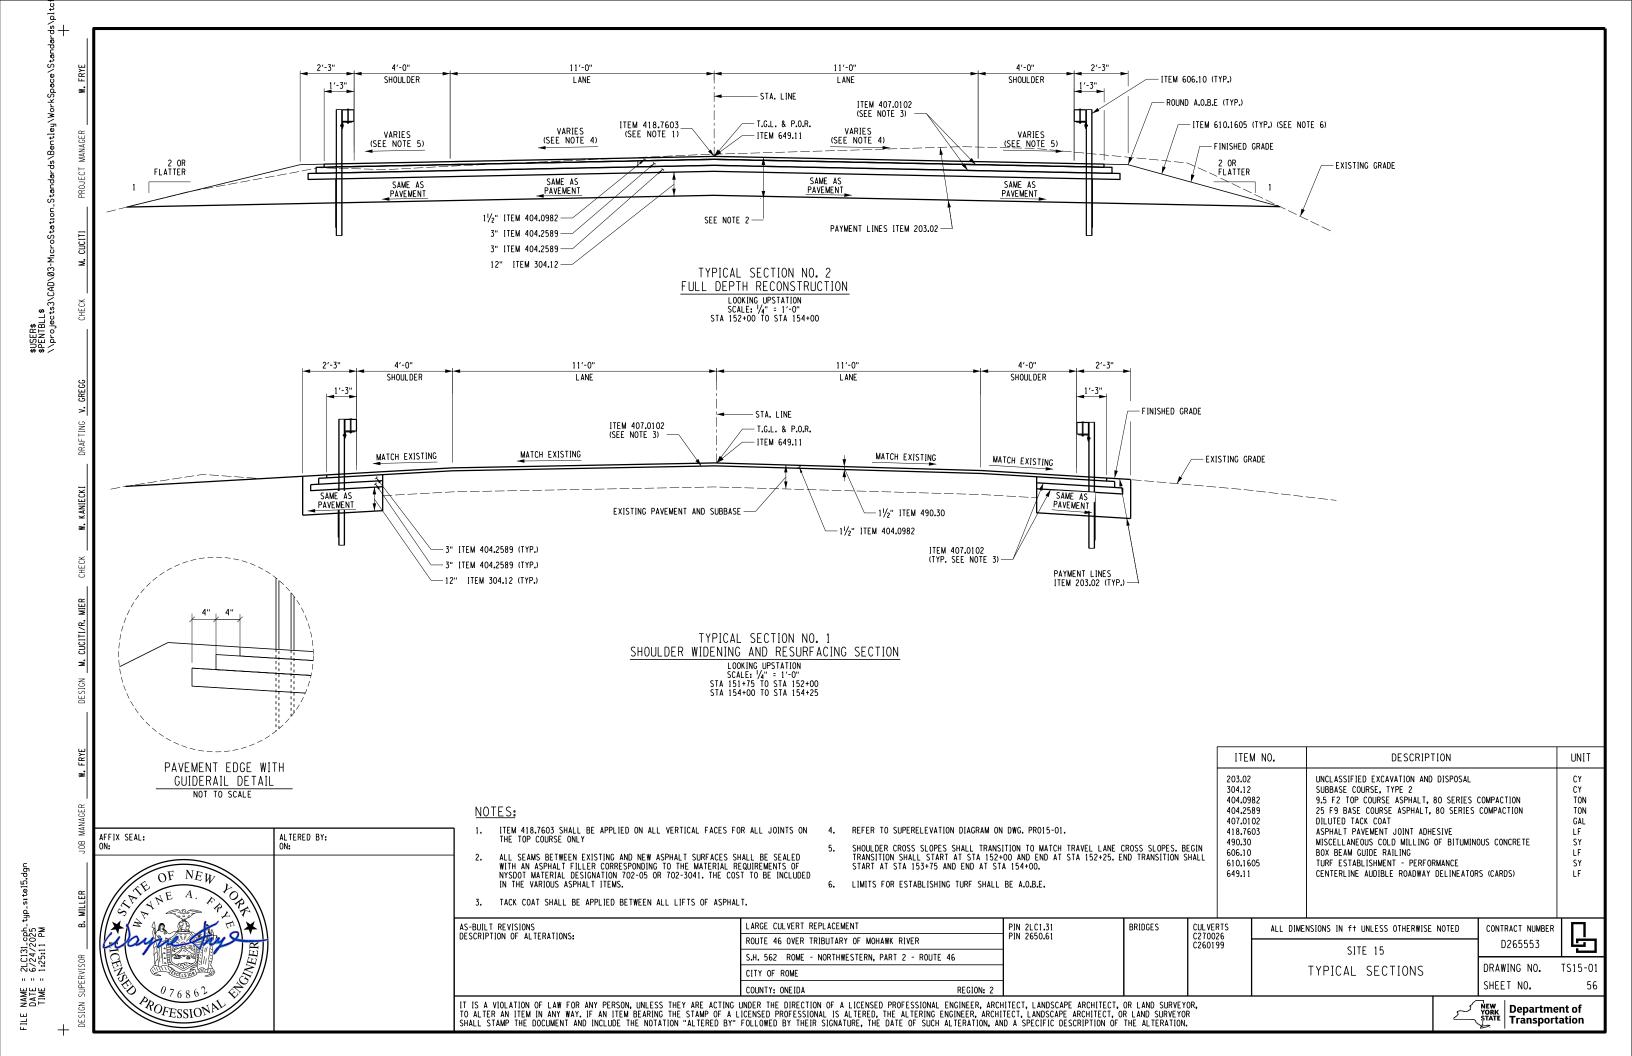


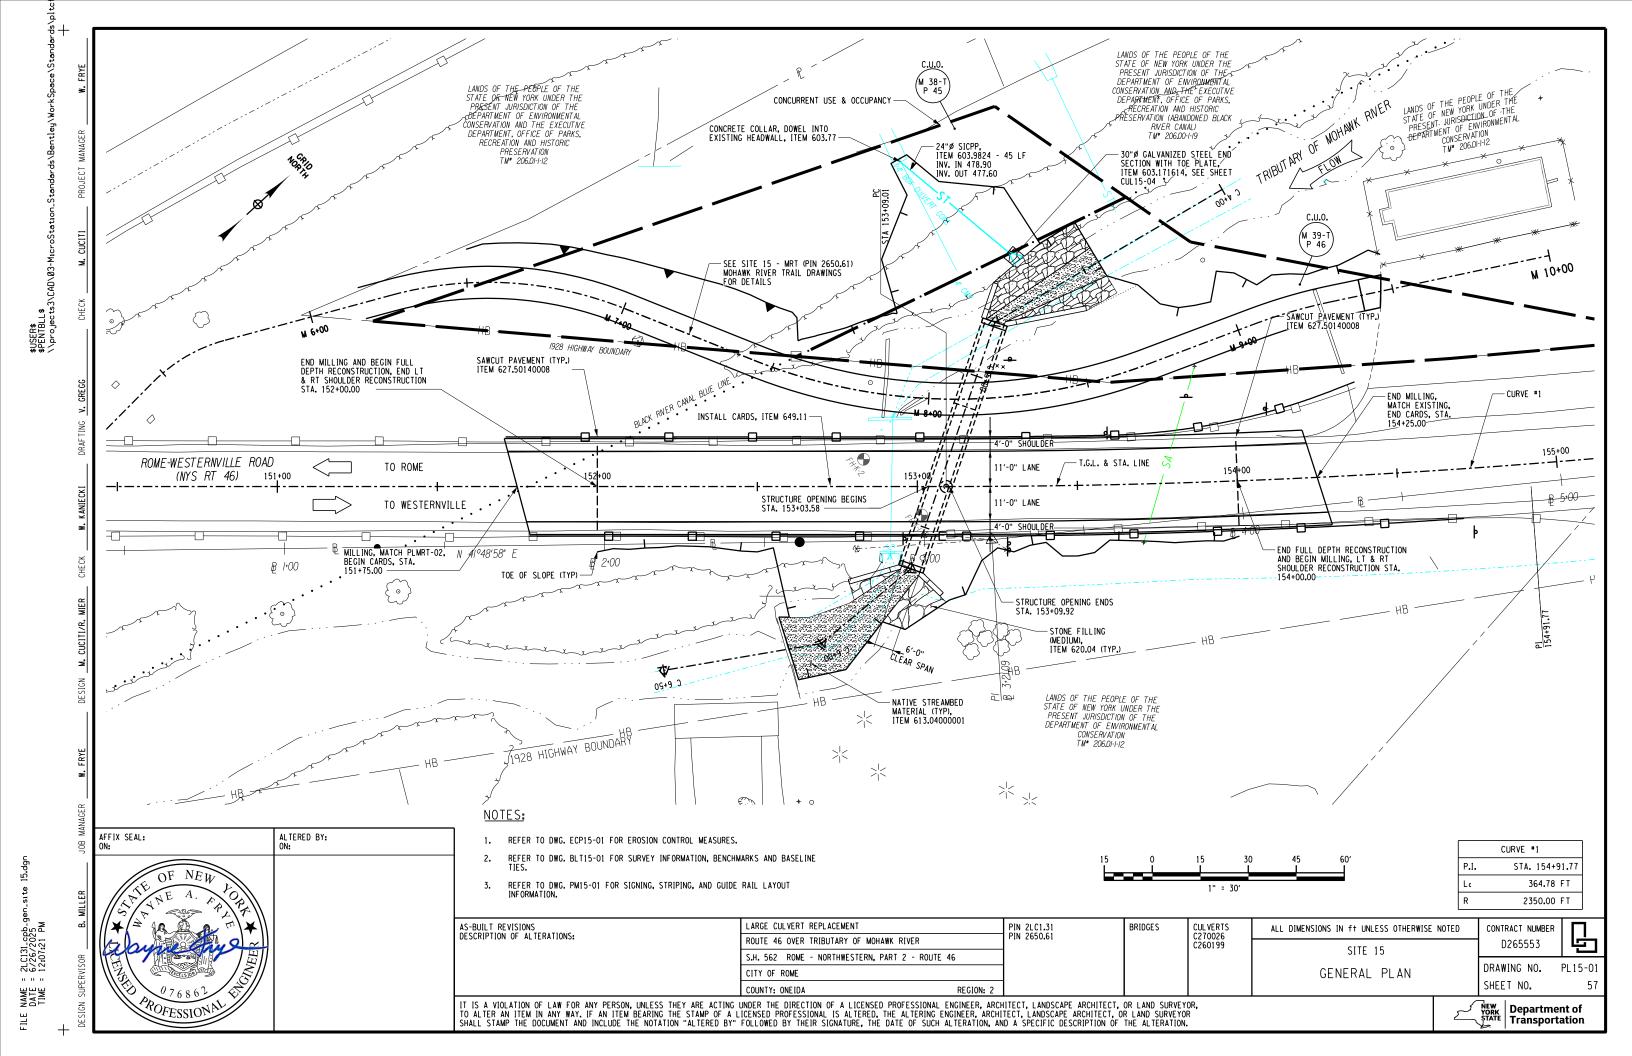


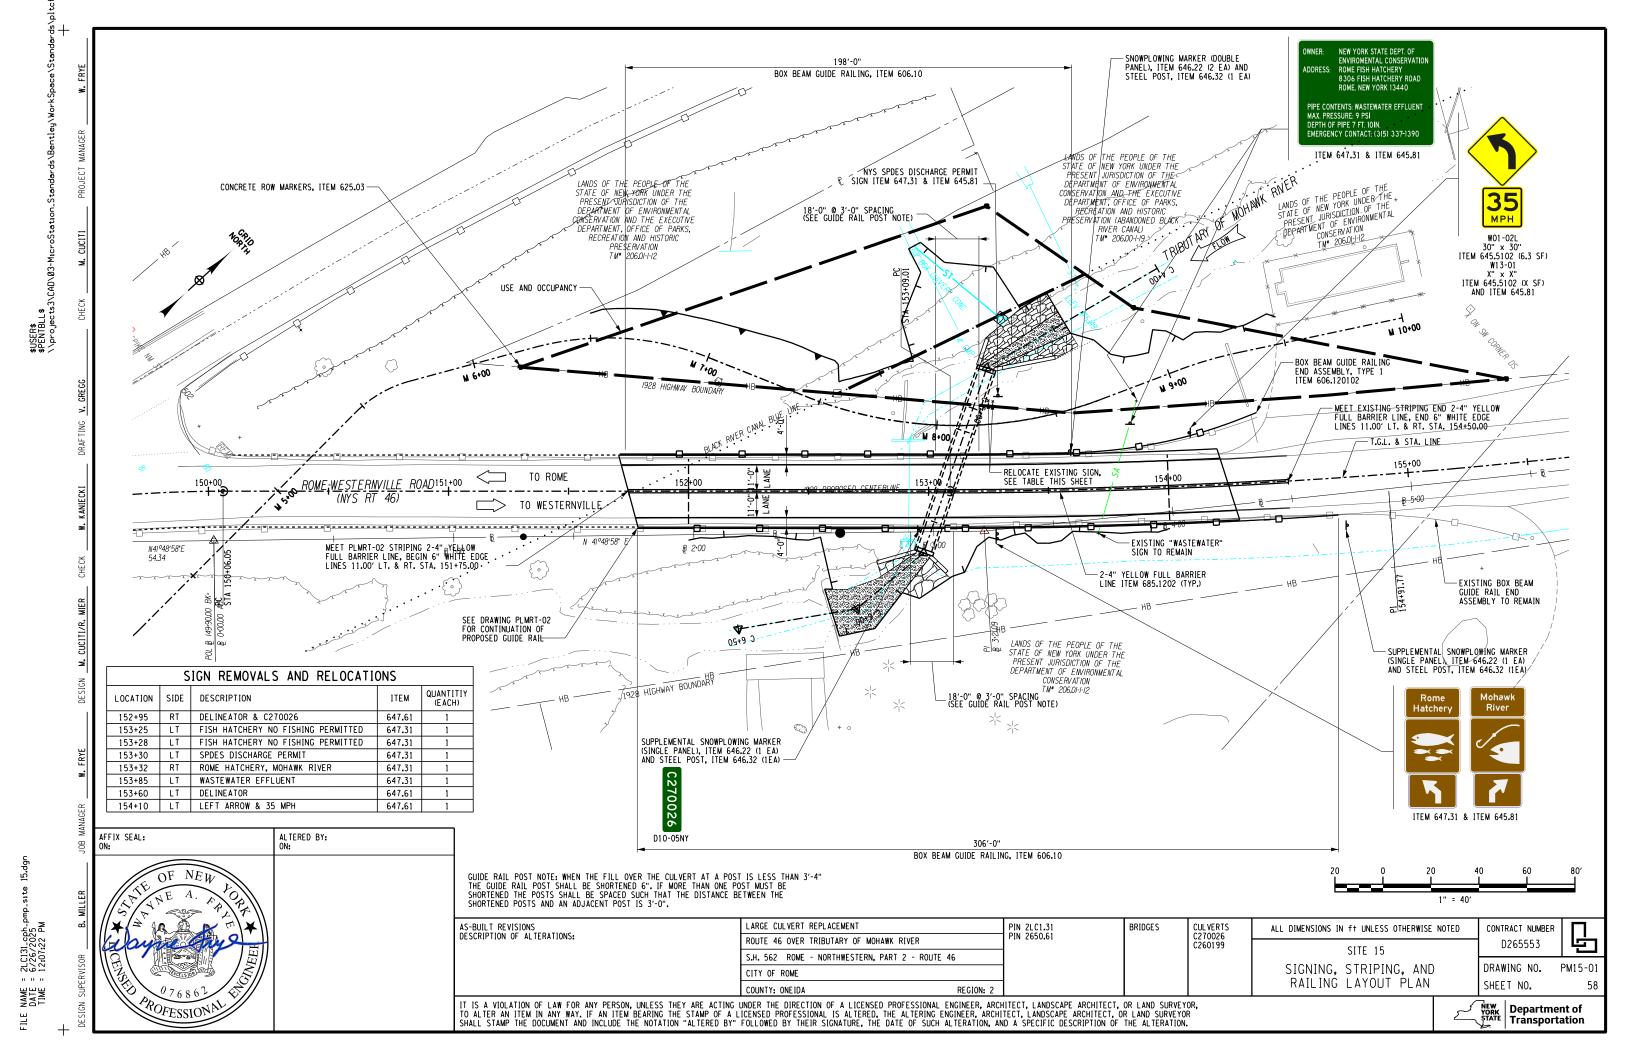


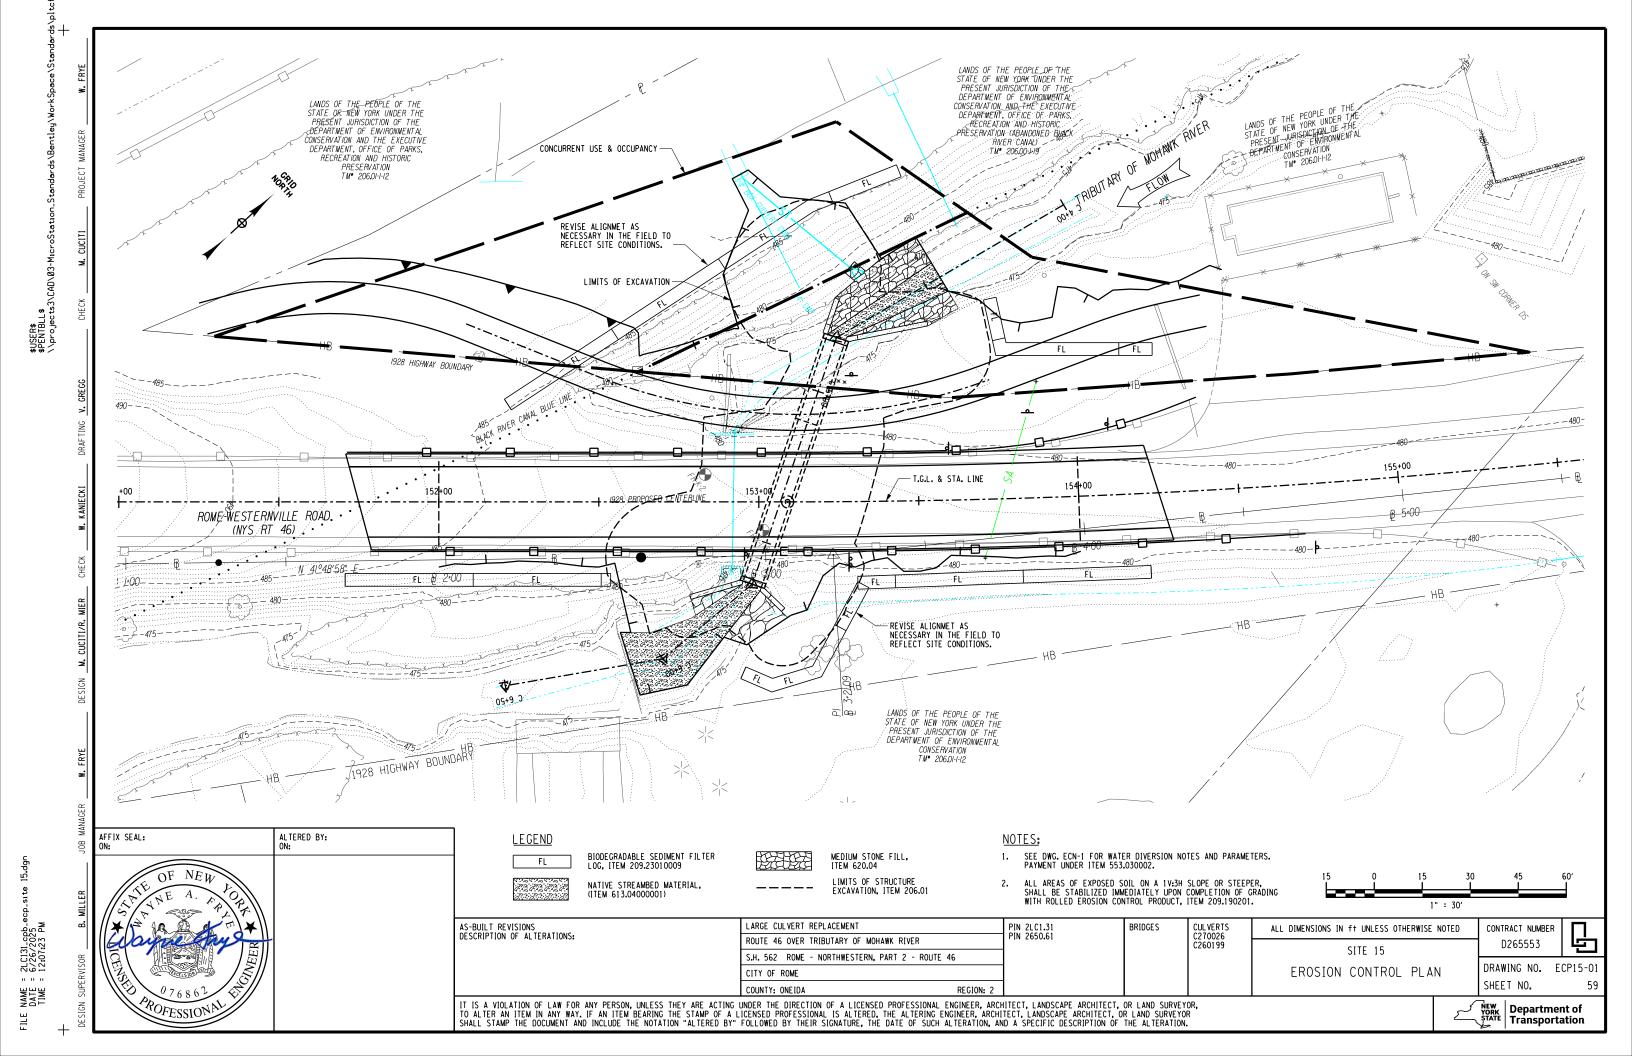












	INDEX					
SHEET NO.	DESCRIPTION	DRAWING NO.				
61	NOTES & INDEX	CUL 15-01				
62	CULVERT PLAN & ELEVATION	CUL 15-02				
63	TYPICAL CULVERT SECTION	CUL 15-03				
64	EXCAVATION PLAN STAGE 1	CUL 15-04				
65	EXCAVATION SECTIONS STAGE 1	CUL 15-05				
66	EXCAVATION PLAN STAGE 2	CUL 15-06				
67	EXCAVATION SECTIONS STAGE 2	CUL 15-07				
68	HEADWALL PLAN. ELEVATIONS AND DETAILS	CUL 15-08				

PRECAST CONCRETE BOX CULVERT NOTES:

ACTUAL WALL AND SLAB THICKNESSES, REINFORCEMENT SIZE AND SPACING TO BE DETERMINED BY FABRICATOR'S ENGINEER. IF THE ACTUAL TOP SLAB THICKNESS IS LESS THAN THE 1'-O" ASSUMED, THEN THE LOW BEAM ELEVATION SHALL BE HELD. IF THE ACTUAL TOP SLAB THICKNESS IS GREATER THAN 1'-O", CONTACT THE ENGINEER IN CHARGE.

THE LENGTH OF EACH STRUCTURE SEGMENT SHALL BE DETERMINED BY THE CONTRACTOR.

FOR MECHANICAL CONNECTORS IN TOP SLAB, SEE DWGS. CUL15-08.

ALL EXPOSED EDGES SHALL HAVE A CHAMFER OF 1".

REINFORCEMENT SHALL BE A.S.T.M. A615/M, GRADE 60 AND MEETING THE REQUIREMENTS OF SECTION 556 OF THE SPECIFICATIONS. THE MINIMUM CLEARANCE FOR REINFORCEMENT SHALL BE AS DETAILED ON THE PLANS. THE TOP MAT OF REINFORCEMENT SHALL BE EPOXY COATED.

THE ENTIRE TOP SLAB AND LEGS OF THE BOX UNIT SHALL BE COVERED WITH SHEET APPLIED WATERPROOFING MEMBRANE. STRIPS OF WATERPROOFING MEMBRANE SHALL BE PLACED OVER THE JOINTS BETWEEN THE BOX AND END

WHERE EPOXY THREADED INSERTS ARE SHOWN ANY NON-CORROSIVE MECHANICAL CONNECTOR MEETING STANDARD SPECIFICATION SECTION 709-10 MAY BE USED AS AN ALTERNATIVE.

DOWEL BARS USED TO ATTACH THE CUT-OFF WALL TO THE BOX CULVERT SHALL BE DRILLED AND GROUTED PER THE REQUIREMENTS OF STANDARD SPECIFICATION SECTION 586 EXCEPT THE GROUT SHALL MEET THE REQUIREMENTS OF \$701-06 (PULL-OUT TEST NOT REQUIRED). THE KEYWAY SHALL BE GROUTED WITH THE SAME MATERIAL AS THE DOWELS. PLACE A BEAD OF CAULK, CLOSED CELL FOAM OR OTHER SUITABLE MATERIAL ON BOTH SIDES OF THE

TOP OF BOX UNITS SHALL BE CROWNED AT 1.0% FROM @ BOX TO DRAIN.

PRECAST CONCRETE BOX UNIT REFORCEMENT COVER REQUIREMENTS:

- TOP OF PRECAST BOX UNIT 2"
- ALL OTHER PRECAST BOX UNIT FACES 1"

FOR DETAILS SEE SHEETS MSD-01 THROUGH MSD-03.

HYDRAULIC NOTES:

THE COST OF DEWATERING THE ENTIRE EXCAVATION, REGARDLESS OF THE SOURCE OF WATER, SHALL BE INCLUDED IN THE UNIT PRICE BID FOR THE EXCAVATION ITEM(S).

ORDINARY HIGH-WATER IS ESTIMATED TO BE 474.45. ORDINARY HIGH WATER IS ASSUMED TO BE THE WATER SURFACE ELEVATION FOR THE MAXIMUM PROBABLE FISH HATCHERY DISCHARGE.

ORDINARY WATER IS ESTIMATED TO BE 474.20. ORDINARY HIGH WATER IS DEFINED AS THE HICHEST SURFACE WATER ELEVATION LIKELY TO BE ENCOUNTERED DURING ONE CONSTRUCTION SEASON (EXCLUDING MAJOR FLOODS).

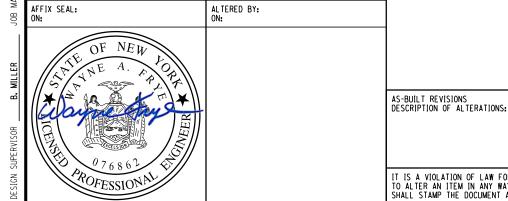
LOW WATER IS ESTIMATED TO BE 473.00 LOW WATER IS DEFINED AS THE NORMAL LOW WATER ELEVATION PREVALENT DURING ONE CONSTRUCTION SEASON FOR MORE THAN 25% OF THE TIME. IT IS AN OBSERVED ELEVATION RATHER THAN A COMPUTED ONE.

THE MAXIMUM DISCHARGE OF THE FISH HATCHERY IS 2.82 FT/S. THE TYPICAL DISCHARGE VELOCITY IS 2.19 FT/S

FOUNDATION NOTES:

UNLESS OTHERWISE SHOWN ON THE CONTRACT PLANS, REMOVE EXISTING SUBSTRUCTURES AS FOLLOWS:

- 1. COMPLETELY REMOVE THE PORTION OF THE EXISTING SUBSTRUCTURE WITHIN A LATERAL LIMIT OF 3 FEET
- 2. REMOVE THE PORTION OF THE EXISTING SUBSTRUCTURE THAT IS OUTSIDE OF THIS LATERAL LIMIT AS FOLLOWS:
 - A. EXISTING SUBSTRUCTURE LOCATED UNDER ROADWAY REMOVE TO 2.0 FEET BELOW SUBGRADE
 - B. EXISTING SUBSTRUCTURE LOCATED UNDER APPROACH EMBANKMENT END SLOPE REMOVE TO ELEVATION WHERE IT INTERSECTS THE BOTTOM OF THE STONE FILLING.
 - C. EXISTING SUBSTRUCTURE AT ALL OTHER LOCATIONS REMOVE TO 1.0 FOOT BELOW FINISHED GRADE.



ARGE CULVERT REPLACEMENT ROUTE 46 OVER TRIBUTARY OF MOHAWK RIVER S.H. 562 ROME - NORTHWESTERN, PART 2 - ROUTE 46 CITY OF ROME

PIN 2LC1.31 PIN 2650.61 BRIDGES

CUL VERTS C260199

ALL DIMENSIONS IN ft UNLESS OTHERWISE NOTED SITE 15 NOTES & INDEX

CONTRACT NUMBER D265553

DRAWING NO. CUL 15-01 SHEET NO.

IT IS A VIOLATION OF LAW FOR ANY PERSON, UNLESS THEY ARE ACTING UNDER THE DIRECTION OF A LICENSED PROFESSIONAL ENGINEER, ARCHITECT, LANDSCAPE ARCHITECT, OR LAND SURVEYOR, TO ALTER AN ITEM IN ANY WAY. IF AN ITEM BEARING THE STAMP OF A LICENSED PROFESSIONAL IS ALTERED, THE ALTERING ENGINEER, ARCHITECT, LANDSCAPE ARCHITECT, OR LAND SURVEYOR SHALL STAMP THE DOCUMENT AND INCLUDE THE NOTATION "ALTERED BY" FOLLOWED BY THEIR SIGNATURE, THE DATE OF SUCH ALTERATION, AND A SPECIFIC DESCRIPTION OF THE ALTERATION.



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LOAD RATING (LFD)				
INVENTORY HS TONS				
OPERATING	HS	TONS		
LRFR RATING FACTORS				
INVENTORY	HL-93			
OPERATING	HL-93			


THE LOAD RATING TABLE SHALL BE FILLED IN BY THE EIC FROM INFORMATION RECEIVED FROM THE CONTRACTOR AFTER REVIEW AND APPROVAL BY THE DCES. THE SUBMITTED LOAD RATING INFORMATION SHALL BE IN ACCORDANCE WITH THE AASHTO "MANUAL FOR BRIDGE EVALUATION" WITH ALL INTERIM PROVISIONS IN EFFECT. THE CONTRACTOR SHALL PROVIDE LOAD RATINGS IN BOTH THE LOAD FACTOR RATING (LFD) METHOD AND THE LOAD AND RESISTANCE FACTOR RATING (LRFR) METHOD. THE CONTRACTOR SHALL ALSO PROVIDE ALL LOAD RATING COMPUTATIONS TO THE REGIONAL STRUCTURES ENGINEER.


BOX CULVERT DE	SIGN DATA
CLEAR SPAN, ft.	6.0
STRUCTURE RISE, ft.	6.0
* MIN. FILL HEIGHT, ft.	1.3
* MAX. FILL HEIGHT, ft.	6.2
SKEW ANGLE 1 TO © OF ROADWAY, DEG.	18° 51′ 00"
LIVE LOAD	HL93 W/LRFR INV. FACTOR ≥ 1.2
RAILING / BARRIER TEST LEVEL	N/A


*BASED ON ASSUMED TOP SLAB THICKNESS OF 1 FT. FABRICATOR SHALL ADJUST BASED ON ACTUAL TOP SLAB THICKNESS, MEASURED FROM THE TOP OF THE TOP SLAB TO THE TOP OF THE PAVEMENT. MAXIMUM FILL HEIGHT IS BASED ON STAGE 2 DETOUR ROADWAY. MAXIMUM FILL HEIGHT ON ROUTE 46 IS 3.9 FT.


GEOTECHNICAL WINGWALL DESIGN DATA						
FRICTION ANGLE OF SOIL RETAINED BY THE WALL (DEGREES)	FRICTION ANGLE OF FOUNDATION SOIL (DEGREES)	TOTAL SOIL UNIT WEIGHT (Ib/ft³)	MAXIMUM SERVICE LIMIT STATE BEARING RESISTANCE (ID/ft²)	NOMINAL COEFFICIENT OF FRICTION FOR SLIDING	STRENGTH LIMIT STATE RESISTANCE FACTOR FOR SLIDING	STRENGTH LIMIT STATE RESISTANCE FACTOR FOR BEARING
34	30	120	3.5	0.46	0.90	0.45

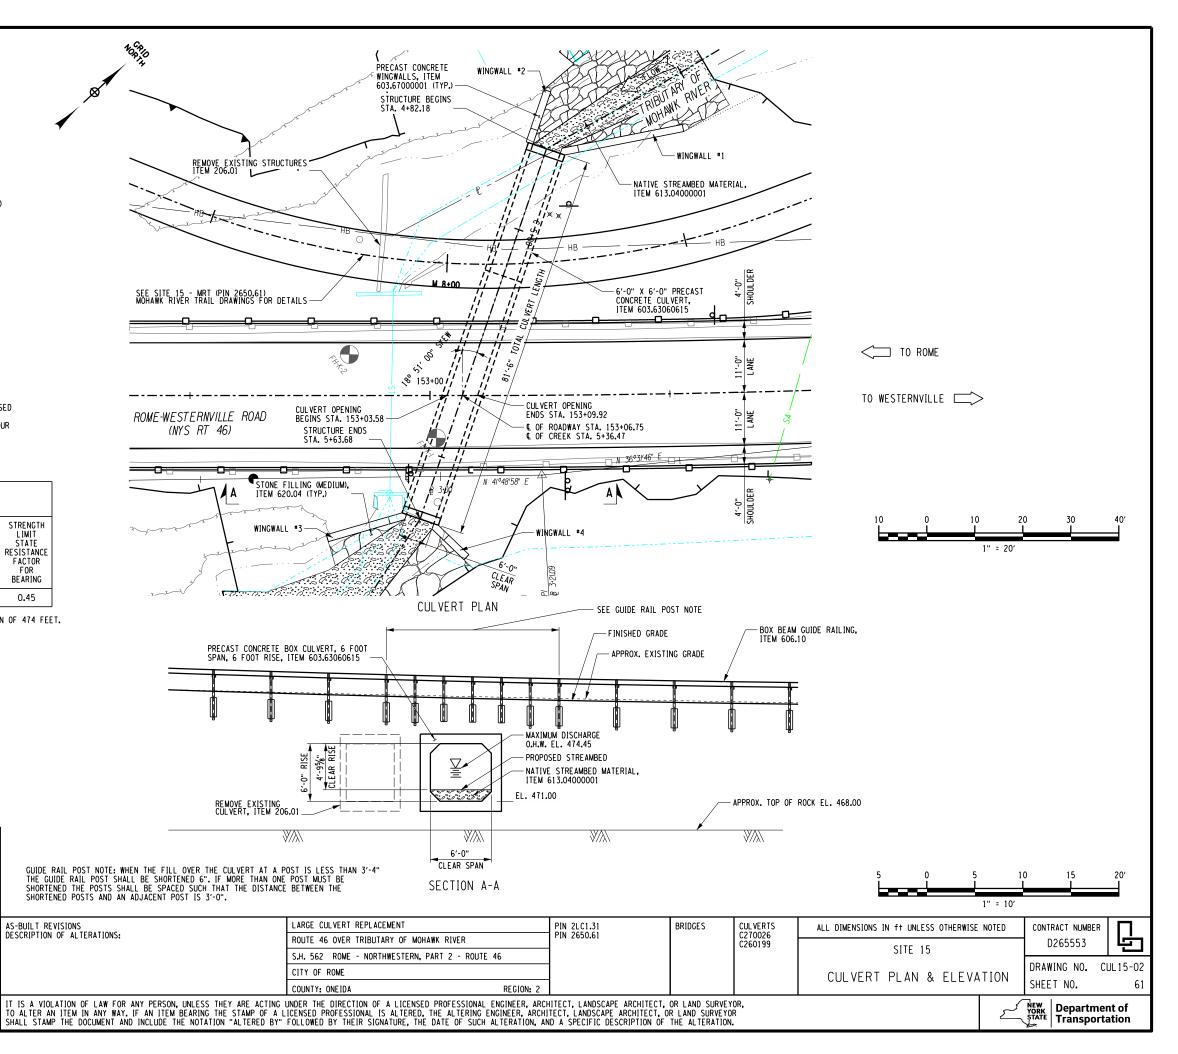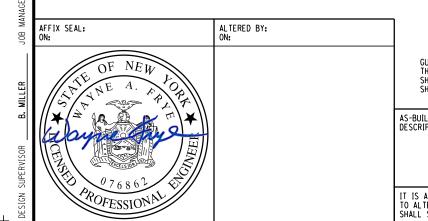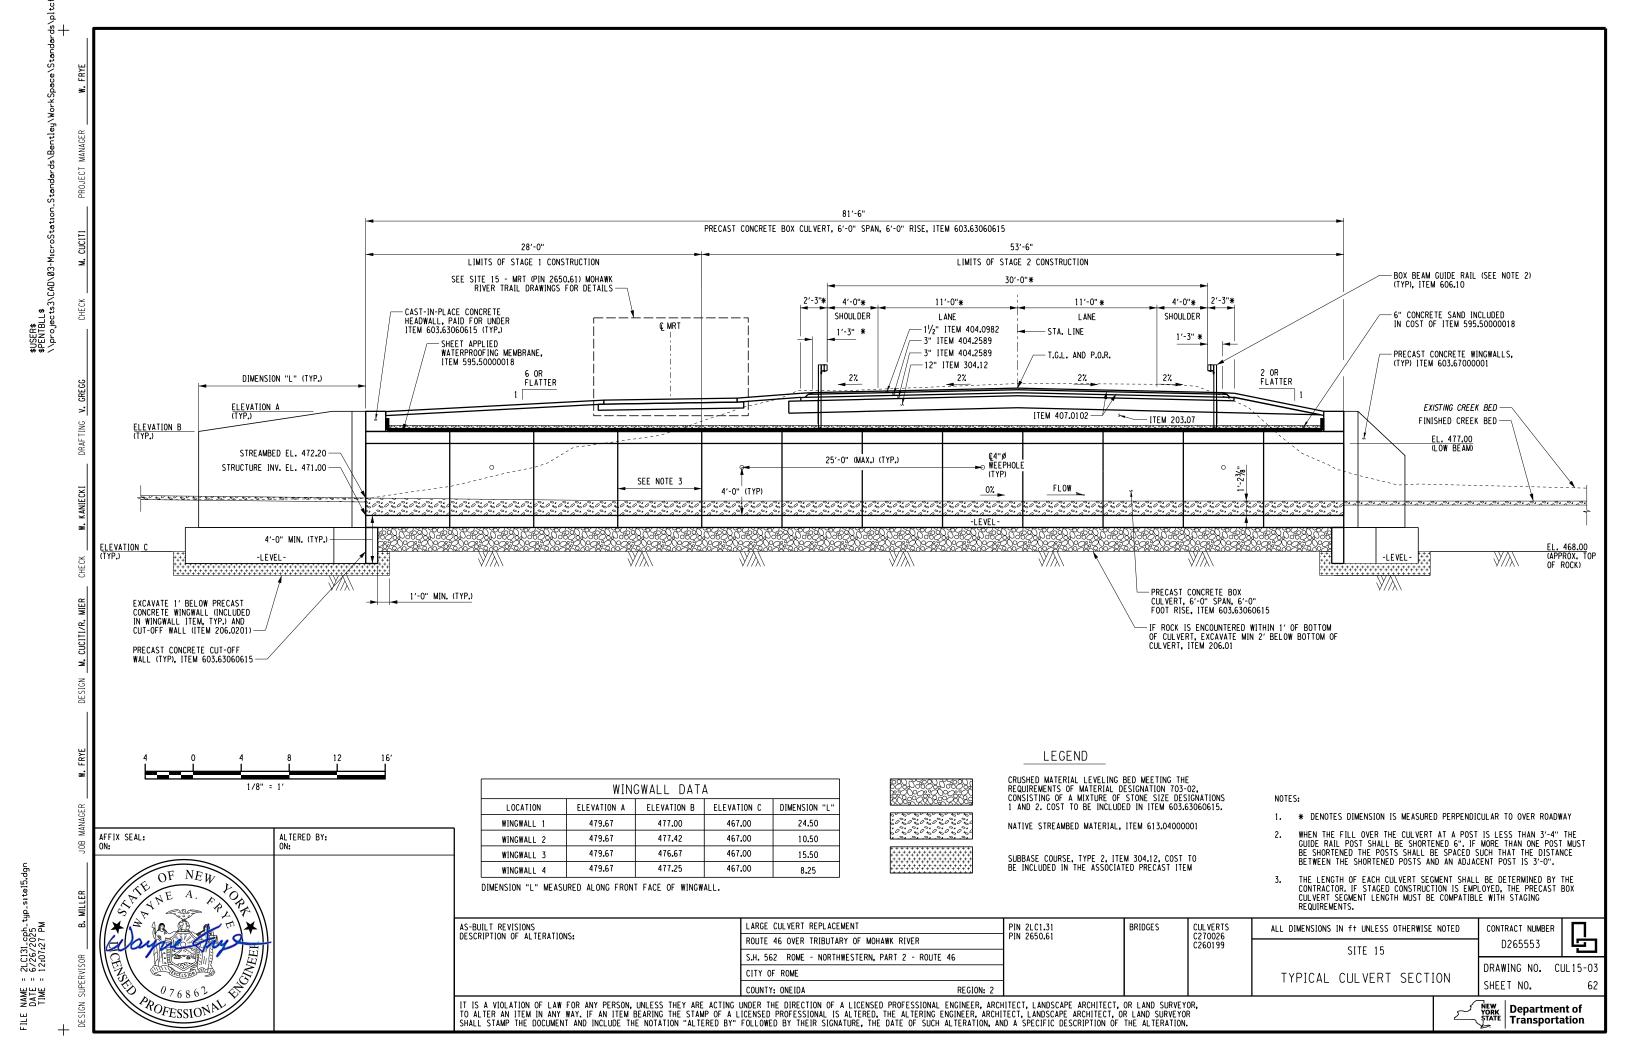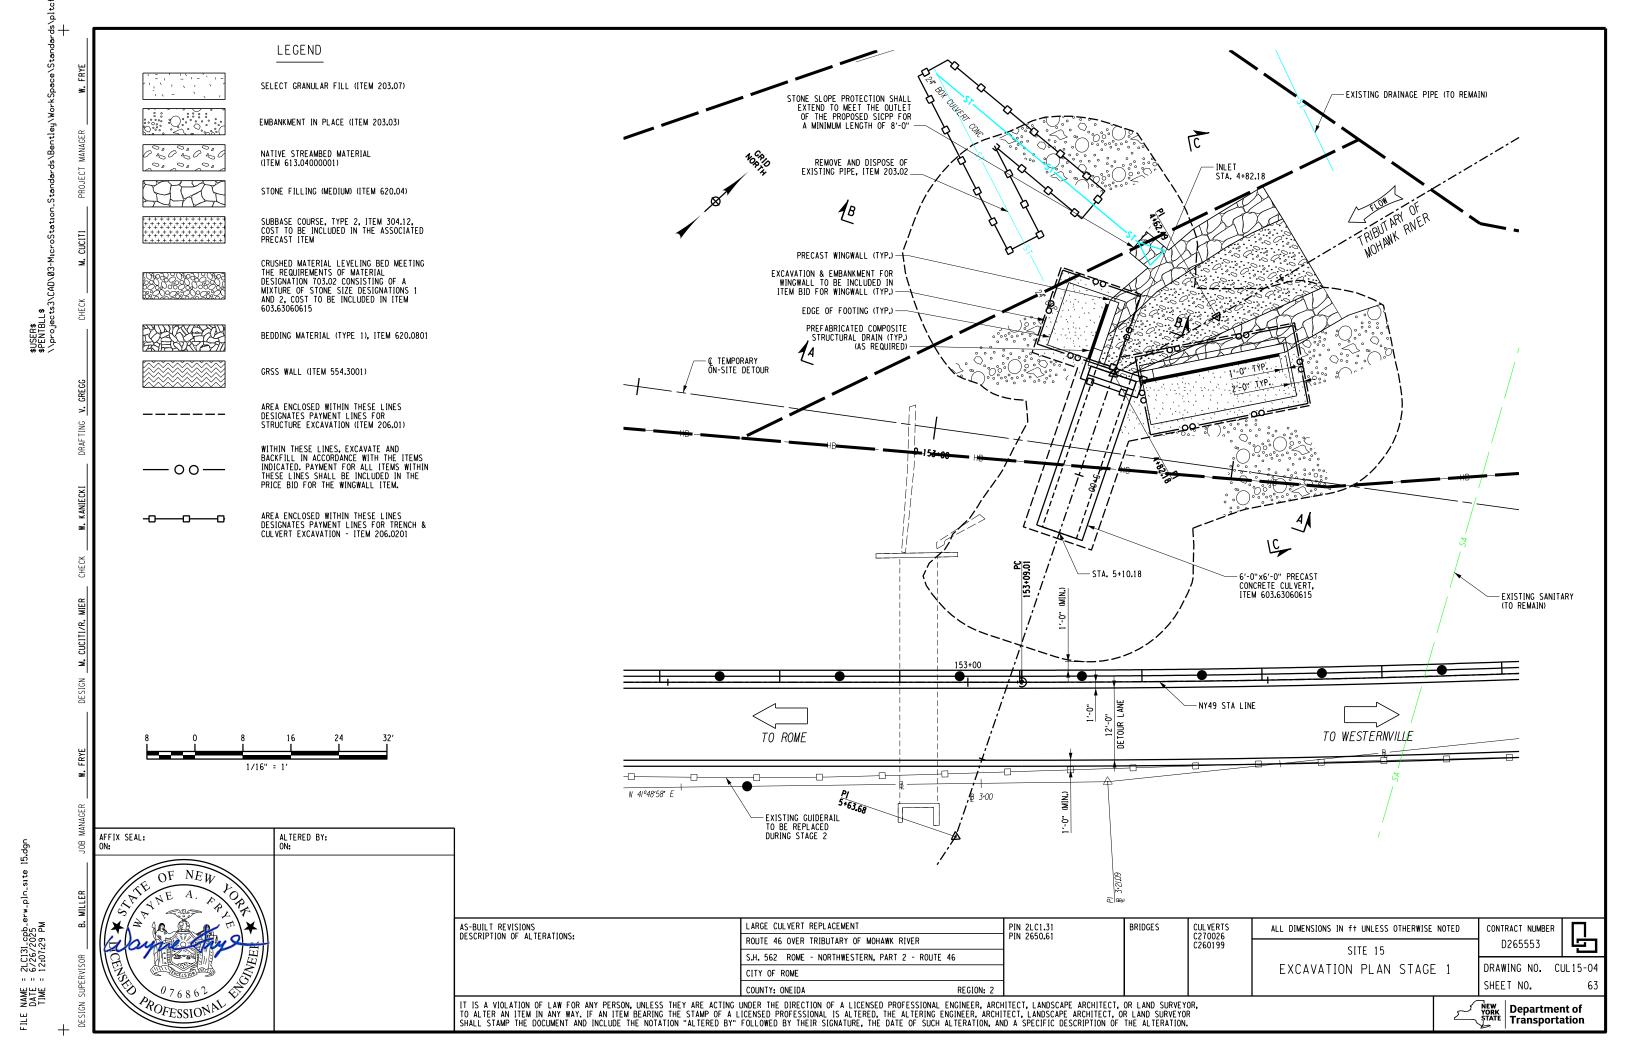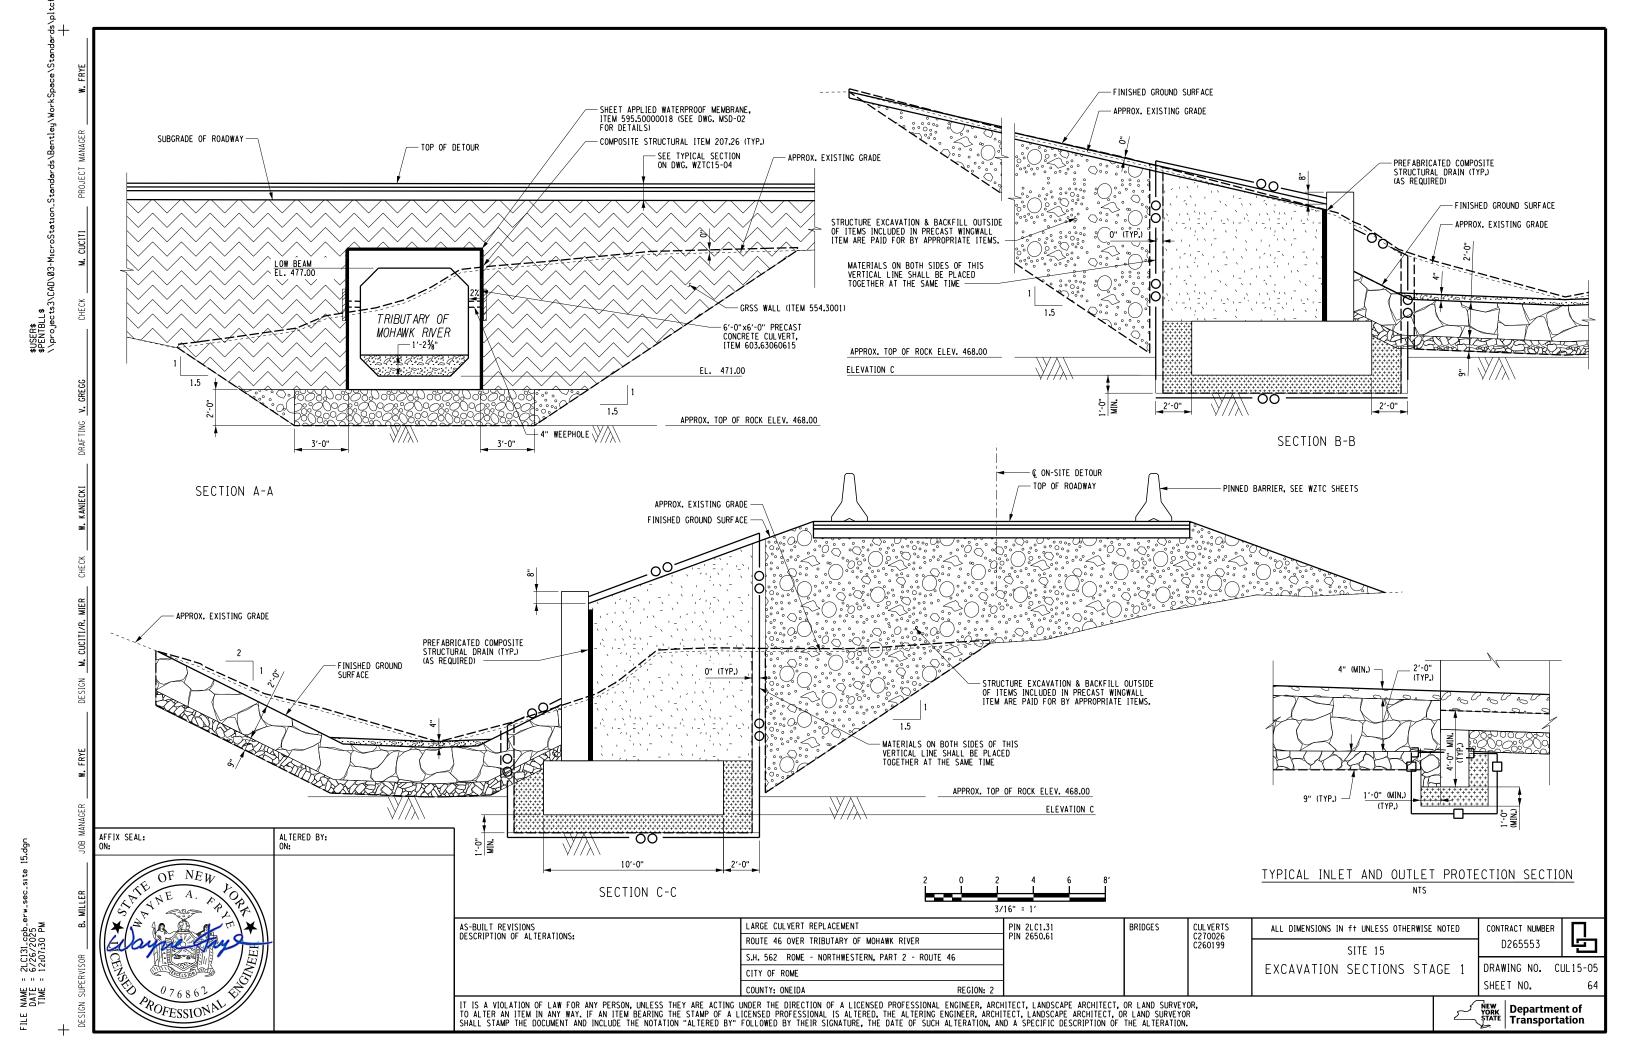
- 1. FOR THE SLIDING AND ECCENTRICITY ANALYSES, ASSUME A GROUND WATER ELEVATION OF 474 FEET.
- 2. FOR THE BEARING ANALYSES, ASSUME A GROUNDWATER ELEVATION OF 468 FEET.
- 3. USE SUBMERGED UNIT WEIGHTS BELOW THE GROUNDWATER ELEVATIONS PROVIDED.
- 4. ASSUME A SURCHARGE LOAD OF 250 POUNDS PER SQUARE FOOT.

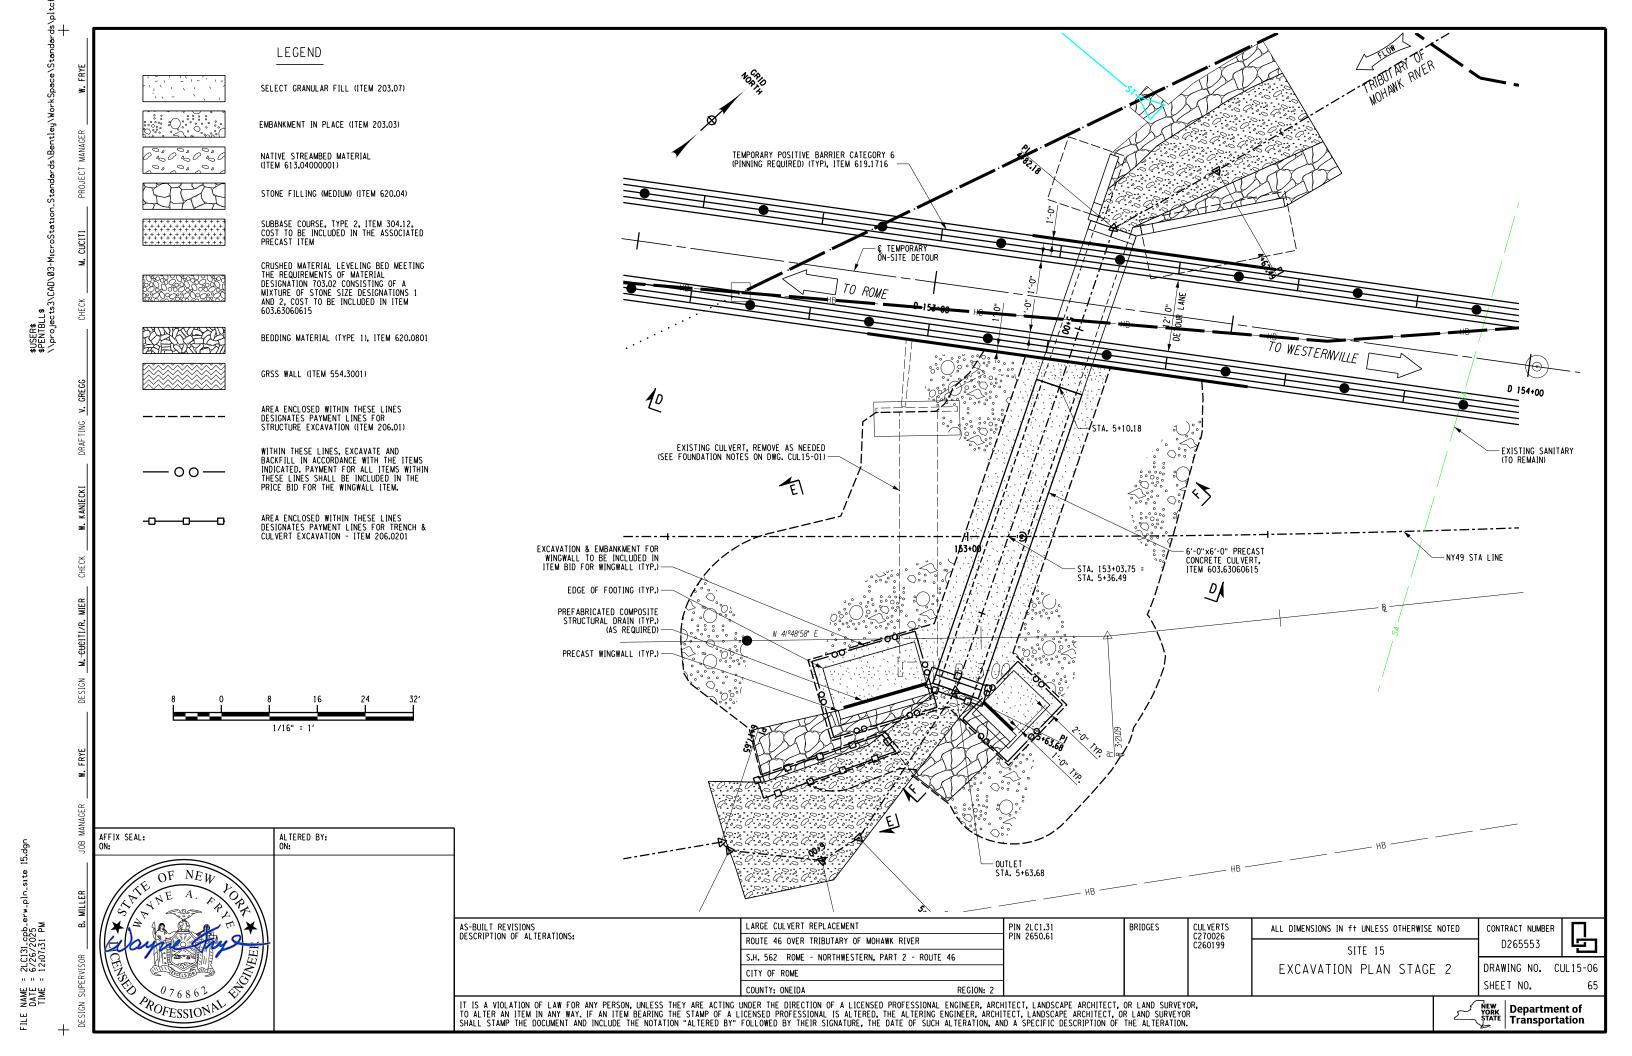


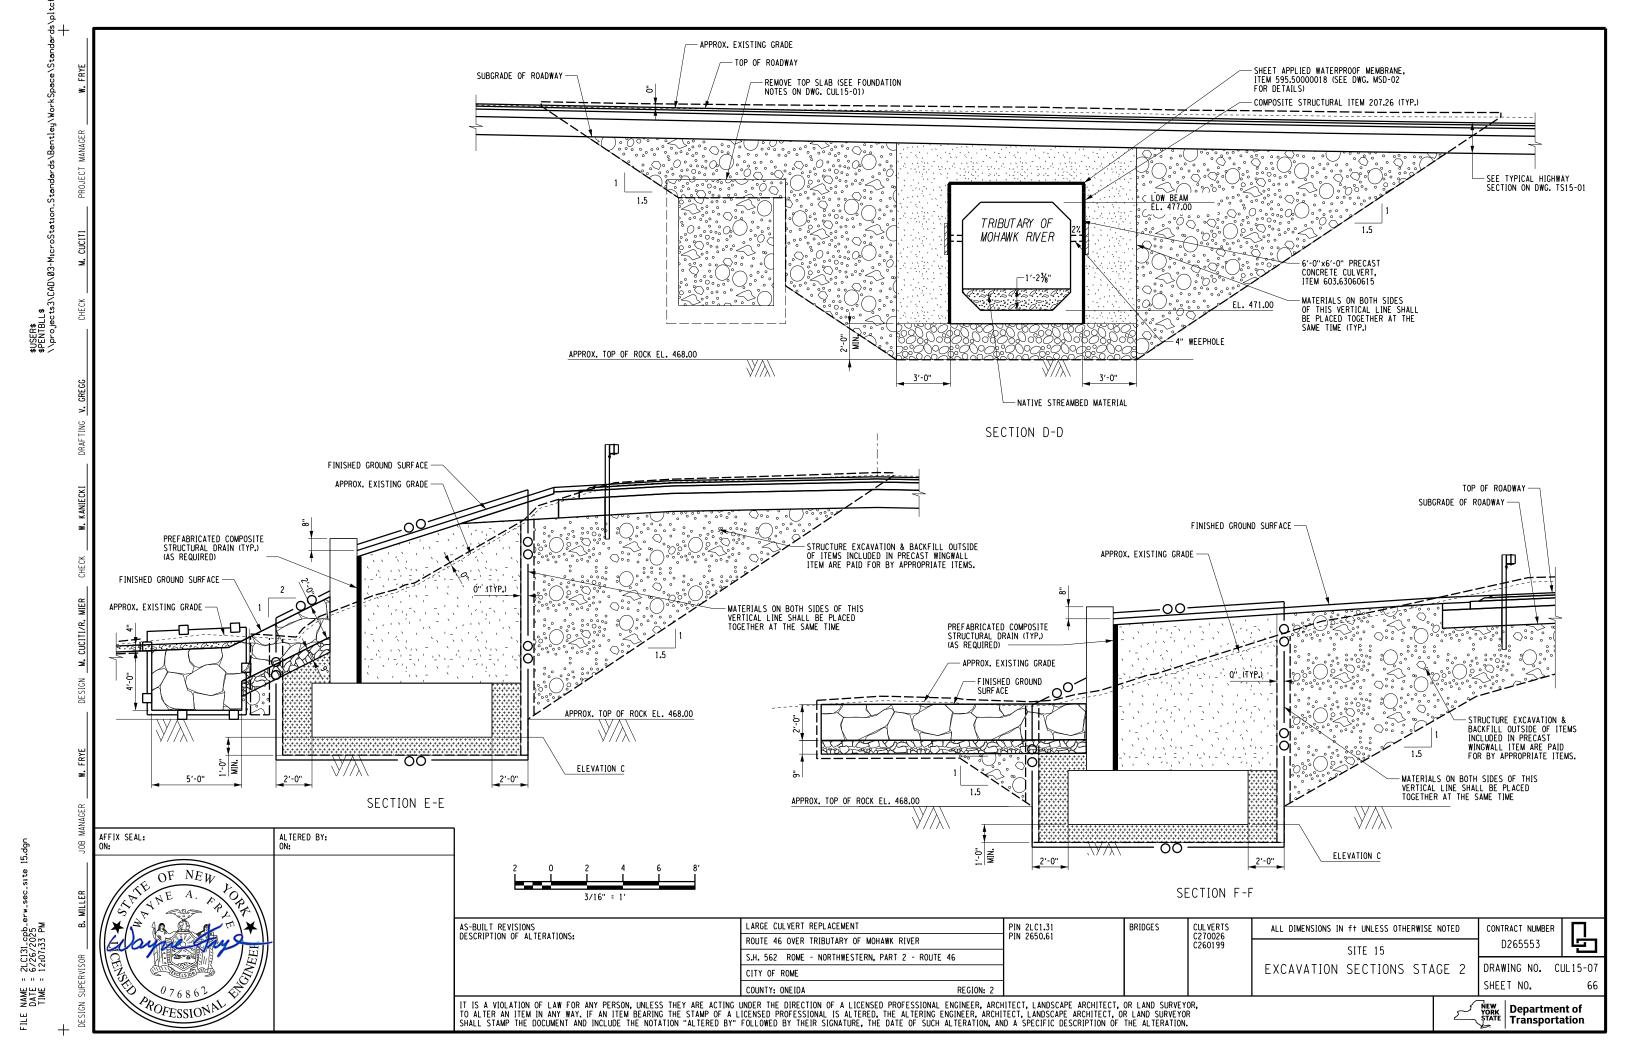


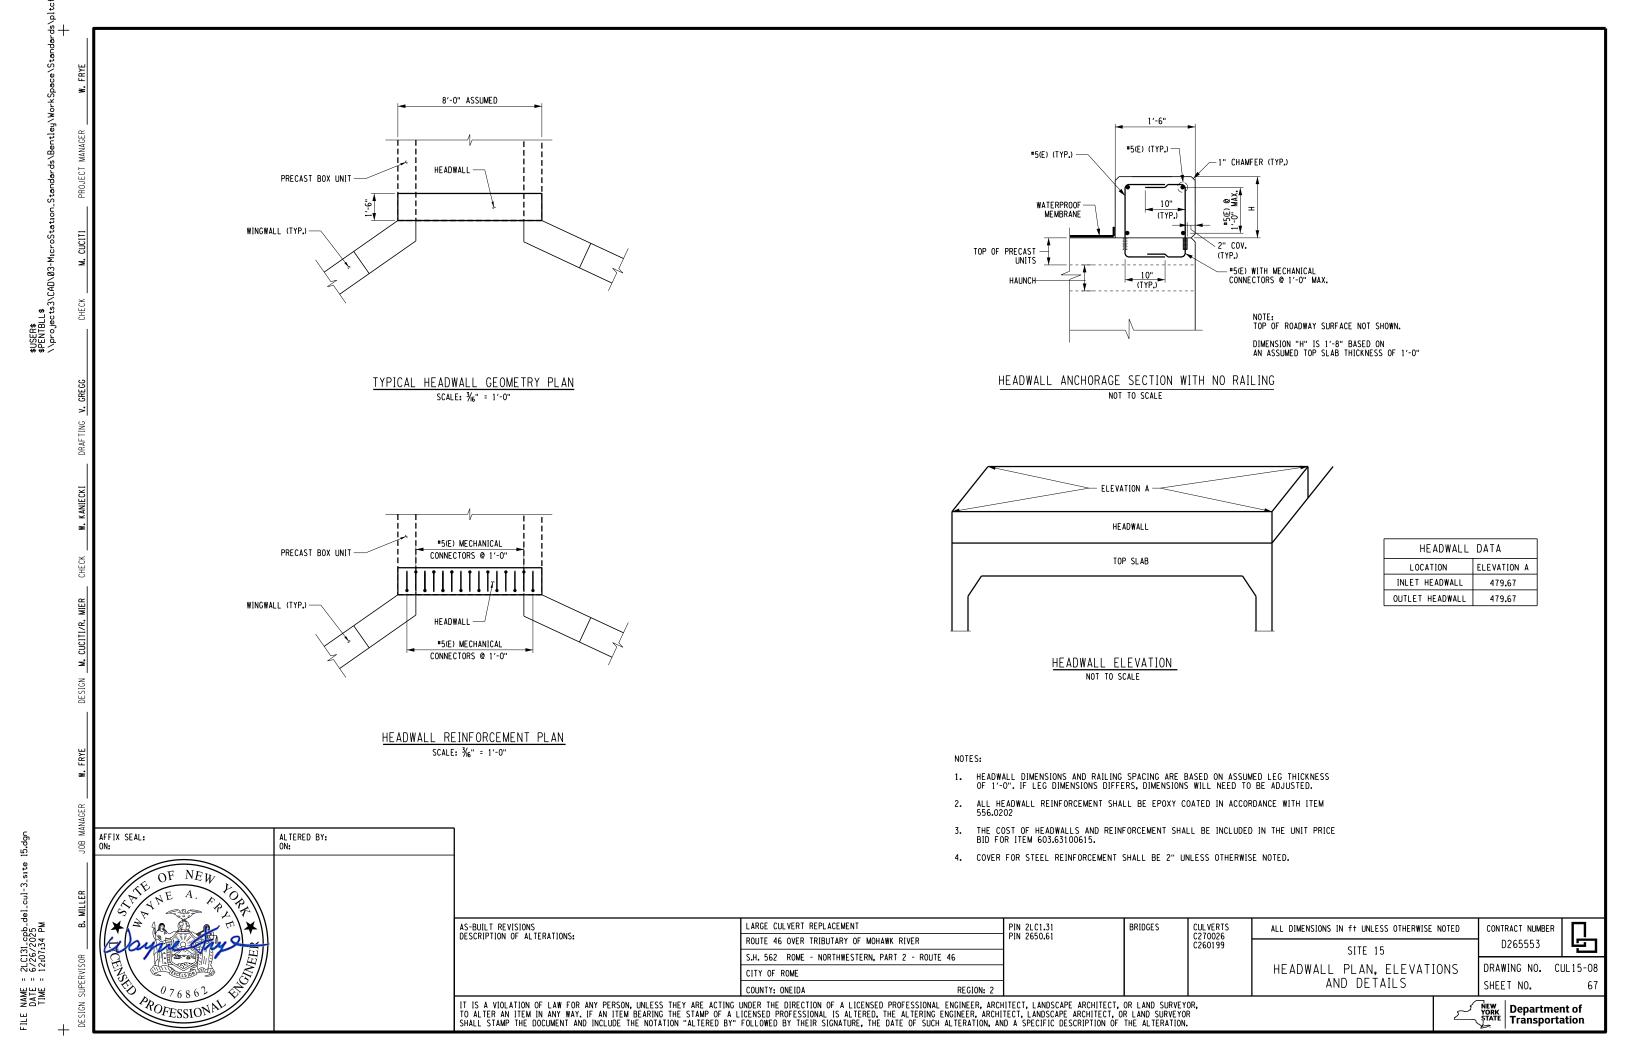


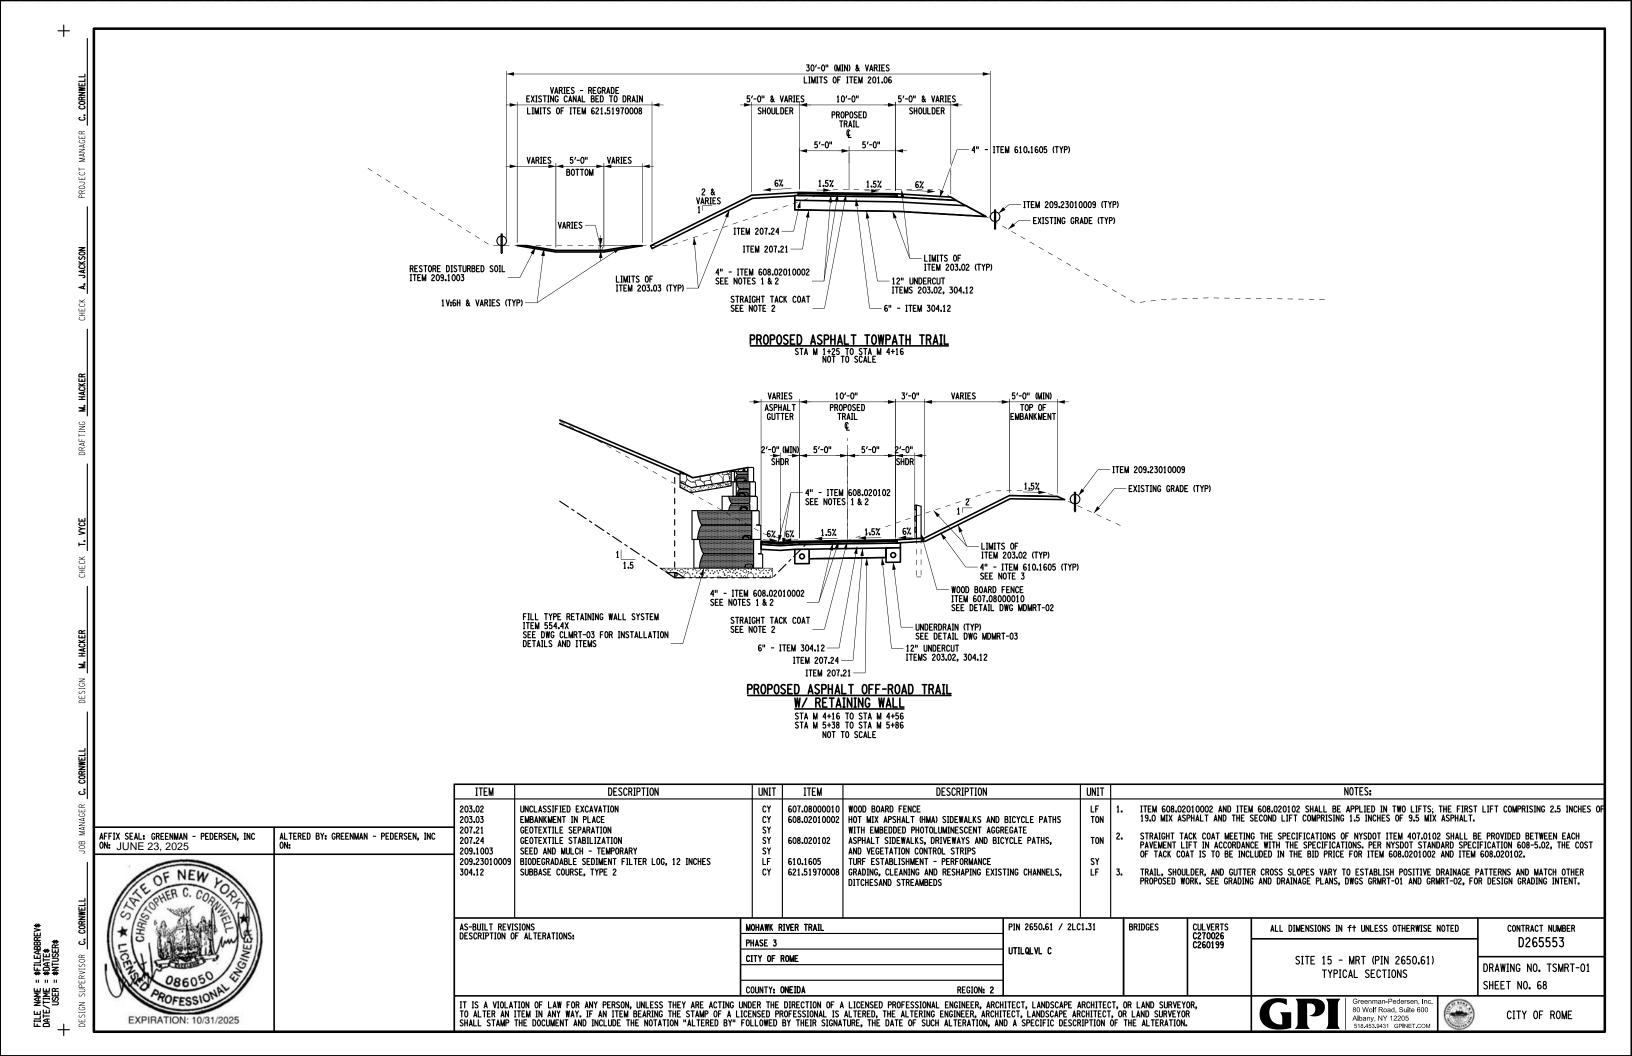


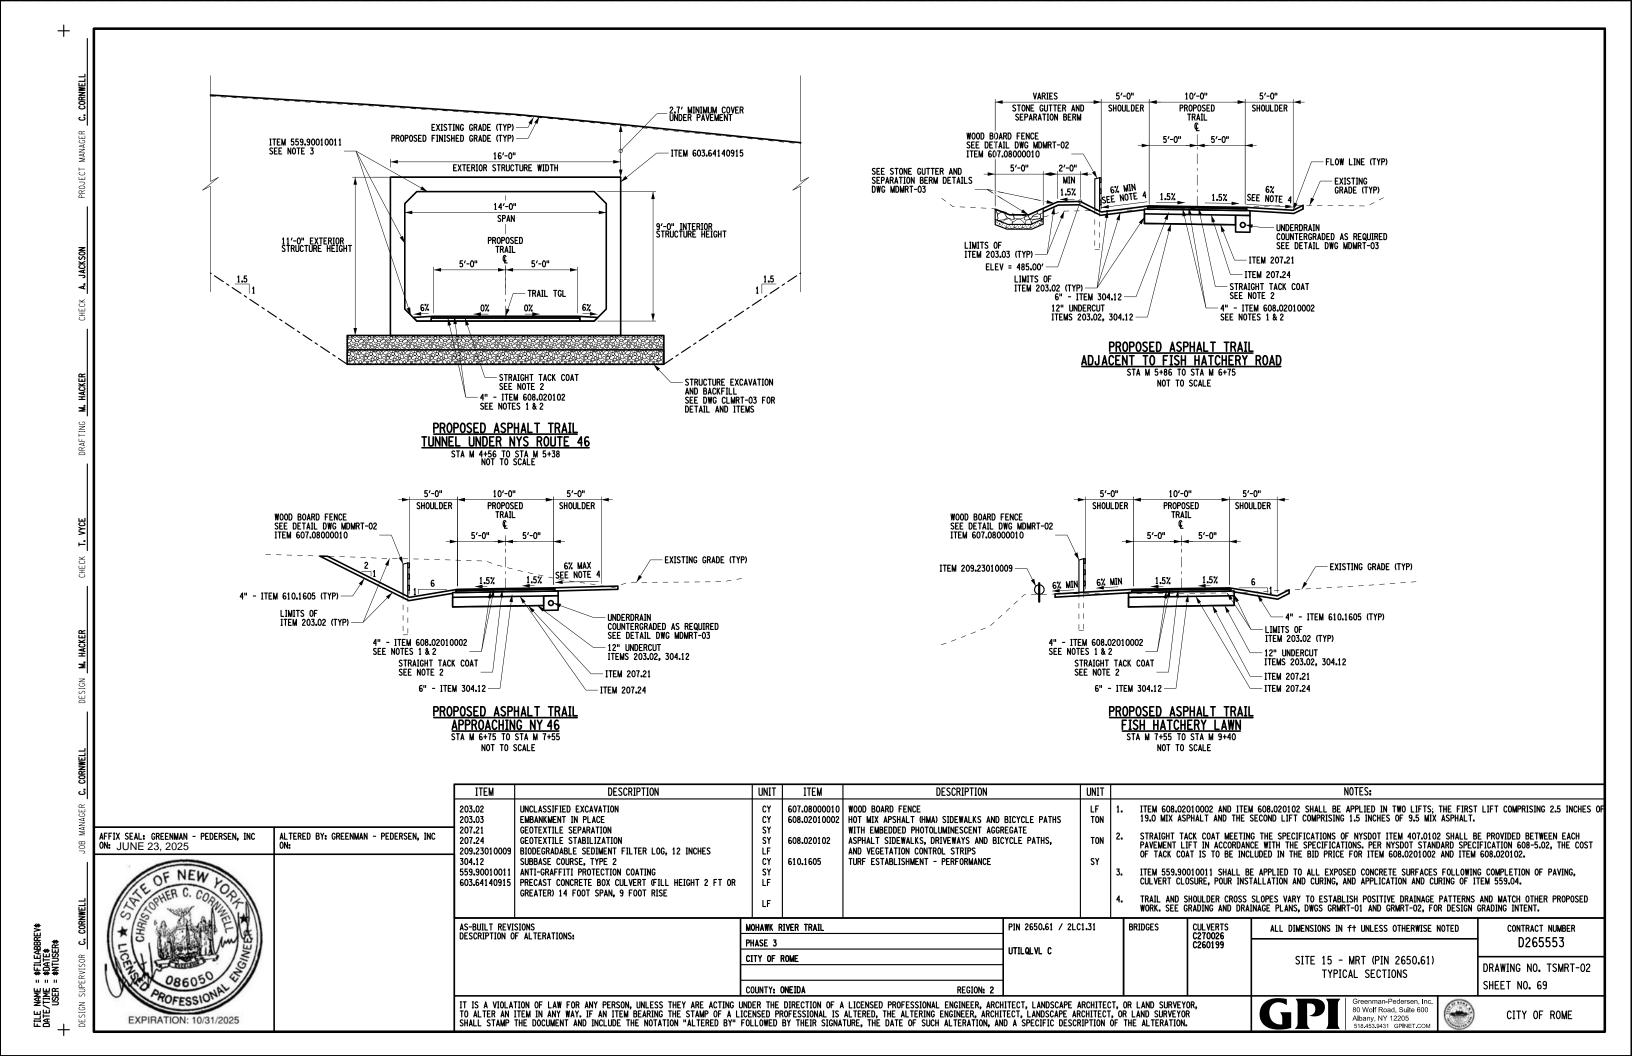


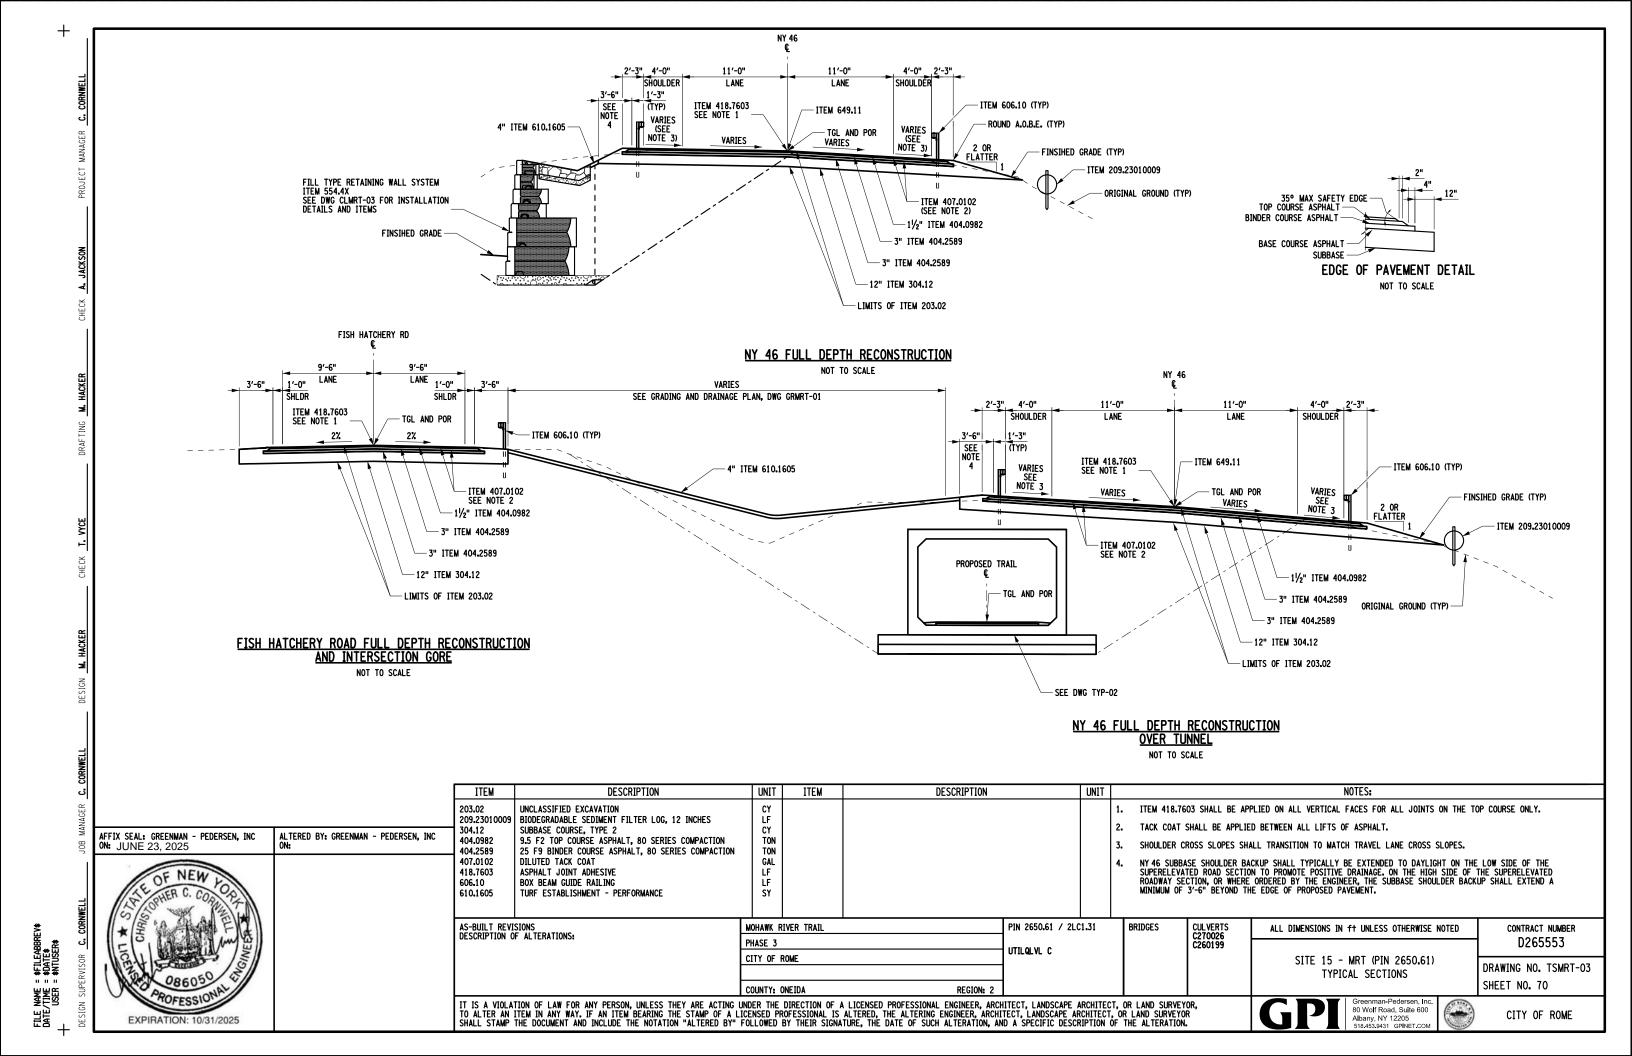














AFFIX SEAL: GREENMAN - PEDERSEN, INC ON: JUNE 23, 2025 ALTERED BY: GREENMAN - PEDERSEN, INC ON: EXPIRATION: 10/31/2025

CORPA	490.30 606.10 610.1605	MISCELLANEOUS BOX BEAM GUIDE TURF ESTABLISH
050 to	AS-BUILT REV DESCRIPTION	ISIONS IF ALTERATIONS:
\$101		TION OF LAW FOR

COUNTY: ONEIDA REGION: 2 IT IS A VIOLATION OF LAW FOR ANY PERSON, UNLESS THEY ARE ACTING UNDER THE DIRECTION OF A LICENSED PROFESSIONAL ENGINEER, ARCHITECT, LANDSCAPE ARCHITECT, OR LAND SURVEYOR, TO ALTER AN ITEM IN ANY WAY. IF AN ITEM BEARING THE STAMP OF A LICENSED PROFESSIONAL IS ALTERED, THE ALTERING ENGINEER, ARCHITECT, LANDSCAPE ARCHITECT, OR LAND SURVEYOR SHALL STAMP THE DOCUMENT AND INCLUDE THE NOTATION "ALTERED BY" FOLLOWED BY THEIR SIGNATURE, THE DATE OF SUCH ALTERATION, AND A SPECIFIC DESCRIPTION OF THE ALTERATION.				
TO ALTER AN ITEM IN ANY WAY. IF AN ITEM BEARING THE STAMP OF A LICENSED PROFESSIONAL IS ALTERED, THE ALTERING ENGINEER, ARCHITECT, LANDSCAPE ARCHITECT, OR LAND SURVEYOR		COUNTY: ONEIDA	REGION: 2	
	ALTER AN ITEM IN ANY WAY. IF AN ITEM BEARING THE STAMP OF A LIC	CENSED PROFESSIONAL IS ALTERED, THE ALTERING EN	NGINEER, ARCHITECT, LANDSCAPE ARCHITECT, OR	LAND SURVEYOR

Greenman-Pedersen, Inc. 80 Wolf Road, Suite 600 Albany, NY 12205 518.453.9431 GPINET.COM

CITY OF ROME

CITY OF ROME

DESCRIPTION

PIN 2650.61 / 2LC1.31 BRIDGES UTILQLVL C

UNIT

CULVERTS C270026 C260199

2. TACK COAT SHALL BE APPLIED BETWEEN ALL LIFTS OF ASPHALT.

ALL DIMENSIONS IN ft UNLESS OTHERWISE NOTED

SITE 15 - MRT (PIN 2650.61)

TYPICAL SECTIONS

NOTES:

ITEM 418.7603 SHALL BE APPLIED ON ALL VERTICAL FACES FOR ALL JOINTS ON THE TOP COURSE ONLY.

SHOULDER CROSS SLOPES SHALL TRANSITION TO MATCH TRAVEL LANE CROSS SLOPES.

CONTRACT NUMBER D265553

DRAWING NO. TSMRT-04 SHEET NO. 71

FISH HATCHERY ROAD MILL AND INLAY NOT TO SCALE

ITEM

UNIT

TON GAL LF

SY LF SY

PHASE 3

MOHAWK RIVER TRAIL

DESCRIPTION

BIODEGRADABLE SEDIMENT FILTER LOG, 12 INCHES

9.5 F3 TOP COURSE ASPHALT, 80 SERIES COMPACTION

MISCELLANEOUS COLD MILLING OF BITUMINOUS CONCRETE

UNCLASSIFIED EXCAVATION

ASPHALT JOINT ADHESIVE

BOX BEAM GUIDE RAILING TURF ESTABLISHMENT - PERFORMANCE

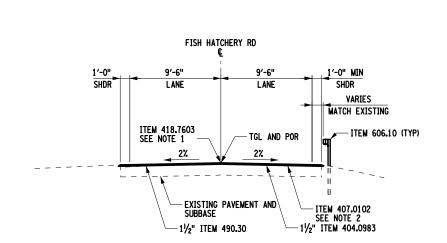
DILUTED TACK COAT

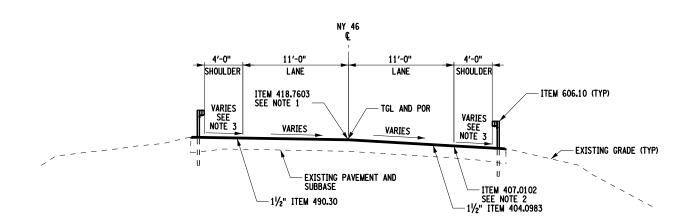
209.23010009

404.0983

407.0102

418.7603





NY 46 MILL AND INLAY NOT TO SCALE

GENERAL NOTES:

- DESIGN SPECIFICATIONS: NYSDOT LRFD CULVERT DESIGN SPECIFICATIONS WITH ALL PROVISIONS IN EFFECT AS OF JANUARY 2025 (FOR DESIGN PURPOSES, COMPRESSIVE STRENGTH OF CONCRETE FOR SUBSTRUCTURES AND DECK SLABS AT 28 DAYS:
- CONSTRUCTION SPECIFICATIONS: NYSDOT STANDARD SPECIFICATIONS CONSTRUCTION AND MATERIALS WITH ALL PROVISIONS IN EFFECT AS OF MAY 2025.
- THIS CULVERT SHALL BE MAINTAINED IN ACCORDANCE WITH THE GUIDELINES CONTAINED IN THE CURRENT VERSION OF THE AASHTO MAINTENANCE MANUAL FOR ROADWAYS AND
- DESIGN LIVE LOAD: AASHTO HL-93 W/ LRFD INV. FACTOR ≥1.2.
- NO KNOWN ASBESTOS CONTAINING MATERIALS ARE BELIEVED TO EXIST AND/OR THE 5. WORK TO BE PERFORMED UNDER THIS CONTRACT DOES NOT REQUIRE THE DISTURBANCE DESTRUCTION OR REMOVAL OF ANY OF THESE MATERIALS. IT IS THE EXPRESS INTENT OF THIS CONTRACT THAT THESE MATERIALS ARE NOT TO BE DISTURBED IN ANY WAY. SHOULD THE CONTRACTOR DISTURB OR ENCOUNTER ANY SUCH MATERIALS. THE CONTRACTOR SHALL IMMEDIATELY STOP WORK AND NOTIFY THE ENGINEER. THE CONTRACTOR SHALL OBTAIN WRITTEN PERMISSION FROM THE ENGINEER BEFORE PROCEEDING.
- DETAILS ON THE DRAWINGS LABELED AS "NOT TO SCALE" ARE INTENTIONALLY DRAWN NOT TO SCALE FOR VISUAL CLARITY. ALL OTHER DETAILS FOR WHICH NO SCALE IS SHOWN ARE DRAWN PROPORTIONAL AND ARE FULLY DIMENSIONED.
- ALL SHOP DRAWINGS SUBMITTED FOR THIS PROJECT SHALL BE IN US CUSTOMARY

SUBSTRUCTURES NOTES:

- THE COST OF WATER USED FOR COMPACTION OF THE SELECT STRUCTURAL FILL SHALL BE INCLUDED IN THE UNIT PRICE BID FOR ITEM 203.21 - SELECT STRUCTURE FILL.
- THE COST OF WATER USED FOR COMPACTION OF EMBANKMENT IN PLACE MATERIAL SHALL BE INCLUDED IN THE UNIT PRICE BID FOR ITEM 203.03. - EMBANKMENT IN PLACE.
- ALL PLACEMENTS OF SELECT STRUCTURE FILL, ITEM 203.21, SHALL BE COMPACTED TO 95 PERCENT OF STANDARD PROCTOR MAXIMUM DENSITY.

SUPERSTRUCTURE NOTES:

- FINISHED SURFACES OF NEW SIDEWALKS AND EXPOSED SURFACES OF NEW CONCRETE WINGWALLS OR RETAINING WALLS SHALL BE SEALED IN ACCORDANCE WITH ITEM 559.04 -PROTECTIVE SEALING OF CONCRETE WITH CPATING TYPE PROTECTIVE SEALER ON NEW CULVERT, DECKS, AND CULVERT DECK OVERLAYS. ONLY PENETRATING SEALERS SHALL BE USED. SEE ADDITIONAL NOTES IN PLANS.
- CARE SHALL BE TAKEN TO PREVENT CONTAMINATION OF THE SOIL BY THE SEALER. IF THE MANUFACTURER'S INSTRUCTIONS REQUIRE MIXING OF THE SEALER PRIOR TO APPLICATION, MIXING SHALL OCCUR IN A MANNER THAT WILL PREVENT CONTAMINATION OF THE SOIL. THE CONTRACTOR SHALL HAVE AVAILABLE FOR IMMEDIATE USE MATERIALS TO SOAK UP OR CONTAIN ANY ACCIDENTAL SPILLS. PRIOR TO THE APPLICATION OF THE SEALER, ANY OPENINGS IN THE SURFACE OF THE CULVERT DECK OR IN THE WALKING SURFACE, SUCH AS SCUPPERS OR OPEN DRAINS SHALL BE COVERED TO PREVENT CONTAMINATION OF THE WATERWAY. CARE SHALL BE TAKEN TO PREVENT SPRAYED SEALER FROM ENTERING THE WATERWAY BY ROLLING THE SEALER OR BY PHYSICALLY ISOLATING THE AREA TO BE SPRAYED FROM THE SOIL BY THE USE OF TARPS OR OTHER BARRIER-TYPE MEANS TO THE

RECONSTRUCTION NOTES:

- DUE TO THE NATURE OF RECONSTRUCTION PROJECTS, THE EXACT EXTENT OF RECONSTRUCTION WORK CANNOT BE ACCURATELY DETERMINED PRIOR TO THE COMMENCEMENT OF WORK. THE CONTRACT DOCUMENTS HAVE BEEN PREPARED BASED ON FIELD INSPECTION AND OTHER INFORMATION AVAILABLE AT THE TIME. ACTUAL FIELD CONDITIONS MAY REQUIRE MODIFICATIONS TO CONSTRUCTION DETAILS AND WORK QUANTITIES. THE CONTRACTOR SHALL PERFORM THE WORK IN ACCORDANCE WITH FIELD CONDITIONS.
- THE CONTRACTOR SHALL VERIFY DIMENSIONS NECESSARY FOR THE PROPER FIT OF PRECAST CONCRETE PRIOR TO ITS FABRICATION. THE COST OF FIELD VERIFYING DIMENSIONS SHALL BE INCLUDED IN THE PRICE BID FOR THE REINFORCED CONCRETE SPAN UNIT ITEM.
- THE CONTRACTOR SHALL PERFORM ALL WORK WITH CARE SO THAT ANY MATERIALS WHICH ARE TO REMAIN IN PLACE, OR WHICH ARE TO REMAIN THE PROPERTY OF THE STATE, WILL NOT BE DAMAGED. IF THE CONTRACTOR DAMAGES ANY MATERIALS WHICH ARE TO REMAIN IN PLACE OR WHICH ARE TO REMAIN THE PROPERTY OF THE STATE. THE DAMAGED MATERIALS SHALL BE REPAIRED OR REPLACED IN A MANNER SATISFACTORY TO THE ENGINEER AT THE
- WHEN ITEMS IN THE CONTRACT REQUIRE MATERIALS TO BE REMOVED AND DISPOSED OF, THE COST OF SUPPLYING A DISPOSAL AREA AND TRANSPORTATION TO THAT AREA SHALL BE INCLUDED IN THE UNIT PRICE BID FOR THOSE ITEMS.
- DURING REMOVAL OPERATIONS, THE CONTRACTOR SHALL NOT DROP WASTE CONCRETE, DEBRIS, AND OTHER MATERIAL TO THE AREA BELOW THE CULVERT EXCEPT WHERE THE PLANS SPECIFICALLY PERMIT THE DROPPING OF MATERIAL. PLATFORMS, NETS, SCREENS OR OTHER PROTECTIVE DEVICES SHALL BE USED TO CATCH THE MATERIAL. IF THE ENGINEER DETERMINES THAT ADEQUATE PROTECTIVE DEVICES ARE NOT BEING EMPLOYED, THE WORK SHALL BE SUSPENDED UNTIL ADEQUATE PROTECTION IS PROVIDED.
- ALL MATERIAL FALLING ON THE AREA BELOW AND ADJACENT TO THE CULVERT SHALL BE REMOVED AND DISPOSED OF BY THE CONTRACTOR AT NO COST TO THE STATE.
- THE COST OF FURNISHING, INSTALLING, MAINTAINING, REMOVING AND DISPOSING OF ALL PLATFORMS, NETS, SCREENS OR OTHER PROTECTIVE DEVICES SHALL BE INCLUDED IN THE UNIT PRICES BID FOR THE APPROPRIATE ITEMS OF THE CONTRACT.
- DURING THE COURSE OF CONSTRUCTION, THE CONTRACTOR SHALL CONDUCT OPERATIONS IN SUCH A MANNER AS TO PREVENT OR REDUCE TO A MINIMUM ANY DAMAGE TO ANY STREAM FROM POLLUTION BY DEBRIS. SEDIMENT. CONSTRUCTION MATERIALS OR OTHER FOREIGN MATERIALS. OR FROM THE OPERATION OF EQUIPMENT IN OR NEAR SUCH STREAMS. THE CONTRACTOR SHALL NOT RETURN DIRECTLY TO A STREAM ANY WATER WHICH HAS BEEN USED FOR WASH PURPOSES OR OTHER SIMILAR OPERATIONS WHICH CAUSE THE STREAM TO BECOME POLLUTED WITH SAND, SILT, CEMENT, OIL, OR OTHER IMPURITIES. IF THE CONTRACTOR USES WATER FROM A STREAM. THE CONTRACTOR SHALL CONSTRUCT AN INTAKE OR TEMPORARY DAM TO PROTECT AND MAINTAIN WATER RIGHTS AND TO SUSTAIN FISH LIFE DOWNSTREAM.

PRECAST CONCRETE NOTES:

THE CONTRACTOR SHALL MOUNT A NEW CULVERT IDENTIFICATION NUMBER C260199 PLATE THAT MEETS THE FOLLOWING MATERIAL REQUIREMENTS:

PANEL WITH REFLECTIVE BACKGROUND: THE ALUMINUM PANEL SHALL CONFORM TO THE REQUIREMENTS OF THE NYSDOT STANDARD SPECIFICATIONS. THE BACKGROUND MATERIAL SHALL BE GREEN REFLECTIVE SHEETING CONFORMING TO THE REQUIREMENTS OF THE NYSDOT STANDARD SPECIFICATION FOR CLASS A SHEETING. THE SIZE OF THE PANELS SHALL BE 1/8" INCH THICK BY 3 INCHES BY 12 INCHES, A THIN RUBBER OR PLASTIC CASKET OR SHEETING MATCHING THE PLATE SIZE SHALL BE PLACED BEHIND THE PLATE

NUMBERS: THE NUMBERS SHALL BE REFLECTIVE SHEETING CONFORMING TO THE REQUIREMENTS OF THE NYSDOT STANDARD SPECIFICATION FOR CLASS A SHEETING, EXCEPT THAT THE ADHESIVE SHALL BE PRESSURE-SENSITIVE SUCH THAT THE NUMBERS CAN BE APPLIED TO THE BACKGROUND IN THE FIELD. THE NUMBERS SHALL BE 2 INCHES HIGH AND SILVER-WHITE IN COLOR CONFORMING TO FHWA SERIES C DIMENSIONS.

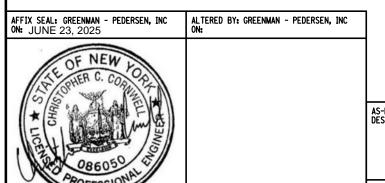
PRIOR TO PLACING THE NUMBERS ON THE PANEL. THE REFLECTIVE BACKGROUND SHALL BE CLEAN AND FREE OF DIRT AND OIL WHICH MAY ADVERSELY AFFECT PROPER ADHESION.
THE NUMBERS SHALL BE PLACED ON THE REFLECTIVE BACKGROUND, PERPENDICULAR TO THE LONGITUDINAL AXIS OF THE PANEL AND VERTICALLY CENTERED. THE REFLECTIVE BACKGROUND AND NUMBERS SHALL BE COATED AND/OR EDGE SEALED IN ACCORDANCE WITH

THE CIN PLATE SHALL BE ATTACHED TO THE BEGINNING ABUTMENT, RIGHT SIDE OF THE CULVERT USING EXPANSION ANCHORS. THE PLATE SHALL BE PLACED HIGH ON THE ABUTMENT, NEAR THE FASCIA OF THE CULVERT SO THAT IT CANNOT BE PAINTED OVER VIA A SPRAY PAINT CAN OR OTHERWISE EASILY REMOVED OR DAMAGED

THE COST ASSOCIATED WITH PROVIDING AND INSTALLING THE NEW CIN PLATE WILL BE INCLUDED IN THE PRICE BID FOR VARIOUS CONTRACT ITEMS.

PHOTOLUMINESCENT AGGREGATE

- THE PHOTOLUMINESCENT AGGREGATE INSTALLATION ON THE TRAIL IS TO BE PROVIDED BY THE CITY OF ROME. THE COST OF INSTALLING THE PHOTOLUMINESCENT AGGREGATE ON THE ASPHALT TRAIL SHALL BE PAID UNDER ITEM 615.03070108 INSTALLATION OF LANDSCAPE APPURTENANCE SUPPLIED BY OTHERS, TYPE 01.
- THE ONE (1) EACH TOTAL QUANTITY OF ITEM 615.03070108 INCLUDED IN THIS CONTRACT SHALL PAY FOR THE SATISFACTORY INSTALLATION OF ALL PHOTOLUMINESCENT AGGREGATE
- REFER TO THE SPECIAL SPECIFICATION ATTACHED WITHIN THE CONTRACT DOCUMENTS FOR ADDITIONAL DETAILS AND INSTRUCTIONS ON PHOTOLUMINESCENT AGGREGATE AND



EXPIRATION: 10/31/2025

AS-BUILT REVISIONS MOHAWK RIVER TRAIL DESCRIPTION OF ALTERATIONS: PHASE 3 CITY OF ROME COUNTY: ONEIDA

PIN 2650.61 / 2LC1.31 UTILQLVL C

BRIDGES

CULVERTS C270026 C260199

ALL DIMENSIONS IN ft UNLESS OTHERWISE NOTED

SITE 15 - MRT (PIN 2650.61) GENERAL NOTES

CONTRACT NUMBER D265553

DRAWING NO. GNMRT-01 SHEET NO. 72



AFFIX SEAL: GREENMAN - PEDERSEN, INC ON: JUNE 23, 2025

EXPIRATION: 10/31/2025

	ITEM 606.XXXX								
	GUIDE RAIL REMOVAL TABLE								
ID	FROM STATION	TO STATION	SIDE	LENGTH	COMMENTS	606.73	606.7920		
	F 2+46.00	F 2+46.00	RT	8.00			1		
	F 2+46.00	151+61.00	LT/RT	178.00		178			
	F 2+55.00	F 2+63.00	RT	8.00			1		
	F 2+63.00	F 3+57.00	RT	94.00		94			
					TOTALS:	272	2		

		ı	TEM 60	06.XXXX		ITEM QUANTITIES		
	GUIDE RAIL NEW INSTALLATION TABLE							
ID	FROM STATION	TO STATION	SIDE	LENGTH	COMMENTS	606.10	606.100002	
	149+05	149+40	RT	35.00		35.00		
	149+40	150+06	RT	66.00			66.00	
	150+06	151+89	RT	183.00		183.00		
	150+10	151+61	LT	151.00		151.00		
	150+10	F 2+63.00	LT/RT	46.00			46.00	
	F 2+63.00	F 3+57.00	RT	94.00		94.00		
					TOTALS:	463	112	

ITEM 607.41010010 (LF) TEMPORARY PLASTIC BARRIER FENCE										
FROM STATION	TO STATION	SIDE	COMMENTS	LENGTH (FT)						
M 1+00.00	M 3+29.00	RT		349						
M 6+50.00	M 8+70.00	LT		225						
M 8+78.00	M 9+49.00	LT		76						
			TOTAL:	650						

ALTERED BY: GREENMAN - PEDERSEN, INC ON:

ITEM 605.XXXX UNDERDRAIN TABLE											
INLET STATION	OUTLET STATION	SIDE	OUTLET INFO.	ITEM 605.1702 (LF)	END AREA (SF)	ITEM 605.1001 (CY)					
M 3+95	M 4+57	LT		62.00	2.25	5.17					
M 3+95	M 4+57	RT		62.00	2.25	5.17					
M 5+78	M 7+60	RT		182.00	2.25	15.17					

ITEM 607.08000010 (LF)										
WOOD BOARD FENCE										
FROM STATION	TO STATION SIDE COMMENTS		LENGTH (FT)							
M 3+22.00	M 4+16.00	LT		94						
M 3+22.00	M 4+55.00	RT		133						
M 5+86.00	M 9+46.00	LT		360						
			TOTAL:	587						

ITEM 209.23010009 (LF)											
BIODEGRADEABLE SEDIMENT FILTER LOG, 12 INCHES											
FROM STATION	TO STATION	COMMENT	SIDE	LENGTH (FT)							
148+08	149+30		RT	114							
M 1+00	M 6+61		RT	556							
148+08	149+25		RT	98							
M 6+47	M 7+91		LT	149							
M 8+66	M 9+48		LT	85							
			TOTAL:	1 002							

AS-BUILT REVISIONS DESCRIPTION OF ALTERATIONS:

MOHAWK RIVER TRAIL PHASE 3 CITY OF ROME COUNTY: ONEIDA

PIN 2650.61 / 2LC1.31 UTILQLVL C

CUL VERTS C270026 C260199 BRIDGES

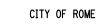
ALL DIMENSIONS IN ft UNLESS OTHERWISE NOTED SITE 15 - MRT (PIN 2650.61) MISCELLANEOUS TABLES

CONTRACT NUMBER D265553

DRAWING NO. MTMRT-01 SHEET NO. 73

IT IS A VIOLATION OF LAW FOR ANY PERSON, UNLESS THEY ARE ACTING UNDER THE DIRECTION OF A LICENSED PROFESSIONAL ENGINEER, ARCHITECT, LANDSCAPE ARCHITECT, OR LAND SURVEYOR, TO ALTER AN ITEM IN ANY WAY. IF AN ITEM BEARING THE STAMP OF A LICENSED PROFESSIONAL IS ALTERED, THE ALTERING ENGINEER, ARCHITECT, LANDSCAPE ARCHITECT, OR LAND SURVEYOR SHALL STAMP THE DOCUMENT AND INCLUDE THE NOTATION "ALTERED BY" FOLLOWED BY THEIR SIGNATURE, THE DATE OF SUCH ALTERATION, AND A SPECIFIC DESCRIPTION OF THE ALTERATION.







STATION

M 3+25

149+99

F 2+54

150+06

150+54

150+13

151+13

M 8+35

M 9+36

SIDE

RT

LT

LT

LT

LT

POSTS

EXPIRATION: 10/31/2025

					STRIPIN	IG TABLE					
BEGIN STATION	END STATION	SIDE	OFFSET	STRIPI	NG	DESIGN LENGTH (LF)	PAY FACTOR	ITEM 649.11 (LF)	ITEM 685.1102 (LF)	ITEM 685.1202 (LF)	ITEM 685.3104 (LF)
M 1+00	M 9+36	CL	0.00	YEL		811	1.00			811	
F 1+61	F 1+61	LT	VARIES	WSB		9	4.50				42
F 1+61	F 4+00	CL	0.00	YSDL		239	2.00			478	
F 3+58	151+64	LT/RT	VARIES	WEL		341	1.00		341		
M 3+74	M 6+16	LT	5.00	WEL		243	1.00		243		
M 3+74	M 6+16	RT	RT 5.00			241	1.00		241		
M 9+36	M 9+36	RT	VARIES	WSB		5	3.00				15
147+87	F 3+78	LT	VARIES	WEL		336	1.00		336		
147+99	148+44	CL	0.00	YSDL		44	2.00			88	
148+00	148+44	CL	0.00	CARD	S	44	1.00	44			
148+11	151+86	RT	11.00	WEL		371	1.00		371		
148+18	149+84	LT	11.00	WDE	L	169	0.33		56		
149+39	151+75	CL	0.00	YSDL	-	236	2.00			472	
149+50	151+75	CL	0.00	CARD	S	225	1.00	225			
							TOTALS:	269	1588	1849	57
			SIG	N SUMMARY	/ TABLE						
						ITEM	ITEM	ITEM		RN A.I	R.M.

MUTCD

M1-4

W1-8R

W1-8R

W1-8L

W1-8R

W1-8L

M4-4P

R2-1

D3-1

W1-2

W3-1

R1-1

R5-3 TOTALS:

DESCRIPTION

REMOVE AND DISPOSE EXISTING SIGN,

RT INSTALL NEW SIGN AND POST

INSTALL NEW SIGN AND POST

INSTALL NEW SIGN AND POST REMOVE AND DISPOSE EXISTING SIGN,

INSTALL NEW SIGN AND POST

INSTALL NEW SIGN AND POST

INSTALL NEW SIGN AND POST

INSTALL NEW SIGN AND POST REMOVE AND RESET EXISTING "FISH

LT INSTALL NEW SIGN AND POST RT INSTALL NEW SIGN AND POST

RT INSTALL NEW SIGN AND POST

RT INSTALL NEW SIGN AND POST

HATCHERY RD" SIGN FACE ON NEW

645.81

1

1

1

1

2

13

645.81090003

647.51

1

1

1

1

1

PROPOSED SWALE TABLE											
BEGIN STA END STA SIDE		SIDE	DESCRIPTION OF WORK	ITEM 206.0201 (CY)	ITEM 620.03 (CY)	ITEM 620.0802 (CY)					
M 3+75	M 4+64	LT		29.6	19.7	9.9					
M 4+42	M 4+60	RT		6.9	4.6	2.3					
M 5+35	M 5+84	RT		15.4	10.3	5.1					
M 5+35	M 6+47	LT		43.1	28.7	14.4					
			TOTALS:	95	63	32					

	DELINEATOR TABLE											
STATION	SIDE	ITEM 646.24 (EA)	ITEM 646.22 (EA)	ITEM 646.32 (EA)	ITEM 647.83001002 (EA)							
150+38	RT	1		1								
150+06	150+06 RT		2	1	1							
	TOTALS:	1	2	2	1							

		A15	TABLE OF R	IGHT-OF	-WAY ACQ	UISITIONS	250		
T.R.N.	A.R.M. IDENTIFIER	ROAD NAME	REPUTED OWNER	LIBER	PAGE	TAX MAP NO.	TYPE OF TAKE	APPROX. AREA (SQ. FT.)	REMARKS
1	M1P1	NYS ROUTE 46	PEOPLE OF THE STATE OF NEW YORK UNDER THE PRESENT JURISDICTION OF THE DEPARTMENT OF ENVIRONMENTAL CONSERVATION AND THE EXECUTIVE DEPARTMENT, OFFICE OF PARKS, RECREATION AND HISTORIC PRESERVATION (ABANDONED BLACK RIVER CANAL)			206.00-1-19	CU&O	18,318	CONSTRUCTION OF ASPHALT TRAIL AND PEDESTRIAN TUNNEL
2	M1 P2	NYS ROUTE 46	PEOPLE OF THE STATE OF NEW YORK UNDER THE PRESENT JURISDICTION OF THE DEPARTMENT OF ENVIRONMENTAL CONSERVATION AND THE EXECUTIVE DEPARTMENT, OFFICE OF PARKS, RECREATION AND HISTORIC PRESERVATION (ABANDONED BLACK RIVER CANAL)			206.00-1-19	CU&O	1,036	CONSTRUCTION OF ASPHALT TRAIL AND PEDESTRIAN TUNNEL
3	M2 P3	NYS ROUTE 46	PEOPLE OF THE STATE OF NEW YORK UNDER THE PRESENT JURISDICTION OF THE DEPARTMENT OF ENVIRONMENTAL CONSERVATION			206.01-1-12	CU&O	4,418	CONSTRUCTION OF ASPHALT TRAIL AND PEDESTRIAN TUNNEL
4	M2 P4	NYS ROUTE 46	PEOPLE OF THE STATE OF NEW YORK UNDER THE PRESENT JURISDICTION OF THE DEPARTMENT OF ENVIRONMENTAL CONSERVATION			206.01-1-12	CU&O	180	CONSTRUCTION OF ASPHALT TRAIL

AFFIX SEAL: GREENMAN - PEDERSEN, INC ON: JUNE 23, 2025	ALTERED BY: GREENMAN - PEDERSEN, INC ON:	
THE OF NEW PORTER C. CO. CO. O. P. P. C. CO. O. P. P. C. CO. O. P. P. C.		
* (8)		AS-BUILT REVISIONS DESCRIPTION OF ALTERATIONS:

COUNTY: ONEIDA IT IS A VIOLATION OF LAW FOR ANY PERSON, UNLESS THEY ARE ACTING UNDER THE DIRECTION OF A LICENSED PROFESSIONAL ENGINEER, ARCHITECT, LANDSCAPE ARCHITECT, OR LAND SURVEYOR, TO ALTER AN ITEM IN ANY WAY. IF AN ITEM BEARING THE STAMP OF A LICENSED PROFESSIONAL IS ALTERED, THE ALTERING ENGINEER, ARCHITECT, LANDSCAPE ARCHITECT, OR LAND SURVEYOR SHALL STAMP THE DOCUMENT AND INCLUDE THE NOTATION "ALTERED BY" FOLLOWED BY THEIR SIGNATURE, THE DATE OF SUCH ALTERATION, AND A SPECIFIC DESCRIPTION OF THE ALTERATION.

MOHAWK RIVER TRAIL

PHASE 3

CITY OF ROME

PIN 2650.61 / 2LC1.31

UTILQLVL C



ALL DIMENSIONS IN ft UNLESS OTHERWISE NOTED

SITE 15 - MRT (PIN 2650.61)

MISCELLANEOUS TABLES

CUL VERTS C270026 C260199

BRIDGES

SHEET NO. 74

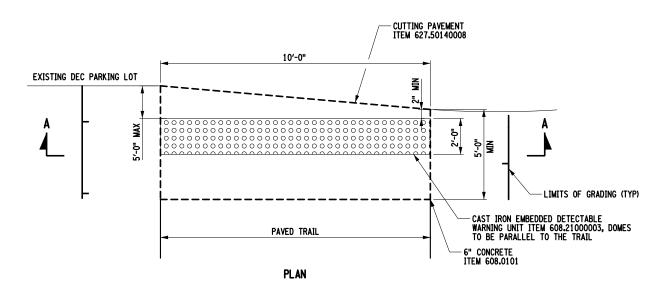
CITY OF ROME

CONTRACT NUMBER D265553

DRAWING NO. MTMRT-02


LIMITS OF 201.06 SEE NOTE 1 CLEAR 12'-0" FROM PROPOSED GRADE ITEM 201.0 VARIES 5'-0" VARIES PROPOSED TRAIL 5′-0" 5'-0" CUT/FILL CUT/FILL GRADE LINE, SEE GROUND SEDIMENT FILTER LOG ITEM 209.23010009 (TYP)

CLEARING AND GRUBBING DETAIL - ITEM 201.06



CLEARING AND GRUBBING NOTES:

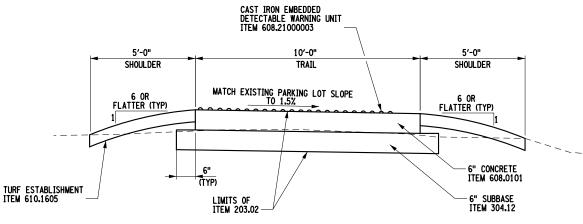- 1. THE CONTRACTOR SHALL REMOVE ALL OBSTRUCTIONS WITHIN THE HORIZONTAL AND VERTICAL CLEAR ZONE LIMITS SHOWN. THE ENGINEER SHALL APPROVE THE FINAL CLEARING LIMITS PRIOR TO ANY CLEARING COMMENCING. ADDITIONAL CLEARING AS SHOWN ON THE PLANS AND AS DIRECTED BY THE ENGINEER IN THE FIELD MAY BE NECESSARY TO CREATE CLEAR SIGHT LINES TO FUTURE USERS OF THE TRAIL. THE COST FOR REMOVAL OF OBSTRUCTIONS ABOVE GRADE SHALL BE INCLUDED IN THE UNIT PRICE BID FOR ITEM 201.06.
- 2. REMOVE OVERHANGING BRANCHES AT TREE TRUNK OR AT MAJOR BRANCH OUTSIDE OF CLEAR ZONE.
- CLEAR AND GRUB FROM EDGE OF PROPOSED TRAIL OR ROADWAY SHOULDER TO PROPOSED CUT/FILL SLOPE LIMITS, PLUS 5 FT FOR EROSION AND SEDIMENT CONTROL PRACTICES, WHICHEVER OCCURS FIRST TO A 12 FT MIN VERTICAL CLEARANCE. CONTRACTOR IS REQUIRED TO CUT LIMBS AT THE BRANCH BASE. ANY EXISTING TREES LOCATED WITHIN THE CLEARING AND GRUBBING LIMITS SHALL BE REMOVED UNDER ITEM 201.06.
- 4. ALL WOOD CHIPS PRODUCED FROM CLEARING AND GRUBBING SHALL BE SPREAD EVENLY ONTO THE ADJACENT AREAS OUTSIDE OF THE FINISHED TRAIL AND WITHIN THE EXISTING ROW, WITH NO PILES EXCEEDING 6 INCHES IN DEPTH IN ACCORDANCE WITH THE SWPPP.
- 5. CLEAR TREES WITHIN 10 FT OR A.O.B.E. OF SLOPE LIMITS. ROW OR OTHER ENVIRONMENTAL FACTORS MAY RESTRICT OPERATIONS.
- 6. GRUBBING OF STUMPS WILL BE REQUIRED BENEATH PROPOSED TRAIL EMBANKMENT AREAS ONLY. WHERE TREES OR EXISTING STUMPS ARE CLEARED AND GRUBBING IS NOT REQUIRED, THE TREE TRUNK OR EXISTING STUMP SHALL BE FLUSH CUT. EXPOSED STUMPS ARE NOT REQUIRED TO REMOVED, BUT SHALL BE CHIPPED OUT TO A DEPTH OF NOT LESS THAN 6 INCHES BELOW THE FINISHED GRADE WITH HOLES FILLED AS DIRECTED BY THE ENGINEER. NO SEPARATE PAYMENT WILL BE MADE FOR BACKFILL OR EARTH COVER NECESSARY TO COMPLETE THIS WORK. GRASS SHALL BE ESTABLISHED ON STUMP HOLES AND WILL BE PAID SEPARATELY. ALL WORK UNDER ITEM 201.06.
- 7. IN ALL SITUATIONS, THE PAY LIMIT SHALL BE THE AREA ACTUALLY CLEARED.
- 3. ALL BRANCHES TRIMMED WITHIN THE OFFSET DISTANCE SHALL BE PRUNED AS CLOSE TO THE TRUNK'S GROWTH COLLAR AS POSSIBLE.
- 9. CONTRACTOR IS RESPONSIBLE FOR LIMITING DISTURBED AREAS DURING ALL CLEARING AND GRUBBING/TRIM CANOPY (TREE PRUNING) OPERATIONS. ALL DISTURBED AREAS RESULTING FROM CLEARING AND GRUBBING CONSTRUCTION ACTIVITIES SHALL BE RESTORED AS DIRECTED BY THE ENGINEER. COST FOR THIS WORK IS TO BE INCLUDED IN THE CLEARING AND GRUBBING ITEM 201.06.
- 10. TREE REMOVAL SHALL BE COMPLETED BY EITHER CLEARING AND GRUBBING OR CLEARING, FLUSH CUTTING METHODS, AS INDICATED ON PLANS. WHOLESALE CLEARING AND GRUBBING OF TREES SHALL NOT BE ALLOWED IN PROTECTED WETLANDS, AND SHOULD BE AVOIDED AND MINIMIZED WHENEVER POSSIBLE. THE CONTRACTOR SHALL TAKE CARE NOT TO FURTHER IMPACT WETLANDS BEYOND WHAT IS REASONABLY NECESSARY TO CONDUCT CLEARING AND GRUBBING AND SELECTIVE TREE REMOVAL ACTIVITIES. ALL WETLAND AREAS SHOWN ON PLANS ADJACENT TO AND OUTSIDE OF CLEARING AND GRUBBING ZONES AND SELECTIVE TREE LOCATIONS SHALL BE LEFT UNDISTURBED TO PREVENT FURTHER IMPACTS. UNLESS OTHERWISE ALLOWED BY A PROJECT SPECIFIC ARMY CORPS OF ENGINEERS OR RYSDEC WETLAND PERMIT. ACTIVITIES NOT TO ENGROACH ON ADJACENTE WETLANDS INCLUDE, BUT NOT LIMITED TO, MOVEMENT OF VEHICLES, CONSTRUCTION STAGING, DISPOSAL OF WOOD CHIPPINGS, PLACEMENT OF EROSION CONTROL FEATURES, AND SPREADING OF SPOILED SOIL. VEGETATION PROTECTION BARRIER FENCING, SHALL BE INSTALLED PER THE SPECIFICATION AND PERMIT CONDITIONS.
- 11. ALL PROVISIONS OF SECTION 201 CLEARING AND GRUBBING, EXCEPT AS NOTED IN ITEM 201.06 SHALL APPLY.
- 2. ALL BRANCH TRIMMING, TREE CUTTING, AND CLEARING & GRUBBING SHALL ONLY OCCUR BETWEEN NOVEMBER 1 AND MARCH 31 TO AVOID IMPACTS TO MIGRATORY BATS AND HIBERNATING BATS.
- 13. SEE ADDITIONAL ENVIRONMENTAL NOTES ON DWG GNN-1.



SECTION A-A

CONTRACT NUMBER

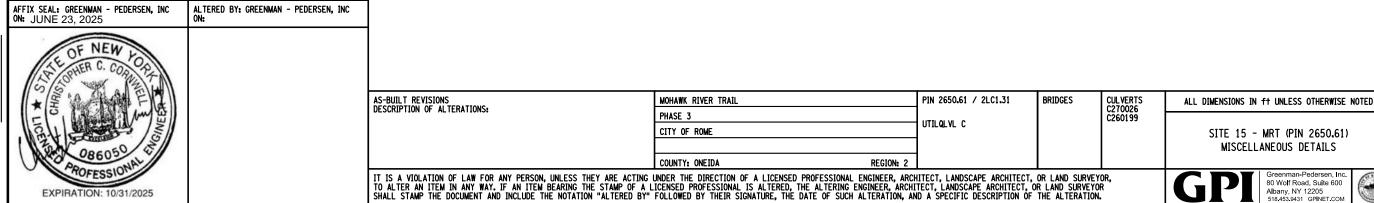
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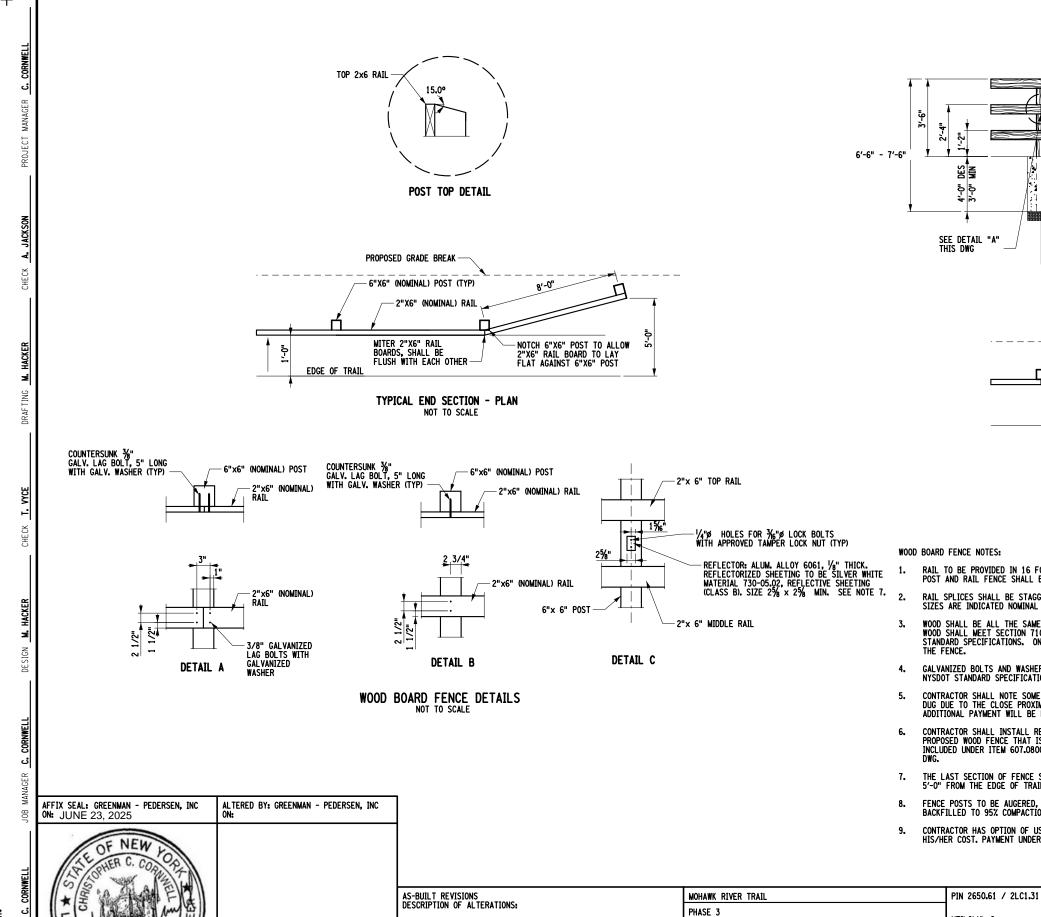
DRAWING NO. MDMRT-01

CITY OF ROME

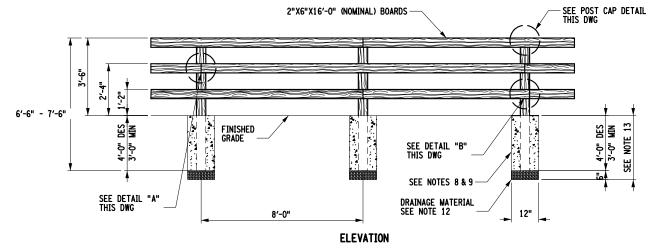
SHEET NO. 75

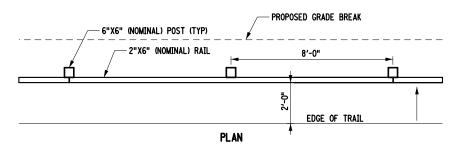
CONCRETE PAD BENEATH CAST IRON EMBEDDED DETECTABLE WARNING UNIT





EXPIRATION: 10/31/2025





WOOD BOARD FENCE - ITEM 607.08000010

•• WOOD BOARD FENCE SHALL BE PLACED A MINIMUM OF 2'-0" OR 5'-0" (TYP) OFF EDGE OF TRAIL. WHERE POSSIBLE, RAILING SHALL BE PLACED AS FAR AWAY AS POSSIBLE FROM TRAIL WITH THE 6% GRADED AREA. THE OFFSET SHALL BE DETERMINED & APPROVED BY THE ENGINEER.

WOOD BOARD FENCE NOTES:

- RAIL TO BE PROVIDED IN 16 FOOT LENGTHS. INSTALLATION OF ENTIRE POST AND RAIL FENCE SHALL BE PAID FOR UNDER ITEM 607.08000010.
- RAIL SPLICES SHALL BE STAGGERED AS SHOWN. ALL POST & RAIL SIZES ARE INDICATED NOMINAL DIMENSIONS.
- WOOD SHALL BE ALL THE SAME TYPE AND PRESSURE TREATED. ALL WOOD SHALL MEET SECTION 710-13 AND/OR 712-13 OF THE NYSDOT STANDARD SPECIFICATIONS. ONLY ONE WOOD TYPE SHOULD BE USED IN
- GALVANIZED BOLTS AND WASHERS SHALL MEET SECTION 719-01 OF THE NYSDOT STANDARD SPECIFICATIONS.
- CONTRACTOR SHALL NOTE SOME POSTS MAY BE REQUIRED TO BE HAND DUG DUE TO THE CLOSE PROXIMITY OF THE UTILITY ASSETS. NO ADDITIONAL PAYMENT WILL BE MADE FOR HAND DIGGING THE POSTS.
- CONTRACTOR SHALL INSTALL REFLECTORS ONLY ON EACH POST OF PROPOSED WOOD FENCE THAT IS BORDERING A CURVE, COST TO BE INCLUDED UNDER ITEM 607.08000010 OR AOBE. SEE DETAIL C THIS
- THE LAST SECTION OF FENCE SHALL BE FLARED OUT A MINIMUM OF 5'-0" FROM THE EDGE OF TRAIL.
- FENCE POSTS TO BE AUGERED, POST PLACED AND EXISTING MATERIAL BACKFILLED TO 95% COMPACTION.

UTILQLVL C

CONTRACTOR HAS OPTION OF USING FLOWABLE FILL FOR COMPACTION AT HIS/HER COST. PAYMENT UNDER ITEM 607.08000010.

BRIDGES

CUL VERTS C270026 C260199

- DRAINAGE MATERIAL SHALL BE NO. 1 OR NO. 2 STONE PER NYSDOT SPECIFICATION SECTION 703-02.
- 11. ALL WORK ON THIS DWG SHALL BE PAID UNDER ITEM 607.08000010.
- ALL LOCATIONS OF FENCE SHALL BE STAKED A MINIMUM OF TWO WEEKS PRIOR TO INSTALLATION TO ALLOW FOR APPROVAL BY THE ENGINEER.
- ONE (1) POST MAY BE SHORTENED BEYOND THE 3'-0" MINIMUM EMBEDMENT AS REQUIRED TO INSTALL POST OVER PROPOSED CULVERT C270026. THE EXTRA-SHORTENED POST SHALL BE HAND DUG, AND THE POST HOLE BACKFILLED WITH CLASS A CONCRETE. PAYMENT FOR THIS WORK INCLUDED UNDER ITEM 607.08000010.


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CITY OF ROME

COUNTY: ONEIDA


80 Wolf Road, Suite 600 Albany, NY 12205 518.453.9431 GPINET

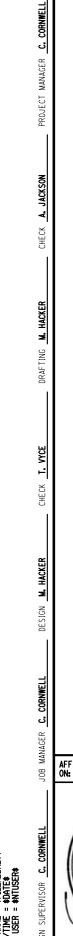CITY OF ROME




ITEM 605.1001 -DRAINAGE SWALE OR TOE OF SLOPE - LIMITS OF SUBBASE SEE TRAIL SECTIONS ON TYP DWGS PLACE 4' LONG X 2' WIDE X 1' DEEP LIGHT STONE FILL SEE NOTE 1 6" UNDERDRAIN PIPE LIMITS OF TRENCH AND CULVERT EXCAVATION ITEM 206.0201 6" UNDERDRAIN PIPE ITEM 605.1702 UNDERDRAIN DETAIL (TRAIL) YARD DRAIN DETAIL NOT TO SCALE NOT TO SCALE UNDERDRAIN NOTE

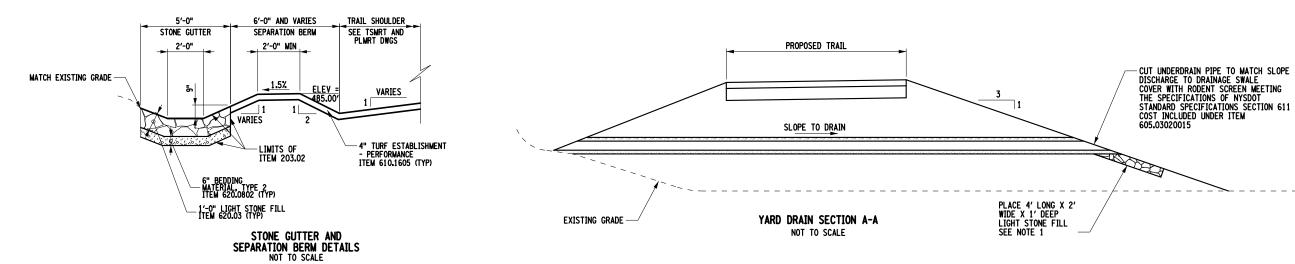THE DEPTH OF UNDERDRAIN INVERT FROM TRAIL FINISHED SHALL VARY AS REQUIRED TO ACHIEVE POSITIVE FLOW TO THE DESIRED OUTLET LOCATIONS.



STONE GUTTER AND SEPARATION BERM NOTES

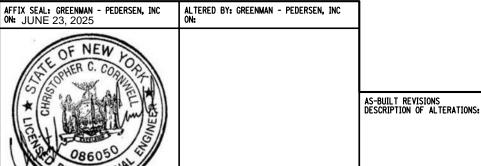- THE DEPTH OF THE STONE GUTTER AND FORESLOPE AND BACKSLOPE GRADES VARY TO MAINTAIN POSITIVE DRAINAGE AND A UNIFORM WIDTH OF STONE.
- SEE DWGS GRMRT-01 AND GRMRT-02 FOR PROPOSED SITE GRADING.
- 3. WOOD BOARD FENCE NOT SHOWN FOR CLARITY.



EXPIRATION: 10/31/2025

UNDERDRAIN OUTLET AND YARD DRAIN NOTE:

ALL MATERIALS AND WORK REQUIRED TO INSTALL UNDERDRAIN OUTLETS AND YARD DRAINS, INCLUDING EXCAVATION, BACKFILL, UNDERDRAIN PIPE, FITINGS, CONNECTIONS, AND STONE APRON ARE TO BE INCLUDED WITHIN ITEM 605.03020015.

ALL DIMENSIONS IN ft UNLESS OTHERWISE NOTED

SITE 15 - MRT (PIN 2650.61)

MISCELLANEOUS DETAILS

BRIDGES

CUL VERTS C270026 C260199

PIN 2650.61 / 2LC1.31

UTILQLVL C

COUNTY: ONEIDA IT IS A VIOLATION OF LAW FOR ANY PERSON, UNLESS THEY ARE ACTING UNDER THE DIRECTION OF A LICENSED PROFESSIONAL ENGINEER, ARCHITECT, LANDSCAPE ARCHITECT, OR LAND SURVEYOR, TO ALTER AN ITEM IN ANY WAY. IF AN ITEM BEARING THE STAMP OF A LICENSED PROFESSIONAL IS ALTERED, THE ALTERING ENGINEER, ARCHITECT, LANDSCAPE ARCHITECT, OR LAND SURVEYOR SHALL STAMP THE DOCUMENT AND INCLUDE THE NOTATION "ALTERED BY" FOLLOWED BY THEIR SIGNATURE, THE DATE OF SUCH ALTERATION, AND A SPECIFIC DESCRIPTION OF THE ALTERATION.


MOHAWK RIVER TRAIL

PHASE 3

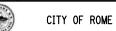CITY OF ROME



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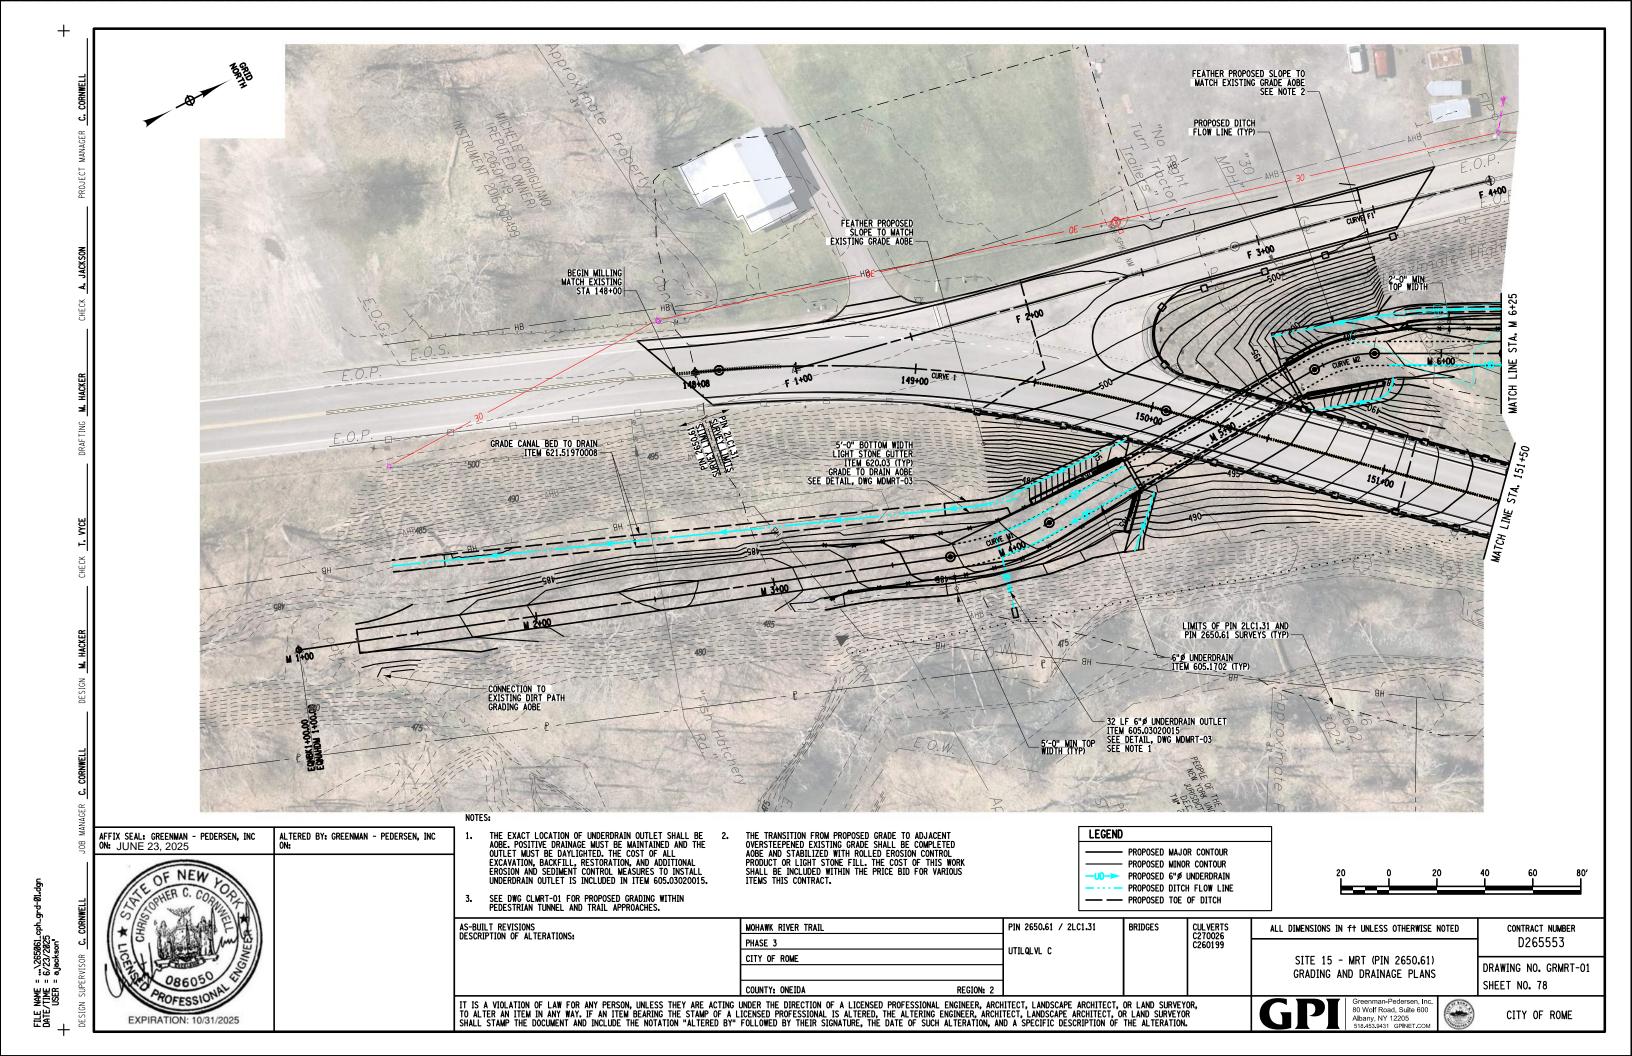


SHEET NO. 77

CONTRACT NUMBER

D265553

DRAWING NO. MDMRT-03



LIMITS OF PIN 2LC1.31 AND PIN 2650.61 SURVEYS (TYP) 40 LF 6" UNDERDRAIN YARD DRAIN ITEM 605.03020015 OUTLET THROUGH PROPOSED CULVERT C270026 MEDIUM STONE APRON SEE DETAIL, DWG MDMRT-03 2'-O" BOTTOM WIDTH LIGHT STONE GUTTER ITEM 620.03 MATCH EXISTING DITCH SEE DETAIL, DWG MDMRT-03 TS LF 6"Ø UNDERDRAIN OUTLET
ITEM 605.03020015
SEE DETAIL, DWG MSD-03
OUTLET BEYOND PROPOSED
CULVERT C270026 WINGWALL AOBE
SEE NOTE 1 MATCH 155+00 153+00 154+00 152+00 MATCH PIN 2LC1.31 GRADING TO DRAIN EXISTING SANITARY SEWER LINE DEPTH AND EXTENT UNKNOWN AFFIX SEAL: GREENMAN - PEDERSEN, INC ON: JUNE 23, 2025 ALTERED BY: GREENMAN - PEDERSEN, INC ON: LEGEND NOTES: PROPOSED MAJOR CONTOUR THE EXACT LOCATION OF UNDERDRAIN OUTLET SHALL BE AOBE. POSITIVE DRAINAGE MUST BE MAINTAINED AND THE OUTLET MUST BE DAYLIGHTED. THE COST OF ALL EXCAVATION, BACKFILL, RESTORATION, AND ADDITIONAL EROSION AND SEDIMENT CONTROL MEASURES TO INSTALL UNDERDRAIN OUTLET IS INCLUDED IN ITEM 605.03020015. PROPOSED MINOR CONTOUR PROPOSED 6"Ø UNDERDRAIN PROPOSED DITCH FLOW LINE
PROPOSED TOE OF DITCH AS-BUILT REVISIONS DESCRIPTION OF ALTERATIONS: CUL VERTS C270026 C260199 PIN 2650.61 / 2LC1.31 MOHAWK RIVER TRAIL BRIDGES CONTRACT NUMBER ALL DIMENSIONS IN ft UNLESS OTHERWISE NOTED FILE NAME = ...\265Ø61_0 DATE/TIME = 6/23/2025 USER = ajackson' D265553 PHASE 3 UTILQLVL C CITY OF ROME SITE 15 - MRT (PIN 2650.61) DRAWING NO. GRMRT-02 GRADING AND DRAINAGE PLANS SHEET NO. 79 COUNTY: ONEIDA IT IS A VIOLATION OF LAW FOR ANY PERSON, UNLESS THEY ARE ACTING UNDER THE DIRECTION OF A LICENSED PROFESSIONAL ENGINEER, ARCHITECT, LANDSCAPE ARCHITECT, OR LAND SURVEYOR, TO ALTER AN ITEM IN ANY WAY. IF AN ITEM BEARING THE STAMP OF A LICENSED PROFESSIONAL IS ALTERED, THE ALTERING ENGINEER, ARCHITECT, LANDSCAPE ARCHITECT, OR LAND SURVEYOR SHALL STAMP THE DOCUMENT AND INCLUDE THE NOTATION "ALTERED BY" FOLLOWED BY THEIR SIGNATURE, THE DATE OF SUCH ALTERATION, AND A SPECIFIC DESCRIPTION OF THE ALTERATION. Greenman-Pedersen, Inc. 80 Wolf Road, Suite 600 Albany, NY 12205 518.453.9431 GPINET.COM CITY OF ROME EXPIRATION: 10/31/2025

GENERAL EROSION AND SEDIMENT CONTROL SEQUENCE

- THE STATE WILL CONDUCT A PRE-CONSTRUCTION MEETING WITH THE CONTRACTOR, APPROPRIATE UTILITY COMPANY REPRESENTATIVES AND OTHER INTERESTED PARTIES TO DISCUSS THE SCOPE OF THE PROJECT.
- FOLLOWING WRITTEN NOTICE TO PROCEED, THE CONTRACTOR SHALL MEET WITH THE ENGINEER FOR AN ON-SITE MEETING TO DISCUSS THE LOCATIONS OF PROPOSED EROSION AND SEDIMENT CONTROLS, STAGING AREAS, SPOIL PILE LOCATIONS, STOCKPILE LOCATIONS, EQUIPMENT STORAGE AREAS, ETC. PRIOR TO ANY EXCAVATION BEING CONDUCTED ON-SITE.
- THE CONTRACTOR SHALL BE RESPONSIBLE FOR OBTAINING RELEASES FROM ANY OFF-SITE PROPERTY OWNERS WHERE EXCAVATED MATERIALS ARE TO BE STORED AND OR DISPOSED OF. A COPY OF ALL RELEASES SHALL BE GIVEN TO THE ENGINEER PRIOR TO ANY SUCH STORAGE/DISPOSAL ACTIVITIES. IT IS THE CONTRACTOR'S RESPONSIBILITY TO COMPLY WITH ANY PERMIT REQUIREMENTS FOR STORMWATER DISCHARGES AT THESE OFF-SITE STORAGE/DISPOSAL AREAS AT NO ADDITIONAL COST TO THE STATE. THE STATE SHALL NOT BE HELD RESPONSIBLE FOR ANY OPERATIONS CONDUCTED AT THESE SITES. THE CONTRACTOR SHALL TRY TO LIMIT THE NUMBER OF OFFSITE DISPOSAL SITES. THE CONTRACTOR SHALL AVOID HAVING DISPOSAL SITES WITHIN 100' OF STREAMS WET LANDS AND OPEN WATER WITHIN 100' OF STREAMS, WETLANDS, AND OPEN WATER.
- THE CONTRACTOR SHALL CONSTRUCT STABILIZED CONSTRUCTION ENTRANCES AT ALL ON-SITE STOCKPILE, STAGING, EQUIPMENT STORAGE AREAS, ETC. IN ACCORDANCE WITH NYSDOT STANDARD SHEET 209-05. ALL STOCKPILED SOILS SHALL HAYE A PERIMETER SILT FENCE INSTALLED AROUND THE BASE OF THE PILE AT NO
- THE CONTRACTOR SHALL INSTALL FILTER LOGS AT THE TOE OF THE FILL SLOPES WHERE SHOWN ON THE PLANS OR AOBE. FILTER LOGS SHALL BE KEYED INTO THE GROUND AS SHOWN ON THE NYSDOT STANDARD SHEETS. ADDITIONAL FILTER LOGS MAY BE REQUIRED AS ORDERED BY THE ENGINEER.
- THE CONTRACTOR SHALL HYDROSEED DISTURBED AREAS WHERE FINAL GRADING HAS BEEN COMPLETED AT THE APPLICATION RATES SHOWN ELSEWHERE.
- DURING THE LIFE OF THE CONTRACT, THE CONTRACTOR SHALL MAINTAIN ALL EROSION AND SEDIMENT CONTROLS AND RE-INSTALL AS NECESSARY, AND REMOVE ACCUMULATED SEDIMENTS AS ORDERED BY THE ENGINEER, ALL EROSION AND SEDIMENT CONTROLS SHALL BE INSPECTED WEEKLY. NEEDED REPAIRS SHALL BE
- AFTER THE SITE IS STABILIZED AS DETERMINED BY THE ENGINEER, ALL TEMPORARY EROSION AND SEDIMENT CONTROL MEASURES SHALL BE REMOVED BY THE CONTRACTOR.

EROSION AND SEDIMENT CONTROL NOTES

- AT ALL TIMES, THE CONTRACTOR SHALL TAKE MEASURES TO PROVIDE POSITIVE DRAINAGE OF SURFACE RUNOFF FROM THE WORK SITE AND CONTROL OF THE RUNOFF TO PREVENT EROSION, POLLUTION, SEDIMENTATION OR OTHER DISCHARGES WHICH WOULD AFFECT PROPERTIES ADJACENT TO THE WORK SITE. ALL MEASURES TAKEN TO PROVIDE POSITIVE DRAINAGE SHALL BE APPROVED BY THE ENGINEER PRIOR TO IMPLEMENTATION. THE COST FOR THIS WORK SHALL BE INCLUDED IN THE PRICE BID FOR VARIOUS
- ALL DISTURBED AREAS THAT ARE NOT TO BE PAVED OR STONE LINED SHALL BE MULCHED AND SEEDED. MULCHING AND SEEDING OF DISTURBED AREAS SHALL BE COMPLETED WITHIN 7 CALENDAR DAYS FOLLOWING FINAL GRADING OF THE DISTURBED AREA. IN THE EVENT THAT A DISTURBED AREA WILL REMAIN INACTIVE FOR MORE THAN 21 CALENDAR DAYS BEFORE FINAL GRADING CAN BE ACCOMPLISHED, THE DISTURBED AREA SHALL BE TEMPORARILY SEEDED AND MULCHED WITHIN 7 DAYS OF THE START OF THE INACTIVE PERIOD. TEMPORARY SEED CAN CONSIST OF 80 LBS/ACRE OF 100% ANNUAL RYE GRASS. PERMANENT SEEDING OF TEMPORARY SEEDED AREAS IS STILL REQUIRED. TEMPORARY SEED AND MULCH SHALL BE PAID UNDER ITEM 209,1003.
- PERMANENT SEED SHALL CONSIST OF NYSDOT STANDARD ROADSIDE SEEDMIX A. SEE NYSDOT STANDARD SPECIFICATION 713-04 FOR DETAILS.
- HYDROSEEDING SHALL NOT BE ALLOWED WITHIN 10 FEET OF OPEN WATER. AREAS WITHIN 10 FEET OF OPEN WATER SHALL BE HAND SEEDED AND MULCHED WITH STRAW.
- ALL AREAS OF EXPOSED SOIL ON A 14:3H SLOPE OR STEEPER, OR WHERE INDICATED ON THE PLANS, SHALL BE STABILIZED IMMEDIATELY UPON COMPLETION OF GRADING WITH SEED AND MULCH, ITEM 209.1003, AND WITH ROLLED EROSION CONTROL FABRIC, 209.190201. RUNOFF FROM AREAS OF EXPOSED SOLDHALL BE CONTAINED BY SEDIMENT FILTER LOGS, ITEM 209.23010009 PER THE TYPICAL SECTIONS AND EROSION AND SEDIMENT CONTROL PLAN.
- THE CONTRACTOR SHALL MAKE PROVISIONS TO DEWATER THE WORK AREA, AS NEEDED. THE COST OF DEWATERING SHALL BE INCLUDED UNDER VARIOUS ITEMS THIS CONTRACT.
- THE CONTRACTOR SHALL INSTALL STABILIZED CONSTRUCTION ENTRANCES AT ALL CONSTRUCTION EQUIPMENT STORAGE AREAS, STAGING AREAS, DISPOSAL SITES, ON-SITE BORROW PITS, STOCKPILE AREAS, ETC. THE COST OF THE STABILIZED CONSTRUCTION ENTRANCES SHALL BE INCLUDED IN THE VARIOUS BID ITEMS FOR THE CONTRACT. NO SEPARATE PAYMENT WILL BE MADE FOR THIS WORK.
- THE CONTRACTOR SHALL DOZER TRACK ALL SLOPES THAT ARE LARGE ENOUGH TO ACCOMMODATE SUCH EQUIPMENT. TRACKING SLOPES IN PROPER ORIENTATION SUCH THAT MICRO SHELVES ARE CREATED HELPS TO PREVENT EROSION AND SUPPORTS TURF ESTABLISHMENT. THE COST OF THIS ITEM SHALL BE INCLUDED IN THE VARIOUS LINE ITEMS OF THE CONTRACT. NO SEPARATE PAYMENT WILL BE MADE FOR

STREAM PROTECTION NOTES

- THE FOLLOWING STREAMS ARE WITHIN THE PROJECT LIMITS: TRIBUTARY OF MOHAWK RIVER, CLASS C, STANDARD C(T)
- DURING THE CONSTRUCTION, THE CONTRATOR SHALL CONDUCT ITS OPERATIONS IN SUCH A MANNER AS TO PREVENT ANY DAMAGE TO ANY WATERBODY, INCLUDING WETLANDS, FROM DIRECT OR INDIRECT POLLUTION BY DEBRIS, SEDIMENTATION OR OTHER FOREIGN MATERIAL, OR FROM THE MANIPULATION OF EQUIPMENT AND/OR MATERIALS IN
- NO WATER SHALL BE RETURNED DIRECTLY TO THE WATERBODY WHICH HAS BEEN USED FOR WASH PURPOSES OR OTHER SIMILAR OPERATIONS WHICH CAUSE THE WATER TO BE CONTAMINATED WITH SAND, SILT, CEMENT, DIL, OR OTHER IMPURITIES. IF WATER IS TO BE DRAWN FROM A LOCAL ON-SITE WATER SOURCE, TO PROTECT AQUATIC LIFE THERE MAY NOT BE ANY LOSS OF WATER ELEVATION AT THE SITE OF WITHDRAWAL OR IMMEDIATELY DOWNSTREAM OF THE SITE. WATER WITHDRAWAL SHALL BE ACCOMPLISHED WITH USE OF AN INLET SCREEN, WITH A SCREEN
- NO CONSTRUCTION, GRADING, FILLING, EXCAVATING, CLEARING, STOCKPILING, STORING, STAGING, OR OTHER RELATED ACTIVITIES SHALL BE PERMITTED WITHIN THE WATERBODY EXCEPT AS DESCRIBED IN THESE PLANS AND AUTHORIZED IN THE PERMIT DOCUMENTS. EROSION CONTROL ITEMS ARE REQUIRED AS SHOWN ON THE PLANS AND AS DIRECTED BY THE ENGINEER. ANY WORK IN THE WATERBODY NOT SHOWN ON PLANS SHALL NOT BE DONE WITHOUT COORDINATION AND APPROVAL BY THE ENGINEER IN CONSULTATION WITH THE REGIONAL CONSTRUCTION STRUCTURE STATEMENT OF THE PROPERTY OF THE PR
- TO PROTECT TROUT IN THE STREAM, IN-WATER WORK IS PROHIBITED BEGINNING OCTOBER 1 AND ENDING MAY 31. THE CONTRACTOR SHALL ACCOMPLISH STREAM WORK, INCLUDING WATER DIVERSION, COFFERDAM INSTALLATION AND REMOVAL, DURING THE PERIOD BETWEEN JUNE 1 AND SEPTEMBER 30. COFFERDAMS IN THE STREAM CHANNEL AND/OR WATER DIVERSIONS SHALL NOT BE ALLOWED PRIOR TO JUNE 1 AND AFTER SEPTEMBER 30 WITHOUT PRIOR WRITTEN APPROVAL FROM THE NYSDEC AND THE REGIONAL CONSTRUCTION ENVIRONMENTAL COORDINATOR. COFFERDAMS AND STREAM DIVERSIONS SHOULD BE SIZED WITH REGARD TO THE SEASONAL FLOW OF THE STREAM EXPECTED FOR THE TIME THEY ARE TO BE IN USE.
- PRIOR TO STARTING ANY WORK IN THE STREAM BED OR WITHIN 50 FEET OF THE WATERS EDGE, INCLUDING CONSTRUCTION ACCESS, WATER DIVERSION, AND HABITAT RESTORATION, THE CONTRACTOR SHALL COORDINATE WITH THE ENGINEER. THE ENGINEER SHALL CONSULT WITH THE REGIONAL CONSTRUCTION ENVIRONMENTAL COORDINATOR.
- ANY WORK IN THE WATERBODY NOT SHOWN ON PLANS AND NOT AUTHORIZED IN THE PERMIT MAY REQUIRE ADDITIONAL PERMITS OR PERMIT MODIFICATIONS AND SHALL NOT BE DONE WITHOUT COORDINATION AND APPROVAL BY THE ENGINEER IN CONSULTATION WITH THE REGIONAL CONSTRUCTION ENVIRONMENTAL COORDINATOR.

TREE CUTTING RESTRICTIONS

- IN ORDER TO PREVENT ANY DIRECT IMPACT TO INDIANA BAT (MYOTIS SODALIS) AND NORTHERN LONG-EARED BAT (MYOTIS SEPTENTRIONALIS), BOTH FEDERAL AND STATE LISTED ENDANGERED SPECIES, AND TRICOLOR BAT (PERIMYOTIS SUBFLAVUS), A PROPOSED FEDERAL ENDANGERED SPECIES, THE CONTRACTOR'S ATTENTION IS HEREBY DIRECTED TO THE FACT THAT TREE CUTTING RESTRICTIONS APPLY TO TREES THAT ARE 2 INCHES OR GREATER IN DIAMETER AT BREAST HEIGHT (DBH).
- DUE TO THE POSSIBLE PRESENCE OF PROTECTED BAT SPECIES, THE CONTRACTOR SHALL BE AWARE THAT TREES 2" DIAMETER OR LARGER MEASURED AT BREAST HEIGHT CAN ONLY BE CUT FROM NOVEMBER 1 TO MARCH 31. NO TREE CUTTING WILL OCCUR FROM APRIL 1 TO OCTOBER 31. THE CONTRACTOR SHALL SEQUENCE THE PROJECT ACCORDINGLY.
- THE CONTRACTOR SHALL REMOVE ALL UNDERLYING VEGETATION INCLUDING STUMPS AND DOWNED TREES UNDER

ENVIRONMENTAL PERMITS

BRIDGES

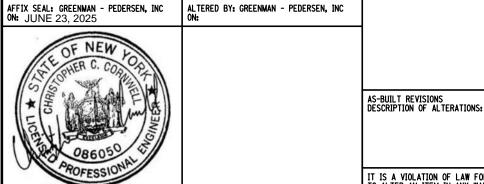
CULVERTS

C270026 C260199

- THE CONTRACTOR SHALL COMPLY WITH ALL ENVIRONMENTAL PERMIT REQUIREMENTS AND CONDITIONS SPECIFIED IN THE PERMIT(S) ISSUED FOR THE PROJECT. COST TO BE INCLUDED UNDER VARIOUS ITEMS IN THE CONTRACT.
- 2. THE FOLLOWING PERMITS ARE ANTICIPATED TO BE ACQUIRED FOR THE PROJECT:

US ARMY CORPS OF ENGINEERS: SECTION 404, NATIONWIDE PERMIT *3 - MAINTENANCE ACTIVITIES, NATIONWIDE PERMIT #42 - RECREATIONAL FACILITIES

NEW YORK STATE DEPARTMENT OF ENVIRONMENTAL CONSERVATION: GP-0-25-001 - GENERAL PERMIT FOR STORMWATER DISCHARGES, ARTICLE 24 - PERMIT FOR FRESHWATER WETLANDS, ARTICLE 15 - PERMIT FOR STREAM PROTECTION, 401 WATER QUALITY CERTIFICATION



EXPIRATION: 10/31/2025

PIN 2650.61 / 2LC1.31 MOHAWK RIVER TRAIL PHASE 3 UTILQLVL C CITY OF ROME COUNTY: ONEIDA

Albany, NY 12205

EROSION & SEDIMENT CONTROL NOTES 80 Wolf Road, Suite 600

ALL DIMENSIONS IN ft UNLESS OTHERWISE NOTED

SITE 15 - MRT (PIN 2650.61)

CITY OF ROME

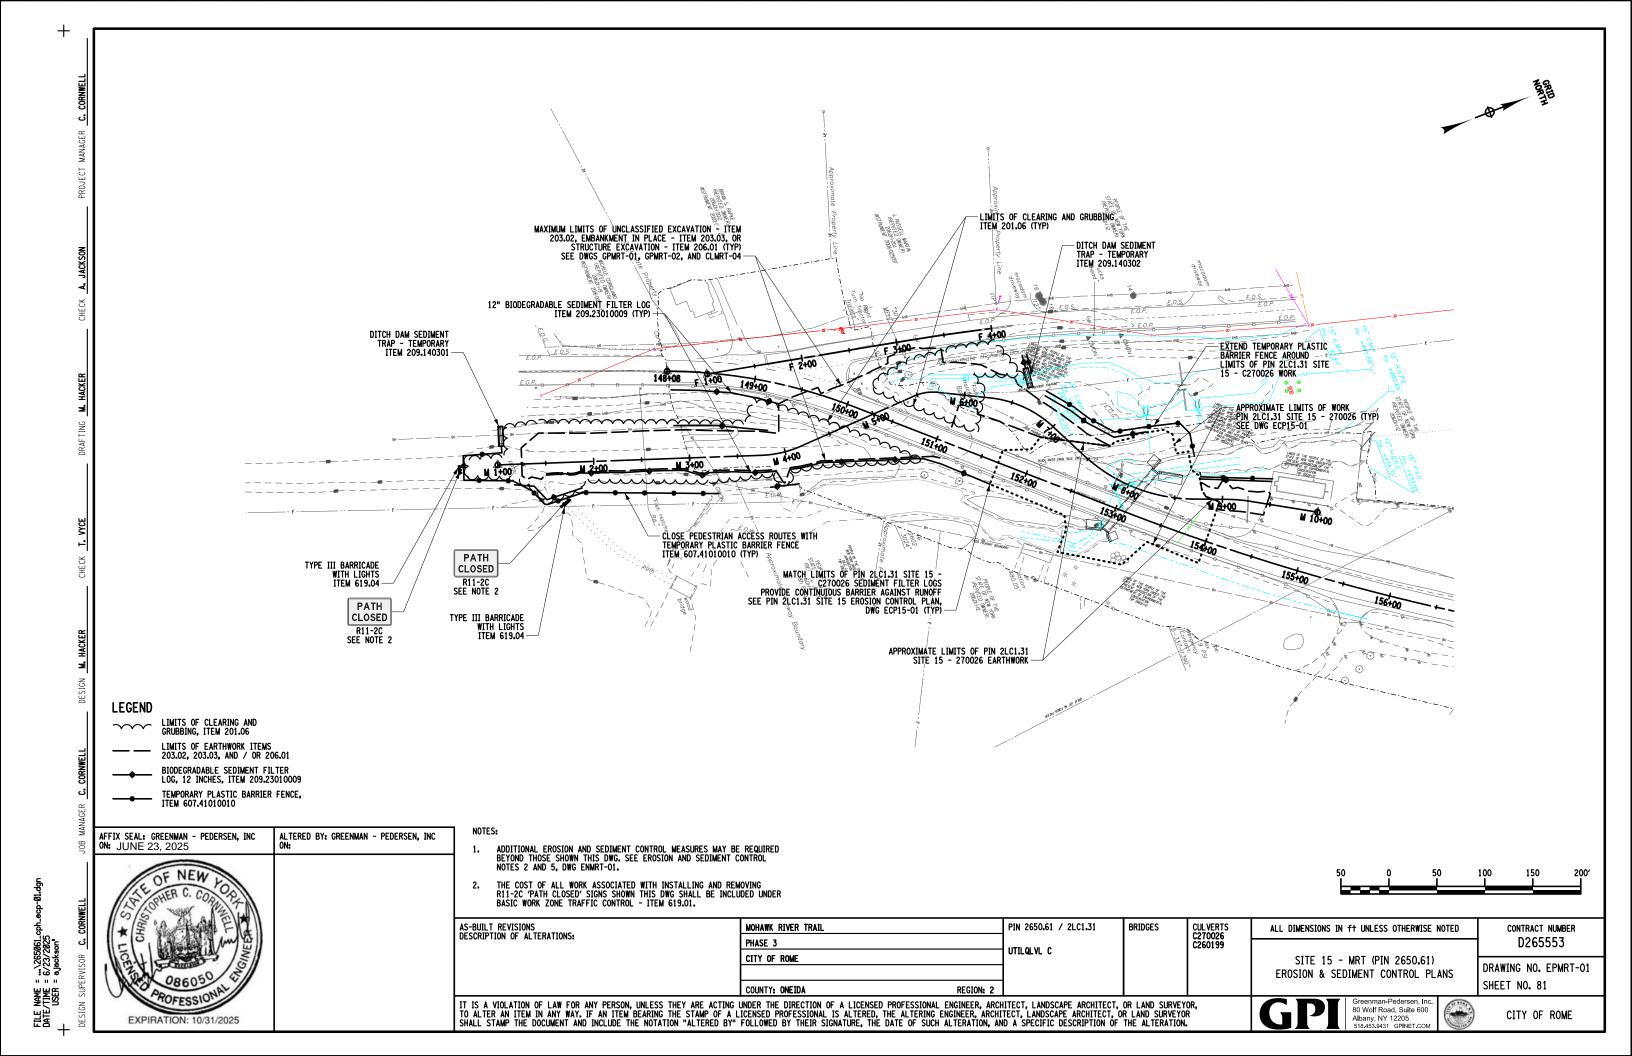
SHEET NO. 80

CONTRACT NUMBER


D265553

DRAWING NO. ENMRT-01

IT IS A VIOLATION OF LAW FOR ANY PERSON, UNLESS THEY ARE ACTING UNDER THE DIRECTION OF A LICENSED PROFESSIONAL ENGINEER, ARCHITECT, LANDSCAPE ARCHITECT, OR LAND SURVEYOR, TO ALTER AN ITEM IN ANY WAY. IF AN ITEM BEARING THE STAMP OF A LICENSED PROFESSIONAL IS ALTERED, THE ALTERING ENGINEER, ARCHITECT, LANDSCAPE ARCHITECT, OR LAND SURVEYOR SHALL STAMP THE DOCUMENT AND INCLUDE THE NOTATION "ALTERED BY" FOLLOWED BY THEIR SIGNATURE, THE DATE OF SUCH ALTERATION, AND A SPECIFIC DESCRIPTION OF THE ALTERATION.



BOX BEAM REMOVAL ITEM 606.73 (TYP) END MILLING MATCH EXISTING STA F 3+68 SAWCUTTING ASPHALT ITEM 627.50140008 (TYP) CU&0 4,418± SF END FULL DEPTH RECONSTRUCTION GRADING LIMITS BEGIN MILLING STA F 3+68 HISTORIC MARKER TO REMAIN BOX BEAM GUIDE RAILING
* TEM 606.10 (TYP) -REMOVE AND DISPOSE EXISTING BOX BEAM END ASSEMBLIES ITEM 606.7920 RESTORE RESIDENTIAL DRIVEWAY
6" ITEM 608.020102 ON
8" ITEM 304.12 END MILLING GRADING LIMITS BEGIN FULL DEPTH RECONSTRUCTION STA 149+46 AND STA F 2+00 STA EQUALITY STA 148+54.16 = STA F 1+04.38 -BEGIN MILLING BEGIN CARDS MATCH EXISTING STA 148+00 INSTALL CARDS 2'-0" MIN Top Width 47 LF CURVED BOX
BEAM GUIDE RAILING
ITEM 606.100002
R=16' R=695' BEGIN CARDS STA 149+50 k 1+00 149+00 CURVE M8+08 END FULL DEPTH RECONSTRUCTION BEGIN MILLING STA 151+10 BEGIN TAPER STA 149+05 END TAPER STA 149+30 -END CARDS STA 148+44 GRADE CANAL BED TO DRAIN-ITEM 621.51970008 65 LF CURVED BOX BEAM GUIDE RAILING-ITEM 606.100002 R=525±' LIGHT STONE GUTTER ITEM 620.03 (TYP) SEE DWG GRMRT-01 LIMITS OF FILL ITEM 203.03 (TYP) BEGIN ASPHALT TRAIL MATCH EXISTING GRADE ADJACENT AREA TO PROVIDE CONTINUOUS TRAVEL SURFACE AOBE STA M 1+25 78 LF PEDESTRIAN TUNNEL C260199 ITEM 603.64140915 SEE CLMRT DWG'S FILL TYPE RETAINING WALL ITEM 554.4X (TYP) SEE CLMRT DWG'S -LIMITS OF CUT _ITEM 203.02 (TYP) LIMITS OF PIN 2LC1.31 AND PIN 2650.61 SURVEYS (TYP) ASPHALT TRAIL TAPER (TYP) -6"Ø UNDERDRAIN OUTLET ITEM 605.03020015 SEE DWG GRMRT-01 WOOD BOARD FENCE ITEM 607.08000010 (TYP) -U&0 18,318± SF SP AFFIX SEAL: GREENMAN - PEDERSEN, INC ON: JUNE 23, 2025 ALTERED BY: GREENMAN - PEDERSEN, INC ON: LEGEND CURVE 1 CURVE F1 CURVE M1 CURVE M2 THE EXACT LOCATION OF UNDERDRAIN OUTLET SHALL BE AOBE. POSITIVE DRAINAGE MUST BE MAINTAINED AND THE OUTLET MUST BE DAYLIGHTED. THE COST OF ALL EXCAVATION, BACKFILL, RESTORATION, AND ADDITIONAL EROSION AND SEDIMENT CONTROL MEASURES TO INSTALL UNDERDRAIN OUTLET IS INCLUDED IN ITEM 605.03020015. ASPHALT TRAIL - ITEM 608.020102 WITH PHOTOLUMINESCENT AGGREGATE - ITEM 615.03070108 PI = 149+12.96 PI = M 3+96.62 PI = M 5+59.40 PI = F 3+45.05 L = 43.89' L = 188.11' = 109.92' = 26.18' R = 540.00' R = 2924.76' R = 115.00' R = 50.00' ASPHALT TRAIL - ITEM 608.020102 AS-BUILT REVISIONS DESCRIPTION OF ALTERATIONS: CUL VERTS C270026 C260199 PIN 2650.61 / 2LC1.31 BRIDGES MOHAWK RIVER TRAIL CONTRACT NUMBER ALL DIMENSIONS IN ft UNLESS OTHERWISE NOTED D265553 PHASE 3 FILE NAME = \$FILEABBF DATE/TIME = \$DATE\$. USER = \$NTUSER\$ UTILQLVL C CITY OF ROME SITE 15 - MRT (PIN 2650.61) DRAWING NO. PLMRT-01 GENERAL PLANS SHEET NO. 82 COUNTY: ONEIDA IT IS A VIOLATION OF LAW FOR ANY PERSON, UNLESS THEY ARE ACTING UNDER THE DIRECTION OF A LICENSED PROFESSIONAL ENGINEER, ARCHITECT, LANDSCAPE ARCHITECT, OR LAND SURVEYOR, TO ALTER AN ITEM IN ANY WAY. IF AN ITEM BEARING THE STAMP OF A LICENSED PROFESSIONAL IS ALTERED, THE ALTERING ENGINEER, ARCHITECT, LANDSCAPE ARCHITECT, OR LAND SURVEYOR SHALL STAMP THE DOCUMENT AND INCLUDE THE NOTATION "ALTERED BY" FOLLOWED BY THEIR SIGNATURE, THE DATE OF SUCH ALTERATION, AND A SPECIFIC DESCRIPTION OF THE ALTERATION. Greenman-Pedersen, Inc. 80 Wolf Road, Suite 600 Albany, NY 12205 518.453.9431 GPINET.COM CITY OF ROME EXPIRATION: 10/31/2025

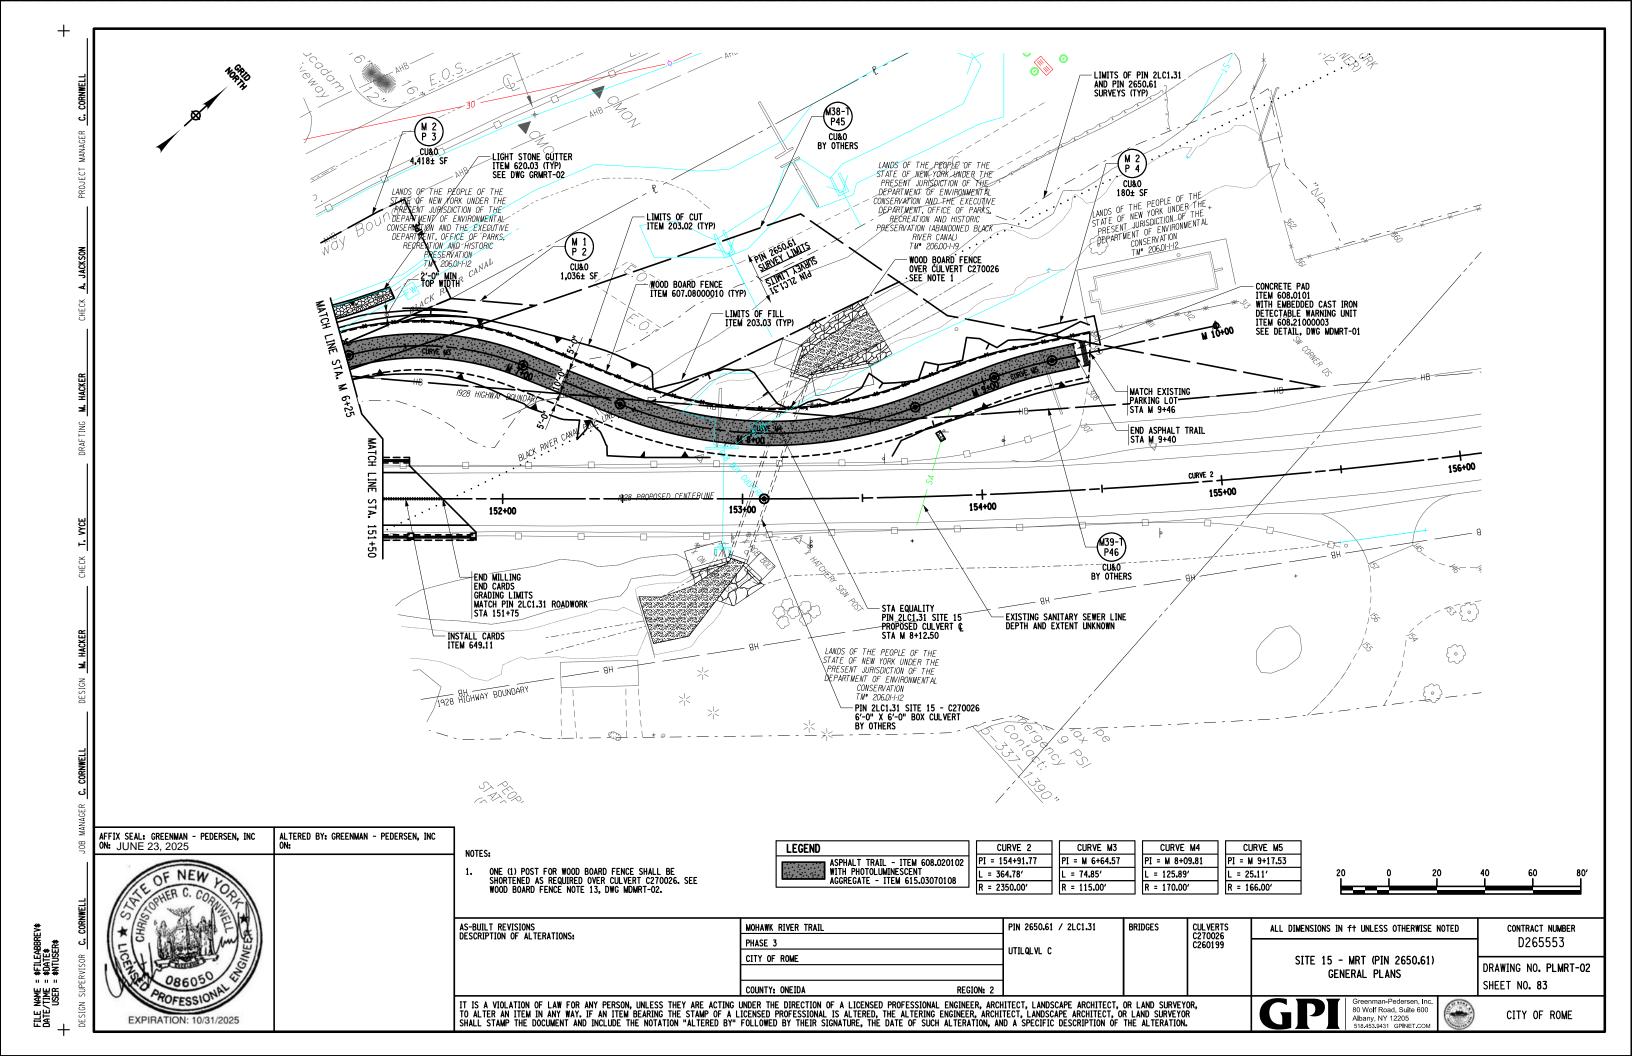

MUTCD

AFFIX SEAL: GREENMAN - PEDERSEN, INC ON: JUNE 23, 2025 ALTERED BY: GREENMAN - PEDERSEN, INC ON: EXPIRATION: 10/31/2025

AS-BUILT REVISIONS DESCRIPTION OF ALTERATIONS:

			2			2	2.30 SF		4.60 SF
	M3-1P	1-2		North	645.5102	24"	х	12"	2.00 SF
	IAID-TL	172	1	(IOAIII)	043.3102	2	2.00 S	F	2.00 SF
550	M1-5NY	1-2		46	645.5102	24"	х	24"	4.00 SF
	MIT-DIMI	1-2	1		043.3102	4	1.00 S	F	4.00 SF
	M6-2P	1-2			645.5102	21"	х	15"	2.20 SF
		12	1		043.3102	2.20 SF			2.20 SF
	W1-8R	1-3, 1-4, 1-6			645.5101	18"	х	24"	3.00 SF
	W1-9V		3			3.00 SF			9.00 SF
	W1-8L	1115			645.5101	18"	х	24"	3.00 SF
	AA 1-OF	1-4, 1-6	2		043.3101	3.00 SF		F	6.00 SF

SIGN INSTALLATION TABLE

TEXT

LOCATION

1-1, 2-1

PAYMENT

TOTAL **PAYMENT** AREA 2.30 SF

SIZE

ITEM

645.5101

SIGN INSTALLATION TABLE								
митср	LOCATION		техт	ITEM	SIZE AREA			PAYMENT AREA TOTAL PAYMENT
								AREA
R3-1	1-5			645.5102	24"	х	24"	4.00 SF
		1			4.00 SF			4.00 SF
M4-4P	1-5		TRUCK	645.5102	24"	х	12"	2.00 SF
		1			2.00 SF			2.00 SF
R2-1	1-7		SPEED LIMIT	645.5102	24"	х	30''	5.00 SF
		1	30		5.00 SF			5.00 SF
W3-1	2-2			645.5101	18"	х	18"	2.30 SF
		1			2.30 SF			2.30 SF
R1-1	2-3		STOP	645.5101	18"	х	18"	2.30 SF
		1			2.30 SF			2.30 SF
R5-3	2-4		NO MOTOR YEHICLES	645.5101	18"	х	18"	2.30 SF
		1			2.30 SF			2.30 SF

PIN 2650.61 / 2LC1.31

UTILQLVL C

SIGN TEXT DATA SHEET

CUL VERTS C270026 C260199

BRIDGES

Greenman-Pedersen, Inc. 80 Wolf Road, Suite 600 Albany, NY 12205 518.453.9431 GPINET.COM

ALL DIMENSIONS IN ft UNLESS OTHERWISE NOTED

SITE 15 - MRT (PIN 2650.61)



CITY OF ROME

SHEET NO. 84

CONTRACT NUMBER

D265553

DRAWING NO. STMRT-01


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MOHAWK RIVER TRAIL

PHASE 3

CITY OF ROME

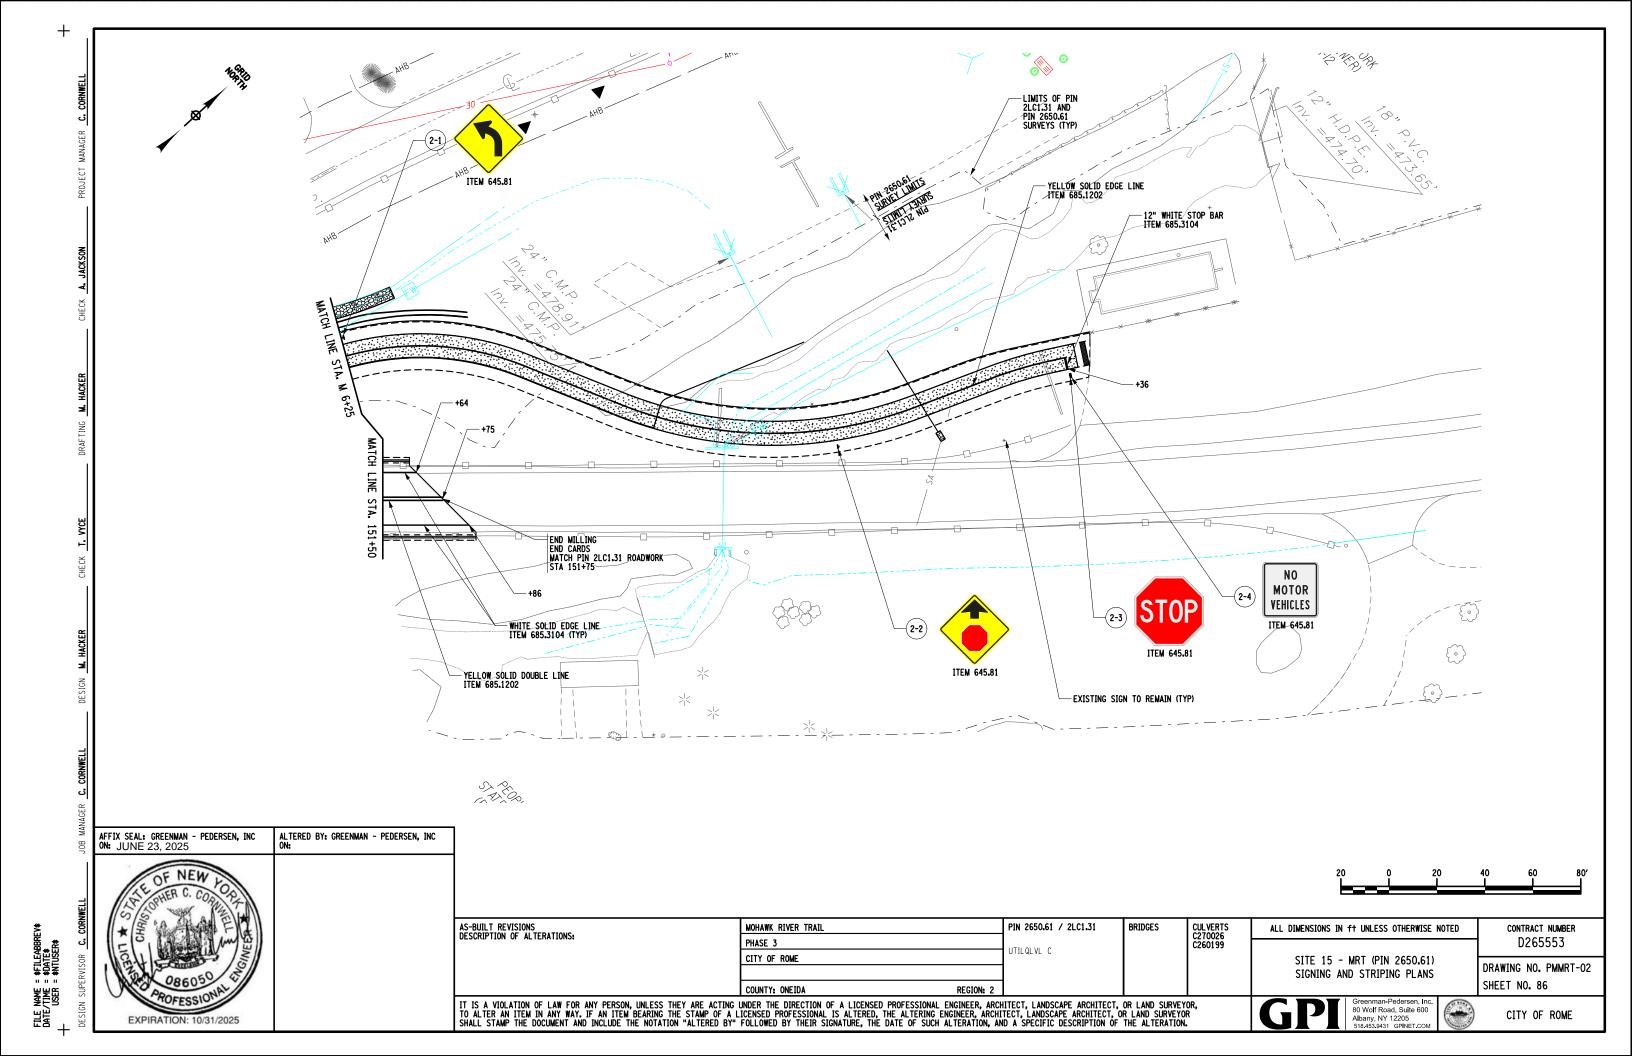ITEM 645.81090003 ITEM 645.81 ITEM 647.51 TRUCK SPEED LIMIT North EXISTING SIGN TO REMAIN (TYP) 24" WHITE STOP BAR ITEM 685.3104 (TYP) ITEM 645.81 ITEM 647.51 WHITE DOTTED EXTENSION LINE ITEM 685,1102 (TYP) ITEM 645.81 ITEM 647.51 +37 -R=15' WHITE SOLID EDGE LINE ITEM (685.3104 (TYP) +61 -+18 -REMOVE AND REPLACE EXISTING +16 DELINEATOR
ITEMS 646.22, 646.32,
647,83001002 (TYP) -WHITE SOLID EDGE LINE SET ITEM 685.3104 (TYP) - YELLOW DOTTED EXTENSION LINE ITEM 685.1202 (TYP) +39 -YELLOW SOLID DOUBLE LINE ITEM 685.1202 (TYP) REMOVE AND RESET "FISH HATCHERY RD" SIGN DTEMS 645.81 (2 EA), 647.51 £ (·) YELLOW SOLID EDGE LINE ITEM 685.1202 WHITE SOLID EDGE LINE ITEM 685.3104 (TYP) TTEM 645.81090003 TTEM 645.81 TTEM 647.51 LIMITS OF PIN 2LC1.31 AND PIN 2650.61 SURVEYS (TYP) -REMOVE AND RESET EXISTING MILE MARKER ITEMS 646.24, 646.32 ITEM 645.81 AFFIX SEAL: GREENMAN - PEDERSEN, INC ON: JUNE 23, 2025 ALTERED BY: GREENMAN - PEDERSEN, INC ON: AS-BUILT REVISIONS DESCRIPTION OF ALTERATIONS: CUL VERTS C270026 C260199 PIN 2650.61 / 2LC1.31 BRIDGES MOHAWK RIVER TRAIL CONTRACT NUMBER ALL DIMENSIONS IN ft UNLESS OTHERWISE NOTED D265553 PHASE 3 UTILQLVL C CITY OF ROME SITE 15 - MRT (PIN 2650.61) DRAWING NO. PMMRT-01 SIGNING AND STRIPING PLANS SHEET NO. 85 COUNTY: ONEIDA IT IS A VIOLATION OF LAW FOR ANY PERSON, UNLESS THEY ARE ACTING UNDER THE DIRECTION OF A LICENSED PROFESSIONAL ENGINEER, ARCHITECT, LANDSCAPE ARCHITECT, OR LAND SURVEYOR, TO ALTER AN ITEM IN ANY WAY. IF AN ITEM BEARING THE STAMP OF A LICENSED PROFESSIONAL IS ALTERED, THE ALTERING ENGINEER, ARCHITECT, LANDSCAPE ARCHITECT, OR LAND SURVEYOR SHALL STAMP THE DOCUMENT AND INCLUDE THE NOTATION "ALTERED BY" FOLLOWED BY THEIR SIGNATURE, THE DATE OF SUCH ALTERATION, AND A SPECIFIC DESCRIPTION OF THE ALTERATION. Greenman-Pedersen, Inc. 80 Wolf Road, Suite 600 Albany, NY 12205 518.453.9431 GPINET.COM CITY OF ROME EXPIRATION: 10/31/2025



L = 32'-0" L = 52'-0" 0' (WALL BEGINS) T.O.W.= 494.99 0' (WALL BEGINS) T.O.W.= 494.00 T.O.W.= 485.00 500 500 500 - 500 +32' (WALL ENDS) T.O.W.= 487.35 T.O.W.= 486.50 T.O.W.= 494.99 495 495 495 +52' (WALL ENDS) T.O.W.= 485.00 EXISTING GROUND ITEM 554.40 (TYP) T.O.W.= 488.00 490 490 490 490 PROPOSED GRADE @ FACE OF WALL PROPOSED GRADE & FACE OF WALL 485 485 1'-6" MIN. EMBEDMENT 1'-6" MIN. EMBEDMENT 475 475 -20' -10' +10' +30' +40' +50' +60' +70' -20' -10' +30' +40' +50' +60' +70' +20' +20' NW RETAINING WALL - ELEVATION 150.27 SQ.FT. - ITEM 554.40 144.79 SQ.FT. - ITEM 554.41 **NE RETAINING WALL - ELEVATION** 18.13 SQ.FT. - ITEM 554.40 188.39 SQ.FT. - ITEM 554.41 103.45 SQ.FT. - ITEM 554.42 L = 40'-0" L = 16'-0" 500 - 500 0' (WALL BEGINS) -ITEM 554.42 (TYP) T.O.W.= 495.42 495 495 - EXISTING GROUND 0' (WALL BEGINS) T.O.W.= 483.42 ITEM 554.41 (TYP) 490 490 490 EXISTING GROUND 485 PROPOSED GRADE PROPOSED GRADE 480 1'-6" MIN. EMBEDMENT 1'-6" MIN. EMBEDMENT 475 -20' -10' +20' +30' +60' +70' -20' -10' +20' +30' +40' +10' +10' SE RETAINING WALL - ELEVATION SW RETAINING WALL - ELEVATION 42.30 SQ.FT. - ITEM 554.40 145.88 SQ.FT. - ITEM 554.41 192.66 SQ.FT. - ITEM 554.42 152.02 SQ.FT. - ITEM 554.41 **PAYMENT LEGEND** ITEM 554.40 ITEM 554.41 ITEM 554.42 FOLLOWING INSTALLATION OF FILL TYPE RETAINING WALLS, ALL EXPOSED FACES OF ITEM
554.4X SHALL BE TREATED WITH ITEM 559.91100010 - ANTI-GRAFFITI PROTECTIVE COATING.
ITEM 559.91100010 SHALL BE:
ONE COMPONENT
CLEAR-DRYING
NON-SACRIFICIAL (PERMANENT)
TESTED ACCORDING TO ASTM D7089 AND CAPABLE OF ACHIEVING A RATING OF
"CLEANABILITY LEVEL 1" AFTER CLEANING
SPRAY-APPLIED
APPLIED ACCORDING TO MANUFACTURER'S INSTRUCTIONS THE ELEVATIONS AND DIMENSIONS SHOWN REPRESENT THE MINIMUM REQUIRED FOR FILL TYPE WALL STABILITY. FINAL DESIGN ELEVATIONS AND DIMENSIONS MAY VARY BASED UPON SELECTED WALL SYSTEM OR UNANTICIPATED FIELD CONDITIONS. AFFIX SEAL: GREENMAN - PEDERSEN, INC ON: JUNE 23, 2025 ALTERED BY: GREENMAN - PEDERSEN, INC 2. SEE DWG CLMRT-03 FOR TYPICAL WALL SECTION. ALL FILL TYPE RETAINING WALLS THIS CONTRACT SHALL BE CAPABLE OF STANDING UNREINFORCED AT FULL DESIGN HEIGHT. - APPLIED ACCORDING TO MANUFACTURER'S INSTRUCTIONS ALL ADDITIONAL PROVISIONS OF ITEM 559.91100010 SHALL APPLY. ITEM 554.4X SHALL BE SOURCED FROM THE SAME WALL SUPPLIER FOR ALL WALLS. 5. FINISH ON ITEM 554.4X SHALL BE CHISELED GRANITE OR APPROVED EQUAL. AS-BUILT REVISIONS DESCRIPTION OF ALTERATIONS: CUL VERTS C270026 C260199 PIN 2650.61 / 2LC1.31 BRIDGES MOHAWK RIVER TRAIL ALL DIMENSIONS IN ft UNLESS OTHERWISE NOTED CONTRACT NUMBER D265553 PHASE 3 UTILQLVL C CITY OF ROME SITE 15 - MRT (PIN 2650.61) DRAWING NO. WLMRT-01 WALL PROFILES SHEET NO. 87 COUNTY: ONEIDA IT IS A VIOLATION OF LAW FOR ANY PERSON, UNLESS THEY ARE ACTING UNDER THE DIRECTION OF A LICENSED PROFESSIONAL ENGINEER, ARCHITECT, LANDSCAPE ARCHITECT, OR LAND SURVEYOR, TO ALTER AN ITEM IN ANY WAY. IF AN ITEM BEARING THE STAMP OF A LICENSED PROFESSIONAL IS ALTERED, THE ALTERING ENGINEER, ARCHITECT, LANDSCAPE ARCHITECT, OR LAND SURVEYOR SHALL STAMP THE DOCUMENT AND INCLUDE THE NOTATION "ALTERED BY" FOLLOWED BY THEIR SIGNATURE, THE DATE OF SUCH ALTERATION, AND A SPECIFIC DESCRIPTION OF THE ALTERATION. 80 Wolf Road, Suite 600 CITY OF ROME Albany, NY 12205 518.453.9431 GPINET EXPIRATION: 10/31/2025

EXPIRATION: 10/31/2025

WINGWALL DATA GEOTECHNICAL DESIGN DATA LOCATION | ELEVATION A | ELEVATION B | ELEVATION C | DIMENSION "X" STRENGTH LIMIT STATE LIMIT STATE WINGWALL 1 SE RETAINING WALL - SEE DWGS WLMRT-01 & CLMRT-05 SERVICE COEFFICIENT OF SOIL UNIT WEIGH WINGWALL 2 SW RETAINING WALL - SEE DWGS WLMRT-01 & CLMRT-05
WINGWALL 3 NE RETAINING WALL - SEE DWGS WLMRT-01 & CLMRT-05 STATE RESISTANCE FACTOR FOR SLIDING RESISTANCE FACTOR RETAINED BY THE FRICTION OUNDATION NORTH RESISTANCE (lb/ft²) FOR BEARING WINGWALL 4 NW RETAINING WALL - SEE DWGS WLMRT-01 & CLMRT-05 (DEGREES) SLIDING (DEGREES DIMENSION "X" MEASURED ALONG FRONT FACE OF WINGWALL. ***SEE DWG CUL15-02 FOR GEOTECHNICAL DESIGN INFORMATION*** ALL ELEVATIONS SHOWN ARE IN FEET. ASSUMED FILL TYPE RETAINING WALL FOOTING UNIT (TYP) SEE NOTE 3 FACE OF BOX BEAM GUIDE RAILING SEE DWG PLMRT-01 -S3x5.7 POST FOR BOX BEAM GUIDE RAILING (TYP) CAST-IN-PLACE CONCRETE HEADWALL THEORETICAL SHOULDER BREAK LINE (TYP) STRUCTURE JOINT (TYP)
SEE NOTE 1 COST INCLUDED UNDER ITEM 603.64140915 (TYP) SOUTHWEST (SW) RETAINING WALL SEE DWG WLMRT-01 FOR PROFILE AND PAY ITEMS NORTHWEST (NW) RETAINING WALL SEE DWG WLMRT-01 FOR PROFILE 78'-0" STRUCTURE LENGTH - STATION EQUALITY STA 150+28.73 = STA M 4+99.80 2'-0" (TYP) NW RETAINING WALL TO BE CONSTRUCTED DURING WORK ZONE TRAFFIC CONTROL PHASE 3 STRUCTURE ENDS STA M 5+36.00 STRUCTURE OPENING BEGINS STA 150+18.86 - PROPOSED MAJOR (1.0') CONTOUR (TYP) 4 00°00'00 04°19′30.1" AZ=357°23'37.7" M 5+00 FACE OF RETAINING WALL-AT FINISHED GRADE (TYP) .20°00'00" رو^{رگار} 45°00′00' THIS POST TO BE SHORTENED BY 6" SEE NOTE 2-STRUCTURE BEGINS
STA M 4+58.00 CUITE PAIR POST S. PROPOSED MINOR 63.9 (0.1') CONTOUR (TYP) 14'-0" X 9'-0" PRECAST CONCRETE BOX CULVERT ITEM 603.64140915 -STRUCTURE SACING Tro, OPENING ENDS STA 150+38.61 PEDESTRIAN TUNNEL DESIGN DATA CLEAR SPAN, ft. 14.0 CAST-IN-PLACE CLOSURE POUR ITEM 555.97130016 (TYP) SEE DETAILS, DWG CLMRT-06 STRUCTURE RISE, ft. 9.0 2.7 * MIN. FILL HEIGHT, ft. SOUTHEAST (SE) RETAINING WALL SEE DWG WLMRT-01 FOR PROFILE AND PAY ITEMS * MAX. FILL HEIGHT, ft. 4.8 SKEW ANGLE 1 TO C OF ROADWAY, DEG. 44°51′27.7" HL93 W/ LRFD INV. FACTOR ≥1.2 LIVE LOAD NORTHEAST (NE) RETAINING WALL
SEE DWG WLMRT-01 FOR
PROFILE AND PAY ITEMS RAILING / BARRIER TEST LEVEL * BASED ON ASSUMED TOP SLAB THICKNESS OF 1'-0". MEASURED FROM THE TOP OF THE TOP SLAB TO THE TOP OF PAVEMENT. STRUCTURE PLAN VIEW SCALE AS SHOWN LOAD RATING (LFD) INVENTORY OPERATING HS LRFR RATING FACTORS INVENTORY HL-93 OPERATING HL-93 NOTES: PEDESTRIAN TUNNEL, NE, SW, AND SE RETAINING WALLS ARE TO BE CONSTRUCTED WHILE ON-SITE DETOUR (WZTC PHASE 2) IS IN PLACE. NW RETAINING WALL AND ELECTRICAL UTILITY CONNECTION TO BE INSTALLED DURING WZTC PHASE 3. TRAIL AND TUNNEL LIGHTING TO BE INSTALLED DURING WZTC PHASE 3 AND / OR FOLLOWING THE LENGTH OF EACH CULVERT SEGMENT SHALL BE DETERMINED BY THE CONTRACTOR. AFFIX SEAL: GREENMAN - PEDERSEN, INC ON: JUNE 23, 2025 ALTERED BY: GREENMAN - PEDERSEN, INC MODIFIED BOX BEAM GUIDE RAILING POST EMBEDMENT TO BE PER DETAIL 3-A, NYSDOT HDM CHAPTER 10, APPENDIX B, FIGURE 10B-7. SHOULD CONDITIONS REQUIRE MULTIPLE POSTS TO BE SHORTENED, DETAIL 3-B OR 3-F SHALL BE USED INSTEAD DEPENDING ON RE-OPENING OF NY46 MAINLINE TO TRAFFIC. SEE LDMRT AND LPMRT DWGS FOR TUNNEL LIGHTING DETAILS. THE FILL TYPE RETAINING WALL FOOTING BLOCKS SHOWN ARE INCLUDED FOR ILLUSTRATIVE PURPOSES ONLY. THE CONTRACTOR SHALL BE RESPONSIBLE FOR THE DETAILED DESIGN OF THE FILL TYPE RETAINING WALLS. AS-BUILT REVISIONS DESCRIPTION OF ALTERATIONS: CUL VERTS C270026 C260199 PIN 2650.61 / 2LC1.31 BRIDGES MOHAWK RIVER TRAIL ALL DIMENSIONS IN ft UNLESS OTHERWISE NOTED CONTRACT NUMBER D265553 PHASE 3 UTILQLVL C CITY OF ROME SITE 15 - MRT (PIN 2650.61)

COUNTY: ONEIDA

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DRAWING NO. CLMRT-01

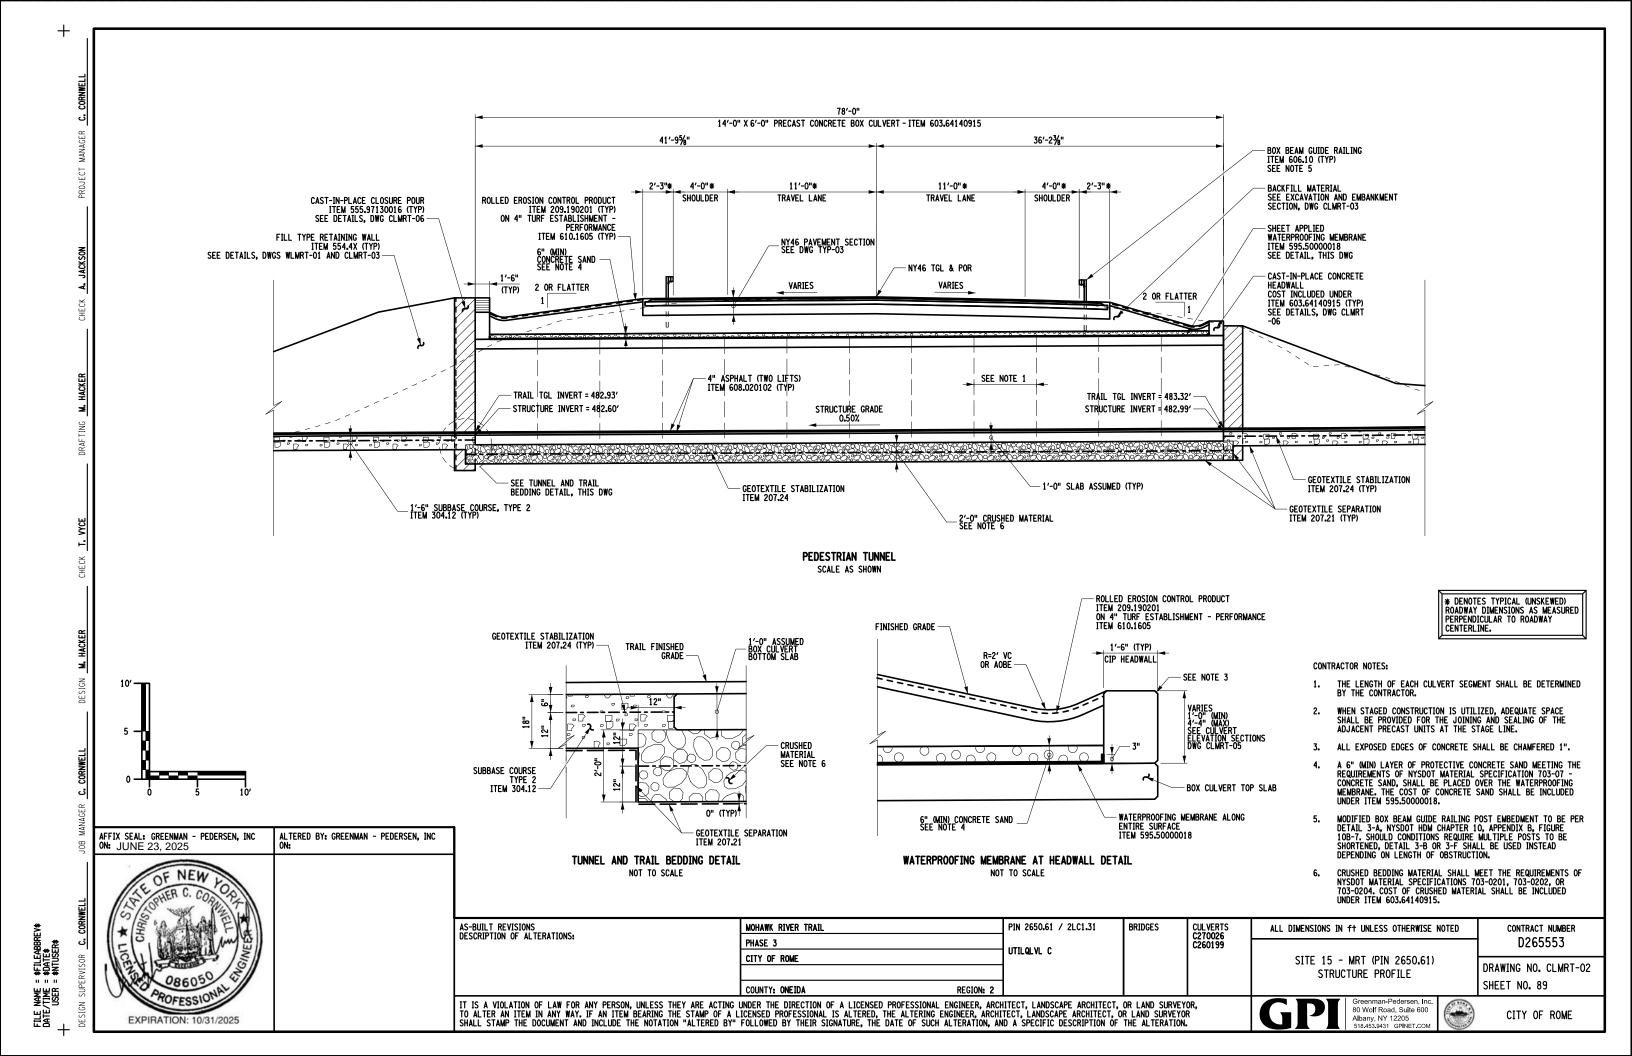
CITY OF ROME

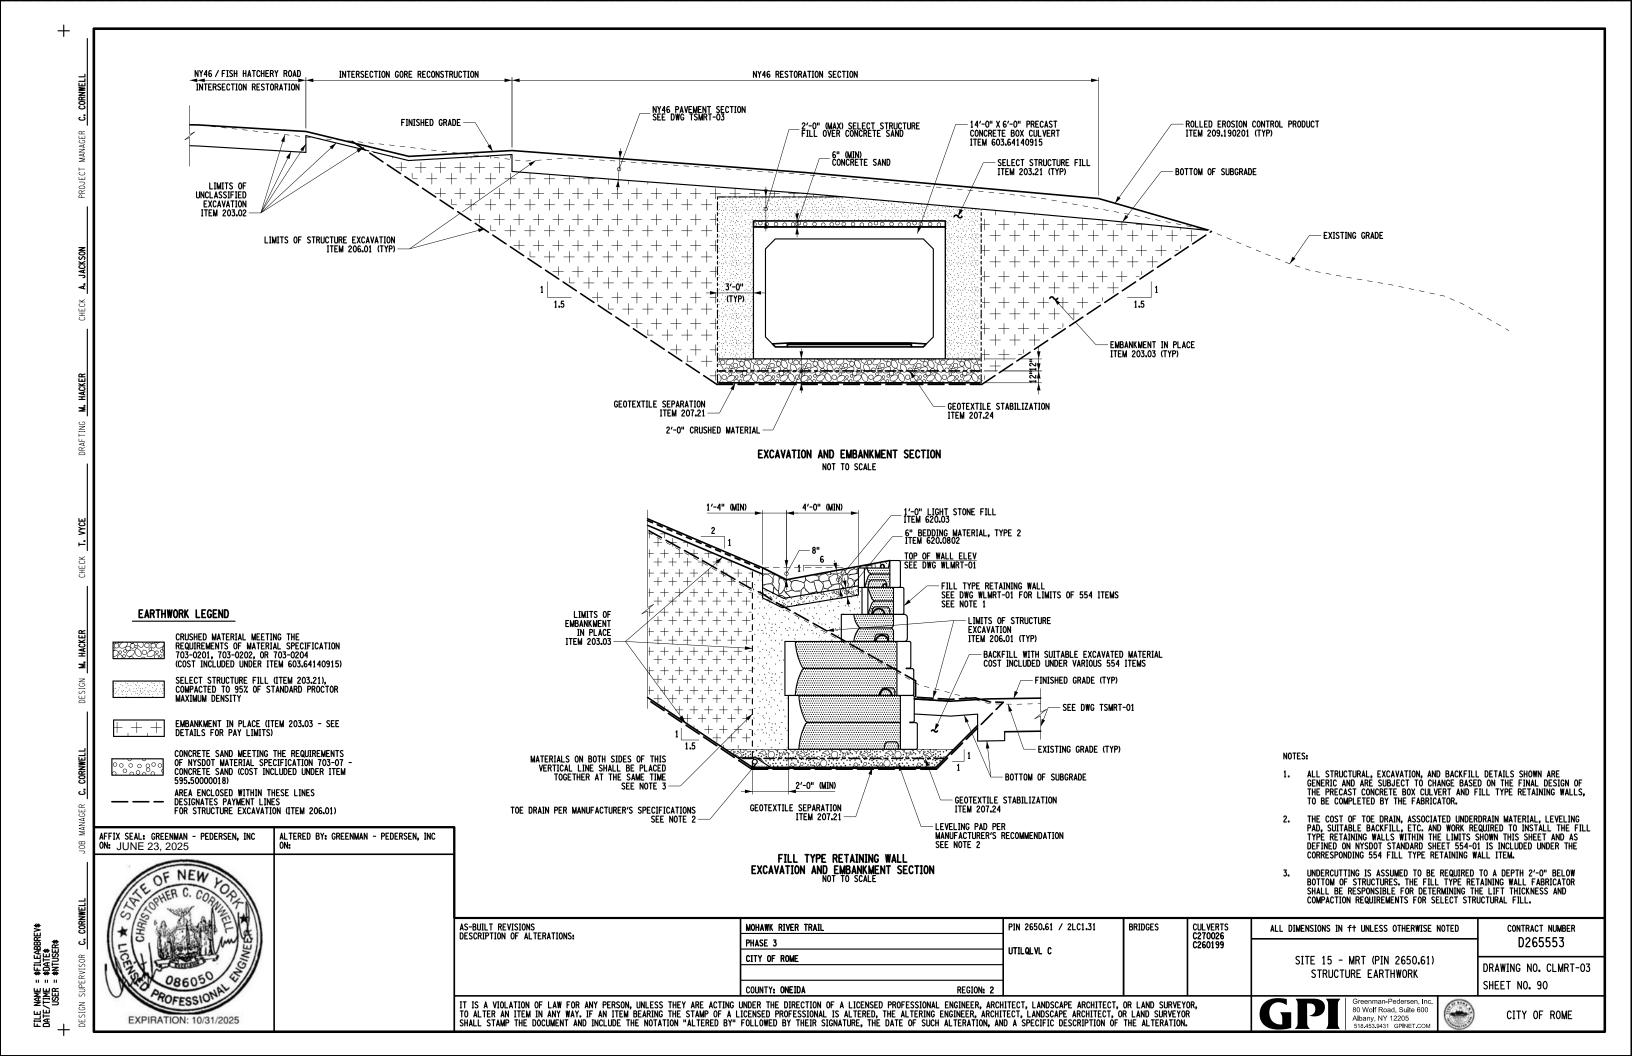
SHEET NO. 88

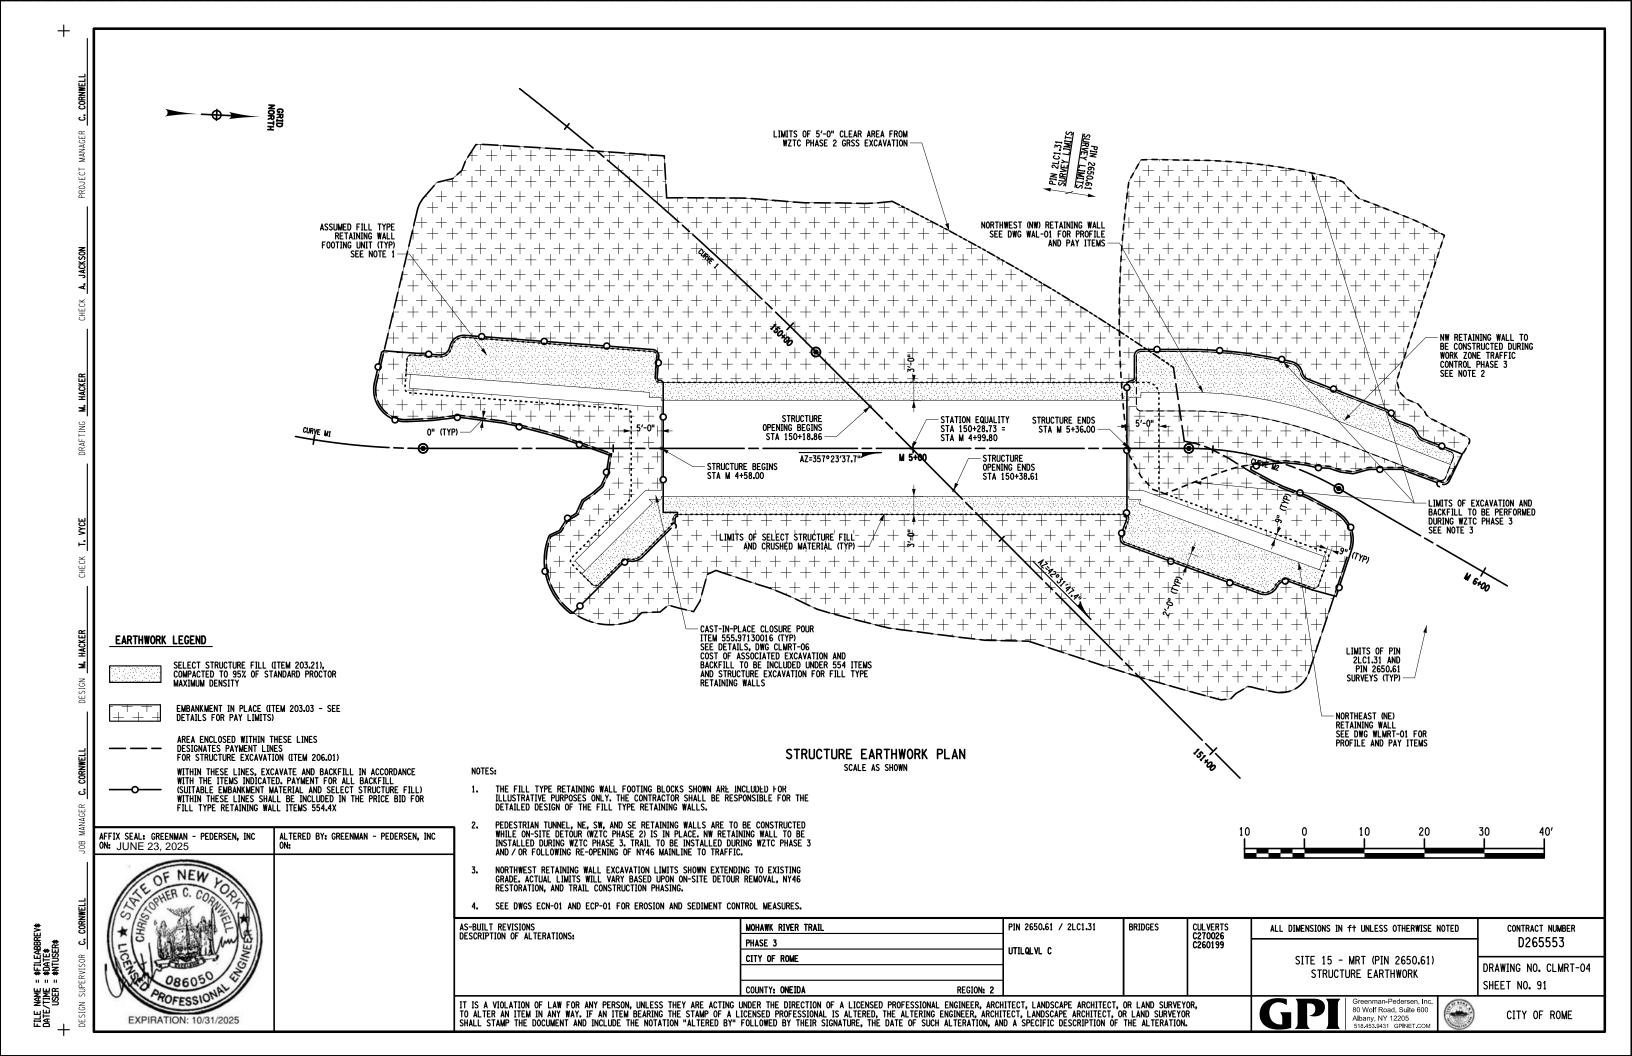
STRUCTURE PLAN

80 Wolf Road, Suite 600

Albany, NY 12205 518.453.9431 GPINET







EXPIRATION: 10/31/2025

LOCATION

SOUTHEAST WALL

SOUTHWEST WALL

NORTHEAST WALL

NORTHWEST WALL

AFFIX SEAL: GREENMAN - PEDERSEN, INC ON: JUNE 23, 2025

ELEVATION B

481.60'

481.60'

481.99'

481.99'

CLOSURE POUR DATA

494.00'

ALTERED BY: GREENMAN - PEDERSEN, INC

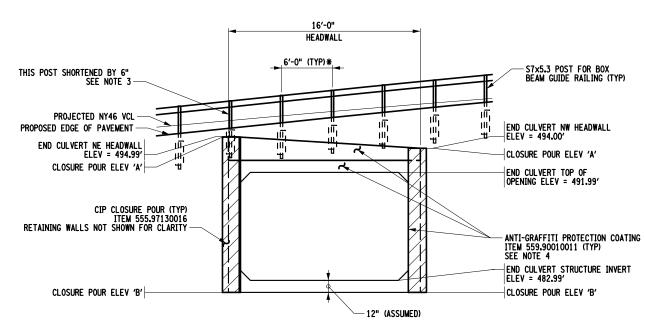
AS-BUILT REVISIONS DESCRIPTION OF ALTERATIONS:

6'-0" (TYP)* PROJECTED NY46 VCL PROPOSED EDGE OF PAVEMENT S7x5.3 POST FOR BOX BEAM GUIDE RAILING (TYP) END CULVERT SW HEADWALL ELEV = 496.92 BEGIN CULVERT SE HEADWALL ELEV = 493.93' CLOSURE POUR ELEV 'A' CLOSURE POUR ELEV 'A' BEGIN CULVERT TOP OF OPENING ELEV = 491.60' CIP CLOSURE POUR (TYP) ITEM 555.97130016 RETAINING WALLS NOT SHOWN FOR CLARITY - ANTI-GRAFFITI PROTECTION COATING ITEM 559.90010011 (TYP) SEE NOTE 4 BEGIN CULVERT STRUCTURE INVERT CLOSURE POUR ELEV 'B' CLOSURE POUR ELEV 'B' 12" (ASSUMED) **BEGIN CULVERT ELEVATION**

16'-0" HEADWALL

SOUTH TRAIL APPROACH

NOT TO SCALE



END CULVERT ELEVATION NORTH TRAIL APPROACH NOT TO SCALE

> * DENOTES TYPICAL (UNSKEWED) ROADWAY DIMENSIONS AS MEASURED PARALLEL TO ROADWAY CENTERLINE.

BRIDGES

PIN 2650.61 / 2LC1.31

UTILQLVL C

CULVERTS C270026 C260199

- CLOSURE POUR ELEVATIONS 'A' AND 'B' ARE DEPENDENT UPON FINAL RETAINING WALL DESIGN BY FABRICATOR. ELEVATION 'A' SHALL ALLOW FOR A SMOOTH INTERFACE BETWEEN CULVERT HEADWALL. ELEVATION 'B' SHALL MATCH THE BOTTOM OF THE ADJACENT FILL TYPE RETAINING
- THE CONTRACTOR SHALL COMPLETE THE CLOSURE POUR DESIGN ELEVATION TABLE THIS DWG FOLLOWING POUR PLACEMENT.
- MODIFIED BOX BEAM GUIDE RAILING POST EMBEDMENT TO BE PER DETAIL 3-A, NYSDOT HDM CHAPTER 10, APPENDIX B, FIGURE 10B-7. SHOULD CONDITIONS REQUIRE MULTIPLE POSTS TO BE SHORTENED, DETAIL 3-B OR 3-F SHALL BE USED INSTEAD DEPENDING ON LENGTH OF OBSTRUCTION.
- FOLLOWING INSTALLATION OF CONCRETE BOX CULVERT AND CIP CLOSURE POURS (INCLUDING ALLOWING CLOSURE POURS TO CURE), AND TRAIL PAVING WITHIN THE BOX CULVERT, ALL EXPOSED CONCRETE SURFACES OF CULVERT AND CLOSURE POURS SHALL BE TREATED WITH ITEM 559,90010011 ANTI-GRAFFITI PROTECTION COATING. ITEM 559.90010011 SHALL BE:

ALL DIMENSIONS IN ft UNLESS OTHERWISE NOTED

- THEM 559,90010011 SHALL BE:

 ONE COMPONENT

 BRIGHT WHITE-COLORED

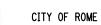
 NON-SACRIFICIAL (PERMANENT)

 TESTED ACCORDING TO ASTM D7089 AND CAPABLE OF ACHIEVING A RATING OF "CLEANABILITY LEVEL 1" AFTER CLEANING

 APPLIED ACCORDING TO MANUFACTURER'S INSTRUCTIONS
 ALL ADDITIONAL PROVISIONS OF ITEM 559,90010011 SHALL APPLY.

D265553 SITE 15 - MRT (PIN 2650.61) DRAWING NO. CLMRT-05 STRUCTURE ELEVATION

80 Wolf Road, Suite 600 Albany, NY 12205 518.453.9431 GPINET



SHEET NO. 92


CONTRACT NUMBER

COUNTY: ONEIDA IT IS A VIOLATION OF LAW FOR ANY PERSON, UNLESS THEY ARE ACTING UNDER THE DIRECTION OF A LICENSED PROFESSIONAL ENGINEER, ARCHITECT, LANDSCAPE ARCHITECT, OR LAND SURVEYOR, TO ALTER AN ITEM IN ANY WAY. IF AN ITEM BEARING THE STAMP OF A LICENSED PROFESSIONAL IS ALTERED, THE ALTERING ENGINEER, ARCHITECT, LANDSCAPE ARCHITECT, OR LAND SURVEYOR SHALL STAMP THE DOCUMENT AND INCLUDE THE NOTATION "ALTERED BY" FOLLOWED BY THEIR SIGNATURE, THE DATE OF SUCH ALTERATION, AND A SPECIFIC DESCRIPTION OF THE ALTERATION.

MOHAWK RIVER TRAIL

PHASE 3

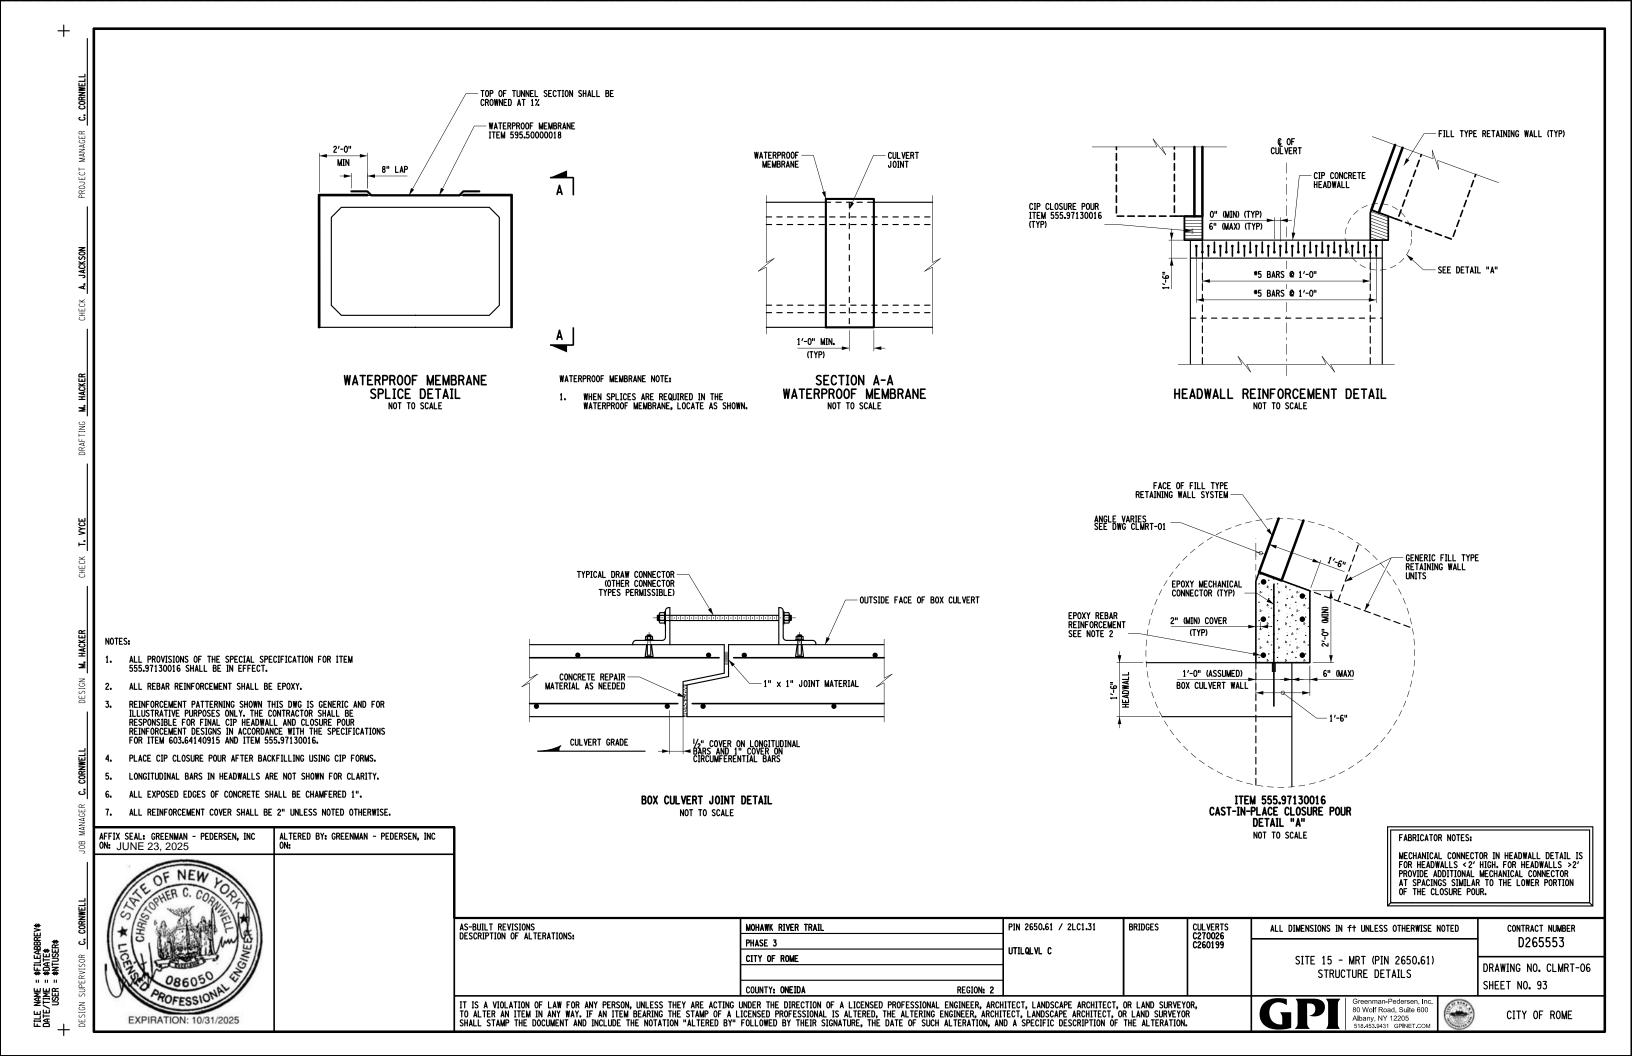CITY OF ROME



CONDUIT SIZE AND TYPE (AS SHOWN ON PLANS) - CONDUCTORS TO LIGHTING SYSTEM (AS SHOWN ON PLANS) SERVICE CABLES PER -POWER COMPANY REQUIREMENTS - CONCRETE CONDUIT FASTENERS (4'-0" MAX SPACING) CONCRETE FOUNDATION FOR CABINET, ITEM 680.40220008 24" SQUARE - GROUND ROD PER N.E.C. SURFACE-MOUNTED, LOW PROFILE, IMPACT RESISTANT LED LUMINAIRE (4" CLEARANCE TO TOP OF WALL) SPLICE BOX - SPLICE BOX POWER SERVICE CABINET DETAIL NOT TO SCALE 1" GALVANIZED STEEL SURFACE-MOUNTED CONDUIT " = = = = = = TO PULLBOX AFFIX SEAL: GREENMAN - PEDERSEN, INC ON: JUNE 23, 2025 ALTERED BY: GREENMAN - PEDERSEN, INC ON: SURFACE-MOUNTED CONDUIT INSTALLATION DETAIL ISOMETRIC VIEW
NOT TO SCALE AS-BUILT REVISIONS DESCRIPTION OF ALTERATIONS: CULVERTS C270026 C260199 PIN 2650.61 / 2LC1.31 MOHAWK RIVER TRAIL BRIDGES CONTRACT NUMBER ALL DIMENSIONS IN ft UNLESS OTHERWISE NOTED D265553 PHASE 3 UTILQLVL C CITY OF ROME SITE 15 - MRT (PIN 2650.61) DRAWING NO. LDMRT-01 LIGHTING DETAILS SHEET NO. 94 COUNTY: ONEIDA IT IS A VIOLATION OF LAW FOR ANY PERSON, UNLESS THEY ARE ACTING UNDER THE DIRECTION OF A LICENSED PROFESSIONAL ENGINEER, ARCHITECT, LANDSCAPE ARCHITECT, OR LAND SURVEYOR, TO ALTER AN ITEM IN ANY WAY. IF AN ITEM BEARING THE STAMP OF A LICENSED PROFESSIONAL IS ALTERED, THE ALTERING ENGINEER, ARCHITECT, LANDSCAPE ARCHITECT, OR LAND SURVEYOR SHALL STAMP THE DOCUMENT AND INCLUDE THE NOTATION "ALTERED BY" FOLLOWED BY THEIR SIGNATURE, THE DATE OF SUCH ALTERATION, AND A SPECIFIC DESCRIPTION OF THE ALTERATION. Greenman-Pedersen, Inc. 80 Wolf Road, Suite 600 Albany, NY 12205 518.453.9431 GPINET.COM CITY OF ROME EXPIRATION: 10/31/2025

SECTION

METER SOCKET

FINISHED GRADE

- 100A, 120/240V METERED POWER SERVICE/LOAD CENTER PEDESTAL, MILLBANK MANUFACTURING (MODEL CP3B OR APPROVED EQUAL) ITEM 670.42000002

- CONTINUOUS *4 SOFT DRAWN BARE COPPER GROUND WIRE CONNECTING TWO (2) GROUND RODS TO GROUND LUG IN PEDESTAL

MUNICIPAL ACCESS DOOR TO CIRCUIT BREAKERS W/ PADLOCK BRACKET EXTENDING THROUGH DOOR

- FOUR (4) 5/8-11 X 18" ZINC-PLATED ANCHOR BOLTS, SPACING PER MANUFACTURER'S SPECIFICATIONS

HINGED METER SECTION COVER

UTILITY SIDE ACCESS DOOR-

34" CHAMFER (TYP)

